


Zeidenberg / Record Residence Interior Remodeling 16 Holt Street, Belmont, Massachusetts 02478

Assessor's Map 28 - Parcel 11

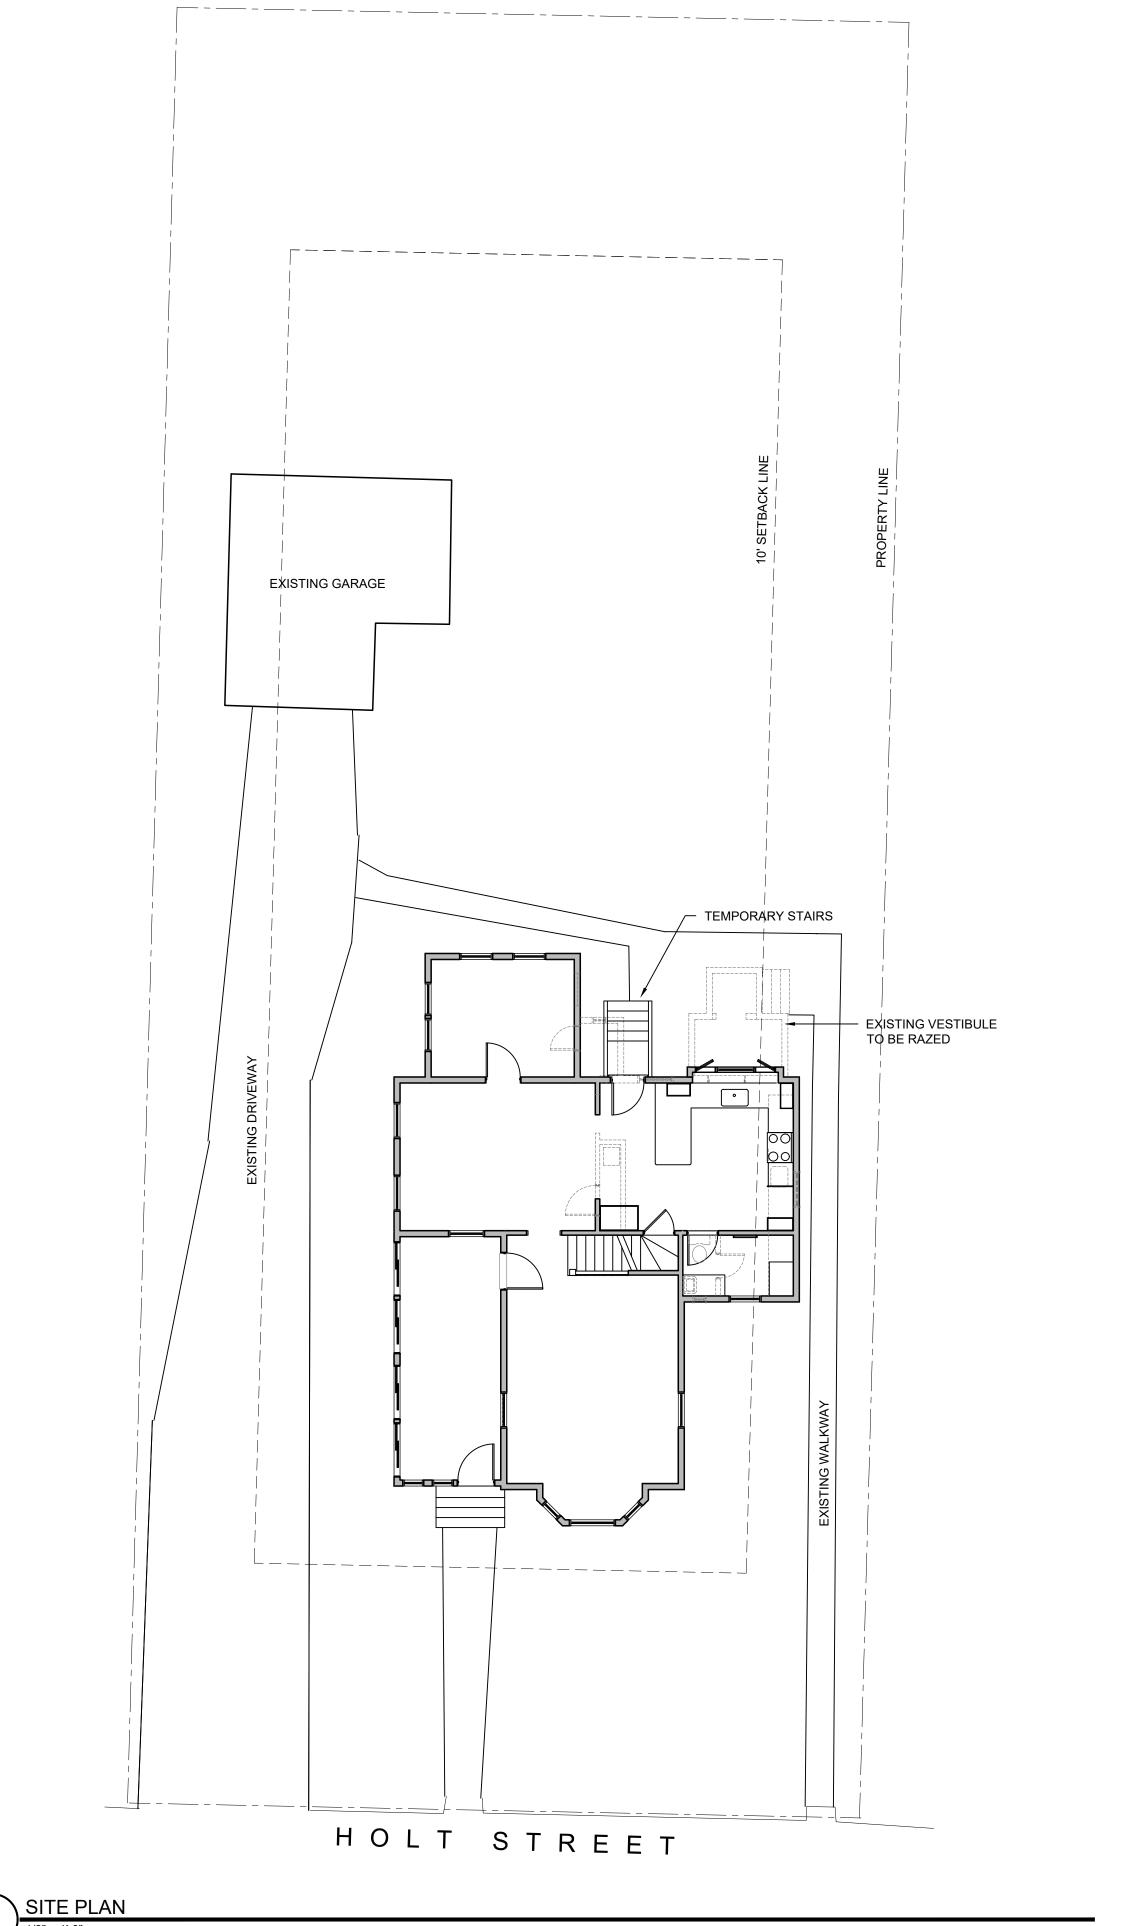

LIST OF DRAWINGS

X-101 SITE PLAN, LOCUS PLAN, SURVEY PLAN

A-101 FLOOR PLANS

A-201 EXISTING AND PROPOSED EXTERIOR ELEVATIONS

A-202 EXISTING AND PROPOSED EXTERIOR ELEVATIONS

E-101 LIGHTING / ELECTRICAL PLANS & PROJECT SPECIFICATIONS

GENERAL NOTES

1. These drawings and the designs, ideas, and arrangements represented herein are and shall remain the property of the Architect. These drawings shall not be copied, disclosed to others, or used in connection with any work or project other than the specified project for which they have been prepared, without the prior written consent of the Architect.

2. Dimensions are to finish face of wall or to centerline of window or door, unless otherwise indicated. Dimensions pertaining to built-in cabinets, fixtures, accessories, and the like are typically to finish face of wall and finish face of cabinets or centerline of fixture or accessory, unless otherwise indicated. Foundation dimensions are to face of concrete. Exterior dimensions are to face of stud which is assumed to align with face of concrete at foundation walls. Exterior finish face of wall is assumed to be 1 ¼ from face of concrete or face of stud.

3. All construction shall conform to the requirements of the "Commonwealth of Massachusetts State Building Code", latest edition, the Stretch Code, NFPA, the National Electrical Code, latest edition, to all other applicable codes, and to the requirements of regulatory agencies including the local fire department.

 Field-verify all dimensions and existing conditions.
 Notify Architect of discrepancies prior to commencing or continuing work.

 Written dimensions shall have precedence over scaled dimensions. Due to possible distortions in the drawings caused by reproduction processes, use care when scaling drawings.

6. Details and larger-scale drawings shall have precedence over general drawings.

7. All changes and deviations from the drawings shall be done in consultation with the Architect.

NO. REVISION DATE



Carl C. Oldenburg AIA Architect

1666 Massachusetts Avenue

Lexington, MA 02420

ECT IDENBERG

ZEIDENBERG / RECORD RESIDENCE: INTERIOR REMODELING

Belmont, Massachusetts 02478

TITLE


SITE PLAN, LOCUS PLAN, SURVEY PLAN

DATE
11/12/2022


SCALE
AS NOTED

PROJECT NO.
1920.01

PROGRESS DRAWINGS -- NOT FOR CONSTRUCTION OR PERMIT PROGRESS

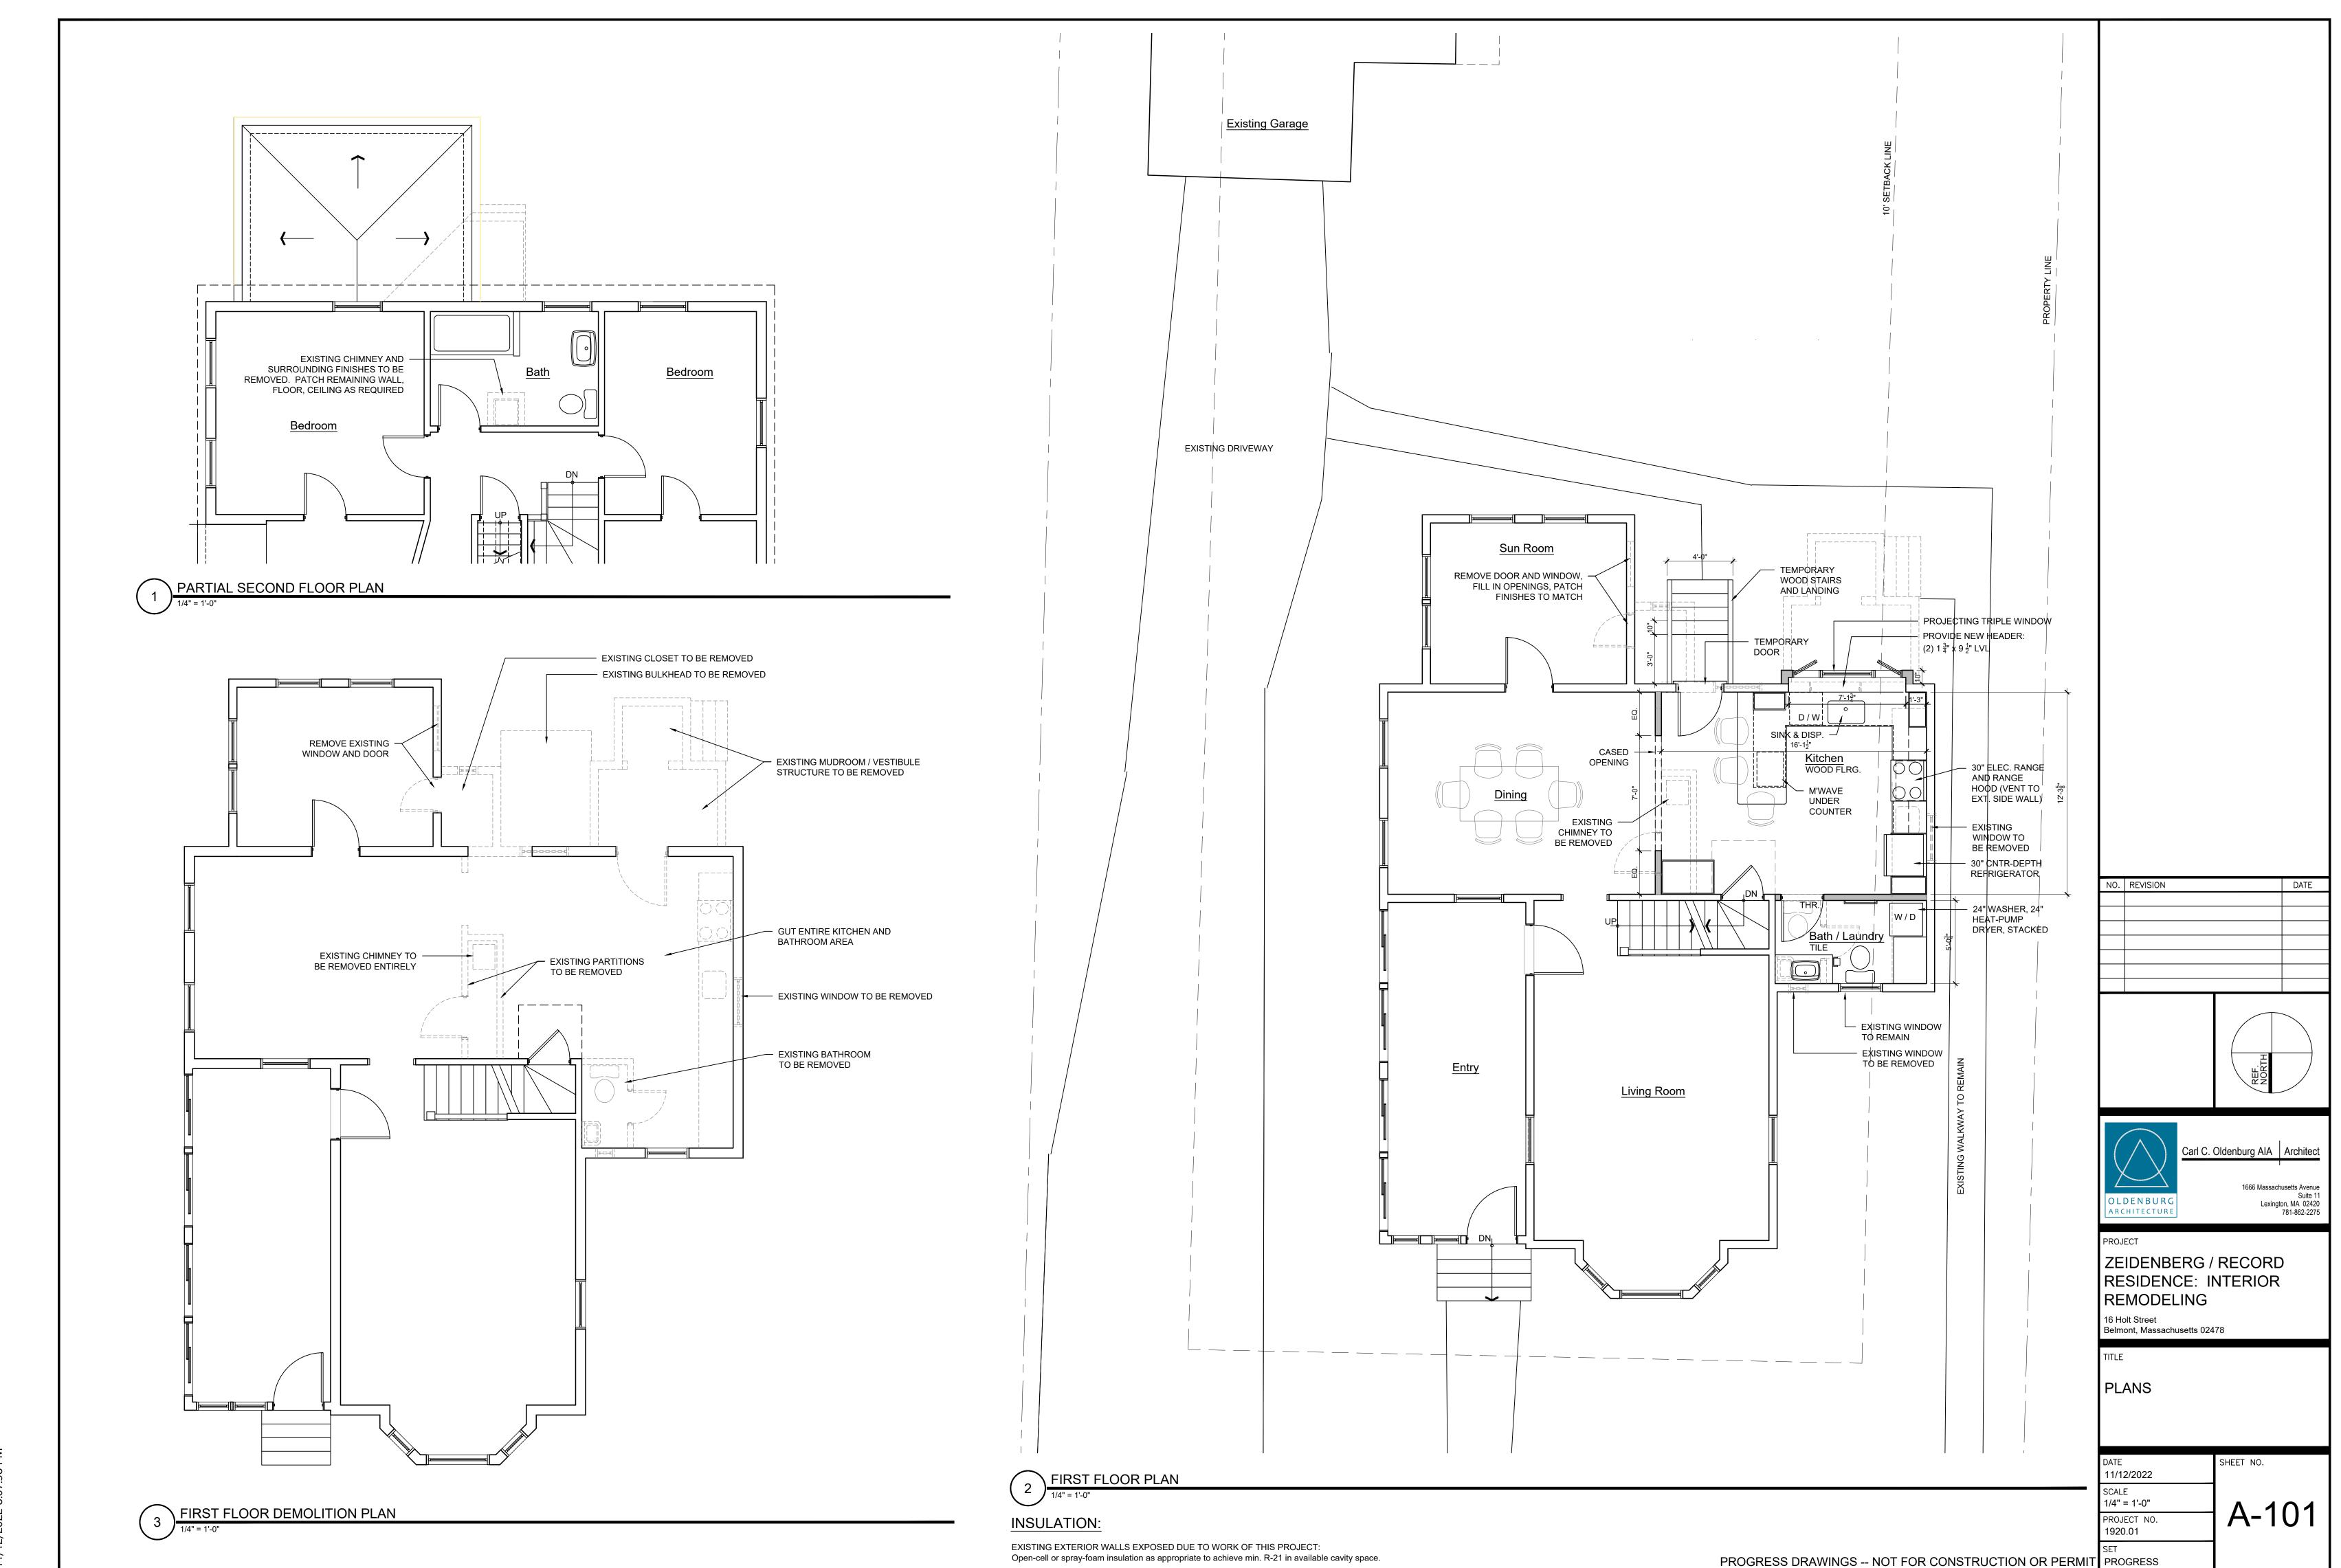

11/12/2022 8:07:38 PM

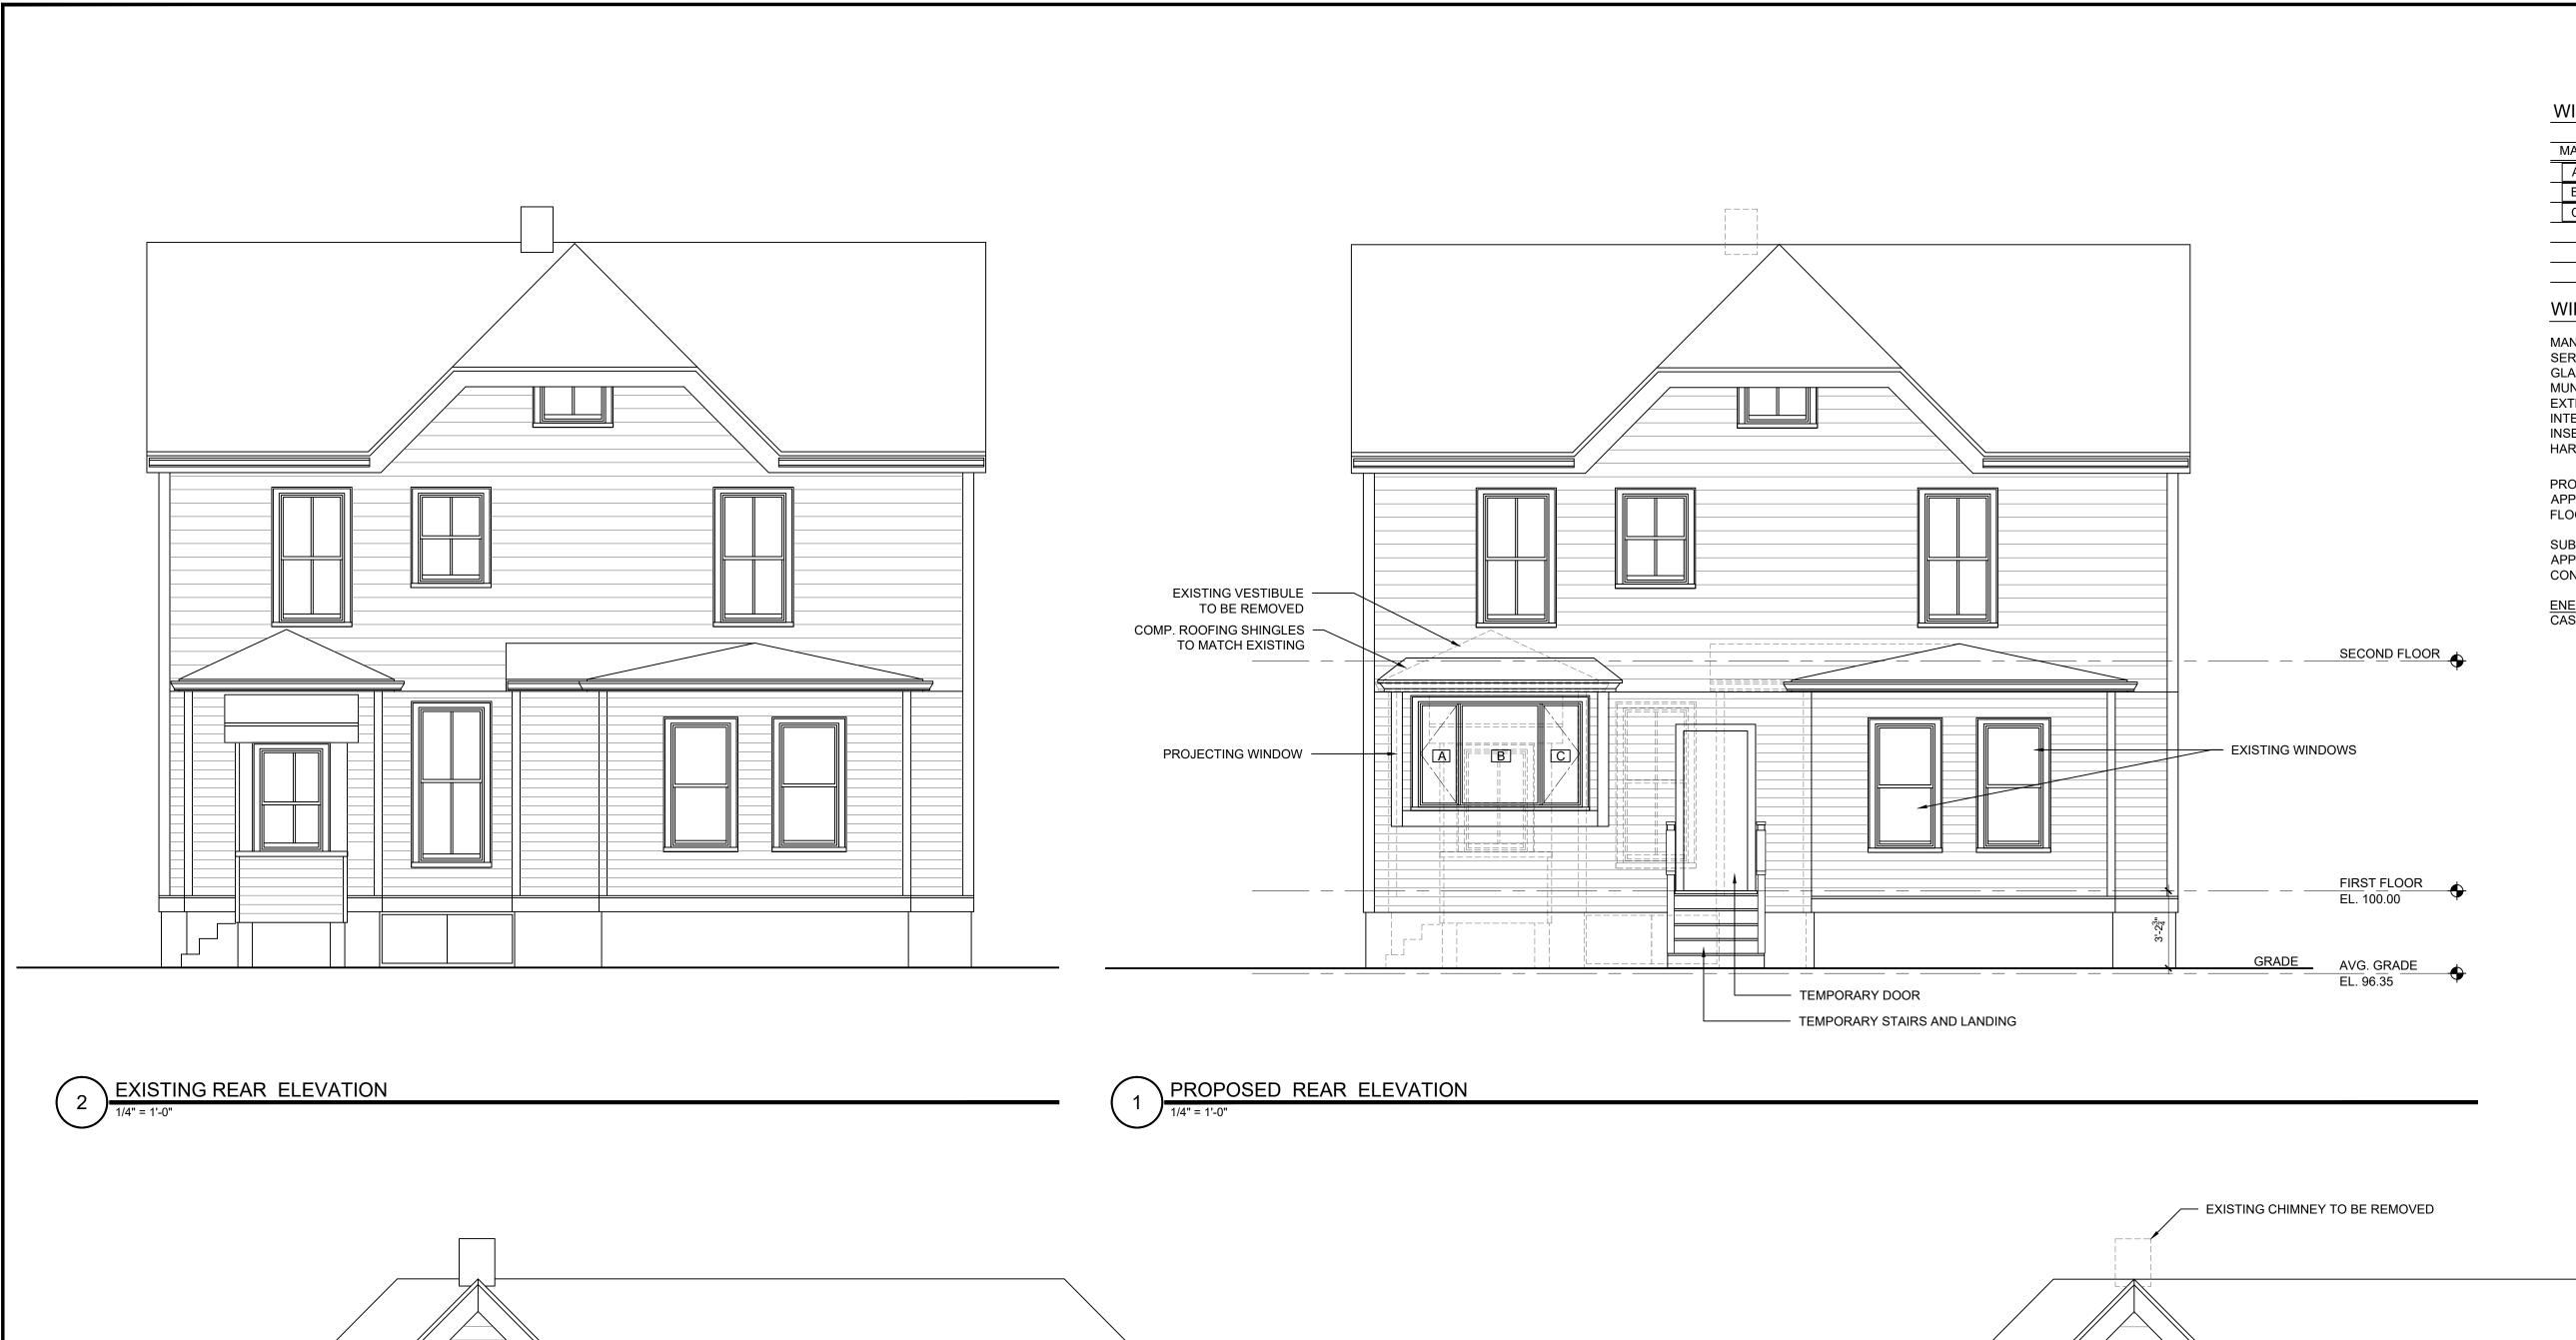

WINDOW SCHEDULE UNIT SIZE MARK OPERATION SIZE CODE WIDTH HEIGHT REMARKS

A CASEMENT CN145 LH 1'-8 1/2" 4'-4 13/16" B CASEMENT PICTURE P3045 2'-11 15/16" 4'-4 13/16" > MULLED CN145 RH 1'-8 1/2" 4'-4 13/16" C CASEMENT

WINDOW SPECIFICATIONS:

MANUFACTURER: ANDERSEN SERIES: LOW-E4 SMARTSUN NONE GLAZING: MUNTINS: EXTERIOR COLOR: WHITE PRIMED WOOD INTERIOR:

INSECT SCREENS: VIVID-VIEW HARDWARE COLOR: SATIN NICKEL (CONFIRM WITH OWNER)

PROVIDE TEMPERED GLASS AT ALL WINDOWS WHERE REQUIRED BY APPLICABLE CODES, INCLUDING WHERE GLASS IS LESS THAN 18" ABOVE THE FLOOR AND WHERE WINDOW IS ADJACENT TO TUBS, BENCHES, AND DOORS.

SUBMIT COPY OF WINDOW ORDER TO ARCHITECT FOR REVIEW AND APPROVAL PRIOR TO ORDERING. CONFIRM ALL SPECIFICATIONS WITH OWNER AND/OR ARCHITECT.


ENERGY PERFORMANCE:
CASEMENT: U = 0.28, SHGC = 0.21, VLT = 48%



4 EXISTING LEFT SIDE ELEVATION

1/4" = 1'-0"



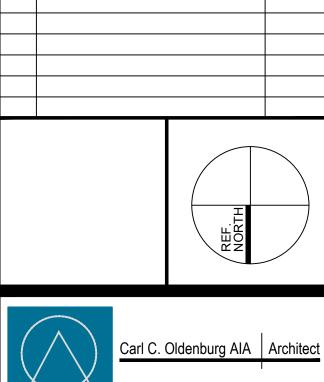

OLDENBURG ARCHITECTURE

Suite 11 Lexington, MA 02420 781-862-2275

PROJECT

ZEIDENBERG / RECORD RESIDENCE: INTERIOR REMODELING


EXISTING AND PROPOSED EXTERIOR ELEVATIONS

> SHEET NO. 11/12/2022 SCALE 1/4" = 1'-0" A-201 PROJECT NO. 1920.01

PROPOSED LEFT SIDE ELEVATION



ELECTRICAL LEGEND

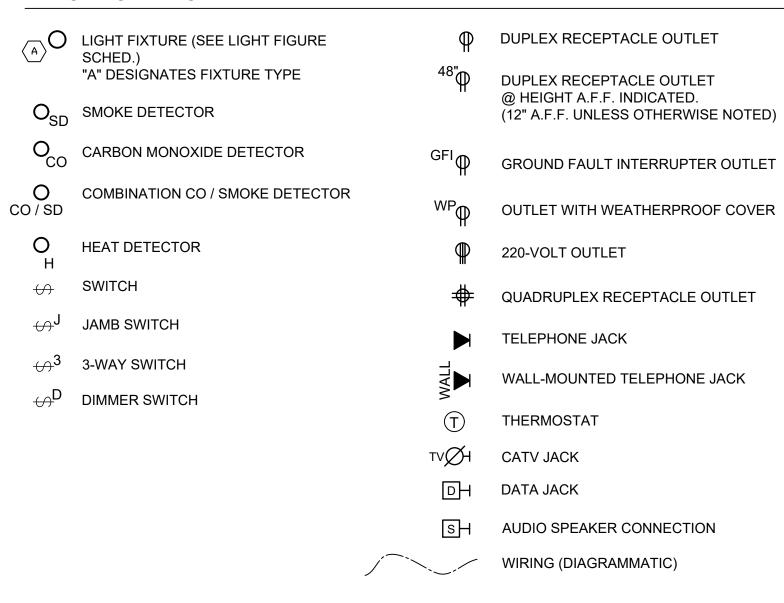

SMOKE AND CARBON MONOXIDE ALARM NOTES:

SMOKE ALARMS AND CARBON MONOXIDE ALARMS SHALL RECEIVE THEIR PRIMARY POWER FROM THE BUILDING WIRING AND SHALL BE EQUIPPED WITH BATTERY BACKUP.

Project Notes and Specifications

GENERAL PROJECT DESCRIPTION:

1. Selective demolition of small structures attached to the rear of

- 2. Remodeling of portions of the first floor of the existing house.
- 3. New kitchen to replace existing, in the same general location. 4. New projecting triple window at kitchen.

SECTION 1: GENERAL REQUIREMENTS

5. Temporary exterior door, stairs and landing.

- 1. Contractor (GC and subs) shall carry insurance appropriate for
- the nature of the project. 2. GC shall obtain the building permit and coordinate all
- 3. GC shall perform all work in accordance with state and local
- 4. GC shall keep jobsite orderly, clean and safe at all times. 5. Faulty or defective work shall be replaced at no cost to the
- 6. Additional Work or Change Orders shall be reviewed by Owner and Architect prior to order and installation.
- 7. GC shall provide dumpster or other suitable means of debris and
- construction waste disposal. 8. GC shall provide portable sanitary facilities.
- 9. Verify all dimensions and other existing conditions on site and report any discrepancies to Architect for coordination prior to commencing or continuing affected work. Do not scale the drawings for construction..
- 10. All work shown on the drawings is the responsibility of the GC unless otherwise noted.
- 11. GC is responsible for all instructions to Subcontractors.

SECTION 2: SITE WORK AND DEMOLITION

- 1. Site Work: 1.1. Plantings will be by others.
- 2. Demoltion:
- 2.1. Remove existing one-story vestibule, sunroom closet, and
- related construction as shown on drawings. 2.2. Remove portions of existing roof at existing one-story
- Sunroom.
- 2.3. Remove existing chimney for its full height. 2.4. Remove interior partitions, finishes, plumbing and electrical items, and other construction where indicated and as
- 2.5. Protect adjacent elements which are to remain.

SECTION 3: CONCRETE (Not used)

SECTION 4: MASONRY

1. (Not used)

SECTION 5: METALS 1. (Not Used)

SECTION 6: WOOD AND PLASTICS 1. Rough Carpentry:

- 1.1. Wall framing: 2x4 SPF wall studs @ 16" o.c.
- 1.2. See framing plans for other framing sizes and configurations.
- pressure-treated. 1.4. Provide solid blocking in walls for cabinets, shelving, stair wall rails, bath accessories, shower curtain rods, grab bars

1.3. Framing wood in contact with concrete shall be

(including future grab bars where directed by Owner), and other locations as required.

2. Exterior finish carpentry:

- 2.1. New exterior siding shall match existing. 2.2. Exterior door and window trim shall be "Azek" or similar composite material, configured to match existing door and
- window trim. 3. Interior finish carpentry 3.1. Provide interior trim including door and window casing, and
- 3.2. Interior trim shall be suitable wood for painted finish. Match existing profiles at first floor of house.

SECTION 7 - THERMAL AND MOISTURE CONTROL

insulation in new wall at first-floor bathroom.

- 1. Thermal Insulation: See notes on drawings. 2. Acoustic insulation: Provide "Roxsol" or similar acoustic
- - 3. Roofing: 3.1. Provide 30-year architectural shingles to match existing for
 - new roofs.
 - 4. Metal flashing and drip edge: 4.1. White aluminum.

SECTION 8 - DOORS AND WINDOWS

- 1. Provide interior doors as shown on drawings. Wood, for painted finish, to match existing.
- 1.1. Interior door hardware:
- 1.1.1. Provide privacy locksets at bathroom door.
- 1.1.2. Provide passage sets at other new hinged interior doors. 1.1.3. Interior door hardware shall match existing.
- 2. See Window Schedule on drawings for new windows.

SECTION 9 - FINISHES

- 1. Interior walls and ceilings: 1/2" "Blueboard" G.W.B. and plaster, smooth finish on all new wall and ceiling surfaces including inside closets.
- 2.1. Patch, match and refinish the maple flooring in the Kitchen. 2.2. Alternate: Provide price for sanding and refinishing existing wood floor throughout the first floor.
- 2.3. Provide ceramic tile where indicated. Tile to be selected by Owner. Carry an allowance of \$7 per square foot for tile
- 2.3.1. Install "Durock" underlayment at new tile floors.

3. Ceilings: 3.1. New ceilings shall be 1/2" Blueboard and skim coat plaster on 1x3 strapping on underside of existing joists.

- 4.1. Sand, patch and prep all surfaces before and between
- 4.2. Strip wallpaper in the dining room. 4.3. Paint all new and existing interior walls, ceilings, doors,

windows, trim, and other other elements within the work

- area of this project, which are exposed to view and normally intended to be painted, including the dining room. 4.4. Paint exterior trim, new exterior door, and other elements constructed or installed as part of this project which are
- exposed to view and normally intended to be painted. 4.5. Paint products and systems:
- 4.5.1. Walls and ceilings: Primer and two coats interior latex paint, satin finish, more than one color.
- 4.5.2. Wood trim, doors, etc.: Primer and two coats interior latex paint, semi-gloss finish. 4.5.3. Paint products shall be Benjamin Moore,
- Sherwin-Williams, or equal as approved by Architect. 4.5.4. Paint colors to be selected by Owner and/or Architect.

SECTION 10 - SPECIALTIES

- 1. Bath Accessories: 1.1. Bath accessories will be supplied by Owner; Contractor
- 1.2. Bath accessories shall include but not be limited to: toilet paper holder, towel bars, towel ring.

SECTION 11 - EQUIPMENT Not used


SECTION 15 - MECHANICAL

- 1. Plumbing: 1.1. Provide new heat pump domestic hot water heater to replace
- 1.1. Provide rough and finish plumbing work for Kitchen and remodeled Half- Bath / Laundry.
- 1.2. Provide bath plumbing fixtures:
- 1.2.1. Fixtures to be selected by Owner. 1.2.2. Review all plumbing fixture selections with Owner
- prior to ordering. 1.3. Insulate all new hot-water supply piping.


- 1.4. Insulate existing hot-water supply pipes where reasonably accessible.
- 2. HVAC 2.1. Provide new heat-pump HVAC system for the entire house. 2.1.1. Provide two systems, one with the air handler in the
- basement to serve the first floor, and one with the air handler in in the attic to serve the second floor. 2.1.2. Provide outdoor condenser units on stabilization pads
- in a location acceptable to the Owner and regulatory
- 2.1.3. Provide two WIFI-enabled thermostats in locations acceptable to the Owner.
- 2.2. Provide bath exhaust fan, ducted to exterior.
- 2.3. Vent new dryer exhaust to the exterior. 2.4. Vent kitchen range hood to the exterior, with a makeup air

SECTION 16 - ELECTRICAL

- 1. Upgrade house main service to 200 amps.
- 2. Provide new 60-amp sub panel in the basement below the
- 3. Provide new lighting as shown in drawings.
- 4. Provide electrical outlets as shown on drawings and as required by applicable codes. Existing outlets to remain where feasible. 5. All recessed lighting fixtures shall be supplied and installed by
- the contractor unless otherwise noted. Surface-mounted fixtures will be supplied by the Owner and shall be installed by the Contractor. See Light Fixture Schedule.
- 6. Review locations of all fixtures, devices, and switching with the Owner and/or architect in the field. Advise Architect of any conflicts with other construction in locating recessed fixtures before or during rough-in so that alternative locations of fixtures or framing can be determined.

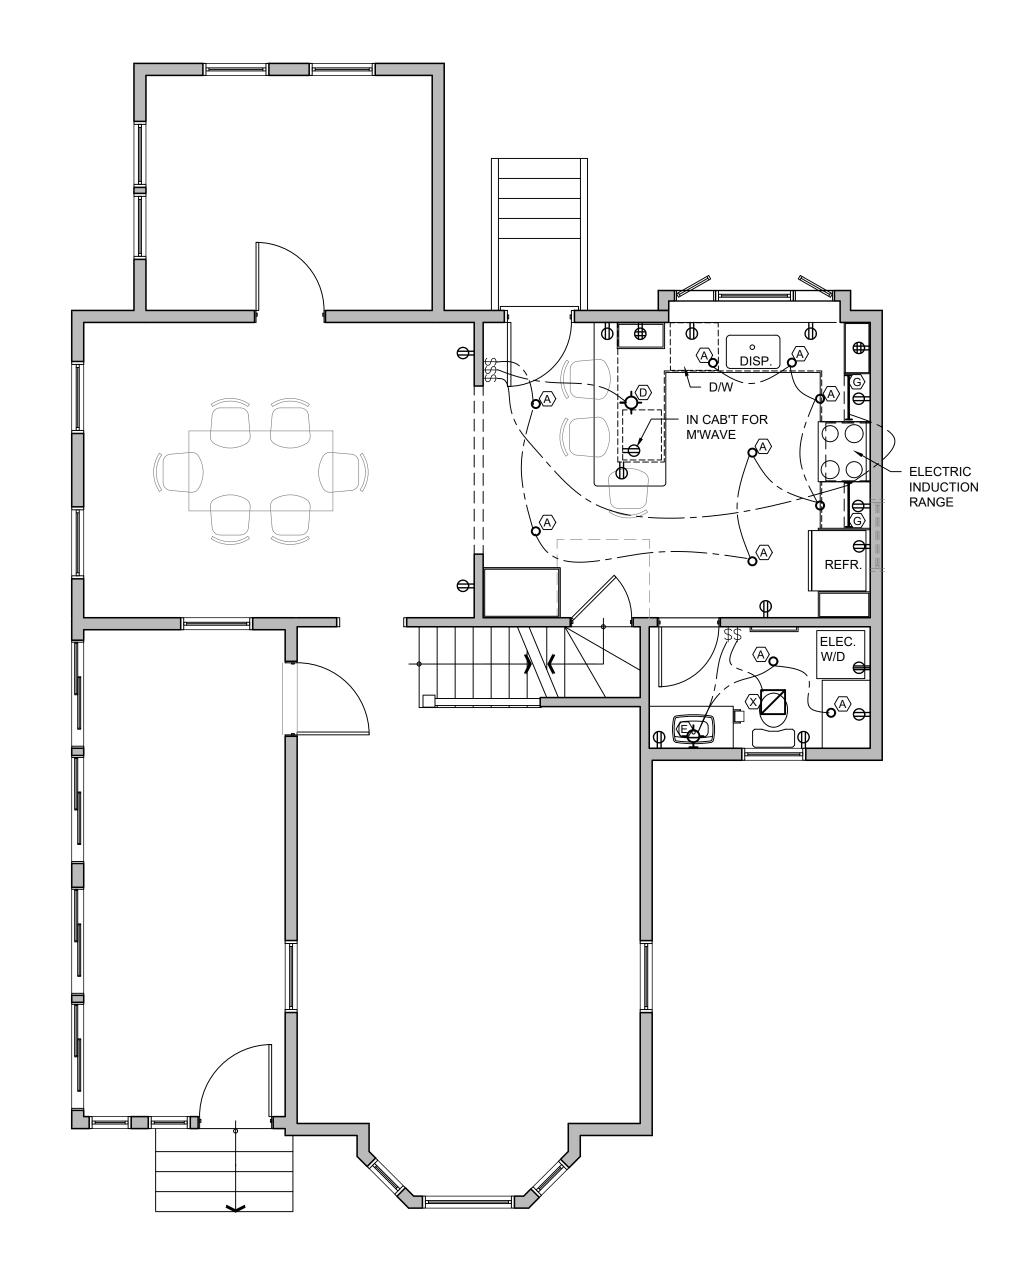

FIRST FLOOR LIGHTING / ELECTRICAL PLAN

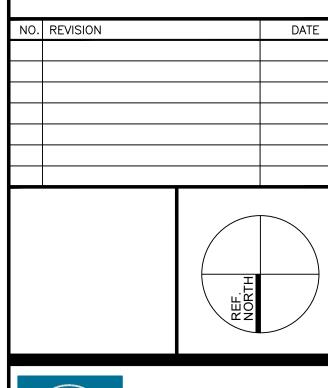

Carl C. Oldenburg AIA | Architect 1666 Massachusetts Avenue OLDENBURG Lexington, MA 02420 781-862-2275

PROJECT ZEIDENBERG / RECORD RESIDENCE: INTERIOR REMODELING 16 Holt Street

Belmont, Massachusetts 02478

LIGHTING / ELECTRICAL PLAN & PROJECT SPECIFICATIONS

SHEET NO. 11/12/2022 1/4" = 1'-0" PROJECT NO. 1920.01