

2019 NOV 15 AM 9: 33

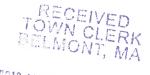
CASE NO. 19-41

NOTICE OF PUBLIC HEARING BY THE BELMONT ZONING BOARD OF APPEALS

ON APPLICATION FOR TWO SPECIAL PERMITS

Notice is hereby given that the Belmont Zoning Board of Appeals will hold a public hearing on Monday, December 2, 2019 at 7:00 PM in the Art Gallery, 3rd floor, Homer Municipal Building, 19 Moore St., to consider the application of Travis Franck at 102 Gilbert Road located in a General Residence (GR) Zoning District for Two Special Permits under §1.5 of the Zoning Bylaw to construct a Dormer. Special Permits, 1.- Zoning By-Law Dimensional Regulations allow a maximum of 2-1/2 story structures, The existing structure is three and a half (3-1/2) stories. The lowest level of the dwelling is a <u>basement</u> (68.70% of the foundation walls are exposed) and is considered a story. The proposed addition is at a three and a half story level. 2.- Minimum required side setback is 10.0', The existing side setback to the structure is 6.10' and the proposed to the dormer is 7.90'.

ZONING BOARD OF APPEALS





Town of Belmont Zoning Board of Appeals

2019 NOV 15 AM 9: 33

APPLICATION FOR A SPECIAL PERMIT

Date: $\frac{10}{24}/\frac{9}{9}$

Zoning Board of Appeals Homer Municipal Building 19 Moore Street Belmont, MA 02478

To Whom It May Concern:

Pursuant to the provisions of Massachuse	etts General Laws, Chapter 40A,			
Section 9, as amended, and the Zoning By-Laws	of the Town of Belmont, I/we the			
undersigned, being the owner(s) of a certain pare	cel of land (with the buildings thereon)			
situated on 102 Gilbert s	treet/Road, hereby apply to your Board			
for a SPECIAL PERMIT for the erection or alteration on said premises or the use				
thereof under the applicable Section of the Zonin	g By-Law of said Town for			
construction of dor	mer			
on the ground that the same will be in harmony	with the general purpose and intent of			
said Zoning By-Law.				
Signature of Petitioner	Trus Freur			
Print Name	Travis Franck			
Address	102 Gilbert Rd			
	Belmon + , MA 02478			
Daytime Telephone Number	617-858-1844			



OFFICE OF COMMUNITY DEVELOPMENT TOWN OF BELMONT

19 Moore Street Homer Municipal Building Belmont, Massachusetts 02478-0900

Telephone: (617) 993-2650 Fax: (617) 993-2651

Building Division (617) 998-2664 Engineering Division (617) 998-2665 Planning Division (617) 998-2666

September 27, 2019

Travis Franck 102 Gilbert Road Belmont, MA 02478

RE:

Denial to Construct a Dormer.

Dear Mr. Franck,

The Office of Community Development is in receipt of your building permit application for your proposal to construct a Dormer at 102 Gilbert Road located in a General Residence (GR) Zoning District.

Your application has been denied because it does not comply with the current Town of Belmont Zoning By-Law. More specifically, Section 4.2.2 of the Zoning By-Law Dimensional Regulations allows a maximum of 2-1/2 story structures and requires a minimum side setback of 10.0°.

- 1. The existing structure is three and a half (3-1/2) stories. The lowest level of the dwelling is a basement (68.70% of the foundation walls are exposed) and is considered a story. The proposed addition is at a three and a half story level.
- 2. The existing side setback to the structure is 6.10' and the proposed is 7.90'.

You may alter your plans to conform to the current Town of Belmont Zoning By-Law and resubmit a building permit application, or you may request two (2) Special Permits from the Zoning Board of Appeals. If you choose this option, please contact the Office of Community Development to schedule an appointment with Ara Yogurtian, Assistant Director, at (617) 993-2650 in order to begin the process.

Sincerely,

Glenn R. Clancy, P.E. Inspector of Buildings

Belmont Special Permit Application Statement

Address:102 Gilbert Road

Marcy and Travis Franck, of 102 Gilbert Road, seek special permit relief for the number of stories and side setback in order to add two dormers on their two-family home in the GR district.

Marcy and Travis have lived at 102 Gilbert Road since 2010, moving in with an 8-monthold baby. They have increasing become more integrated in the community and now are involved as Food Pantry volunteers, a Town Meeting Member, a Light Board Advisory Committee member, an Energy Committee member, a Belmont Second Soccer coach, and involved in the schools and church. Now, with two kids in elementary school, they are looking to stay in their home and the community by providing bedrooms for each family member. They also expect to care for their elderly parents, and this renovation would make this feasible.

Story Count: Their home is an existing non-conforming 3 1/2 story structure because the land slopes down toward the back, causing the basement level to be 68.7% above grade and therefore classified as a story. The attic half story is currently a finished space with a family room, bathroom and bedroom. The intent is to introduce a shed dormer on each side in order to allow for two new bedrooms and one additional bathroom. The attic will still constitute a half story space. Both dormers are designed to be held back from the front elevation (12'-5" back on north side and 14'-6" back on south side) in order to minimize the visibility and impact on the front façade. In addition, the view of the south side dormer is further blocked by an existing cross gable.

Side setback on north side: The existing setback on the north side is 6.1'. The dormer is offset an additional 1'-10", creating a 7.9' setback so as to minimize the massing on this side, while still maintaining enough width to reasonably accommodate a modestly sized bedroom. The dormer on the south side is an ample 24' from the property line.

There are several homes in the immediate vicinity that also have third floor dormers. In conclusion, the proposed alteration does not pose any substantial detriment to the neighborhood and does not nullify or substantially derogate the intent of the by-law. Rather, it is very reasonably sized and in line with the neighbors.

DLJ GEOMATICS

276 NORTH STREET WEYMOUTH, MA 02191

LANDSURV@COMCAST.NET

AUGUST 23, 2019

100-102 GILBERT ROAD BELMONT, MA 02478

BASEMENT CALCULATIONS:

THE FOUNDATION WALLS ARE 6.40' HIGH. THERE ARE EIGHT SEGMENTS.

SEGMENT:	LENGTH:	AREA:	AREA BELOW GRADE:
A	34.8'	222.72 S.F.	130.15 S .F.
В	43.7'	279.68 S.F.	117.99 S.F.
C	15.4'	98.56 s. F.	5.36 S. F.
D	12.8'	81.92 S.F.	2.30 S.F.
E	11.0'	74.24 S.F.	o s.f.
F	30.2'	193.28 S.F.	29.90 S.F.
G	8.2'	52.48 S.F.	17.88 S.F.
н	13.5	86.40 S.F.	37.40 S.F.

TOTAL:

1,089.28 S.F.

340.98 S.F.

340.98/1,089.28=.3130


31.30% OF THE FOUNDATION WALL IS BELOW GRADE.

SEG "A" BELMONT RD.

5kg	<i>''</i> 2'		
#1 A	BATEMENT CELL	1119=101.71	
34.8 TOTAL PARTE			99.46
34.8 13.74 BELOW 130.15 BELOW 130.15 grade	3.741	92.05	6.40
58.44% BELOW Graze	PATEMENT FL 39.8		ALAS L. C.
SEG B	CEUNG 2 101.7	Q-diq	2/23/19
43,7 10 TIPLE 179,68 11			643
17.79 grate	78.01		96.55
717.99 219 219.62 92.0%			


SEC C		BELMO	,
	BASE MENT CE	161kg=101.71	
13.4 15.56 POSE WALL 96.55.			
33 Drivate		.88	25.33
5.36 = .0544 93.56 5.44% BEC	BATEMENT F LOW grade 15.9		DOUGLAS L. JOHNSTON
566 D	MOTOR PROTECTION AND ADMINISTRATION AND ADMINISTRAT	a a a a a a a a a a a a a a a a a a a	Dayle Gatt 19
12.8 Tope 12.92 mil	CKILING= 101.9		
12.8 15 www 12.30 9/3de	•	95.49	95.15 6.40
2.30 2-0291 31.92	; es can	.18	
2.81% avade	tron=95.31.		

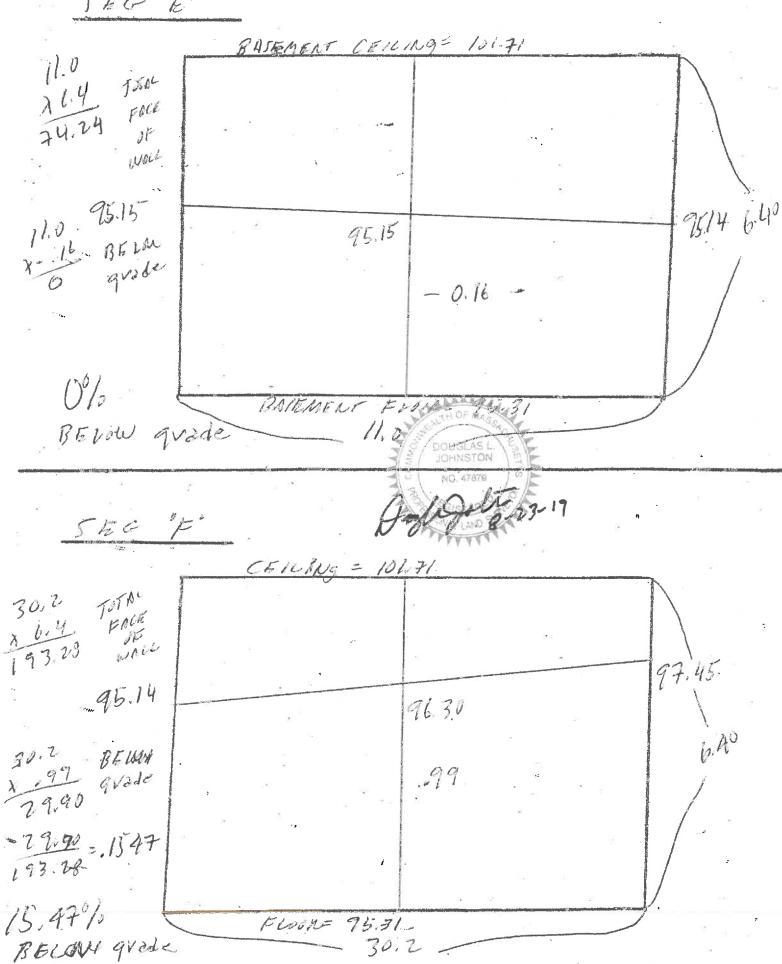SEG "E"




SEG "F"

•	BAIEMENT C.	E161kg= 101.71	
8.2 16.4 TOTAL 52.48 PACE 52.48 PACE 47.45		97.49	9733
12.18 BELOW 17.88 gvade		2.18	647
17,83 32.48 = 3407 34.07% BELOW QVAA	BOTEMENT P.		
5EG 6		Jan 1	
13.3 TOTAL 16.40 FALK WALL	27 049 5		78.63
37.42 - 4329	*	2.77	6.40
43.29%			
BELL quale	FLOR: 98	231	

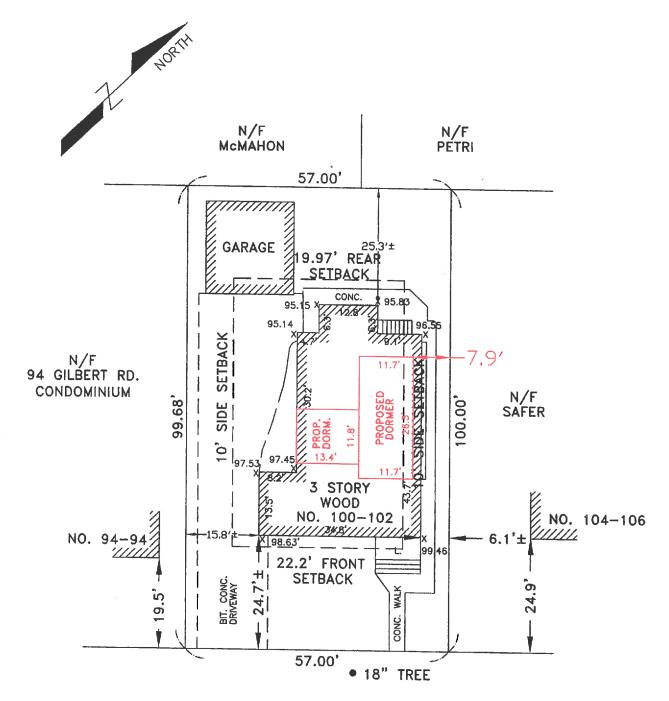

GILBERT ROAD

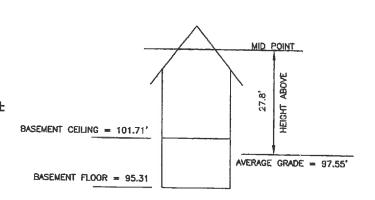LOT AREA = 5,700 S.F.± EXISTING BUILDING = 1,375 S.F.± EXISTING GARAGE = 380 S.F.± EXISTING PAVEMENT + WALK = 1,632 S.F.± PROPOSED ADDITION = 466 S.F.± EXISTING LOT COVERAGE = 30.8% PROPOSED LOT COVERAGE = 30.8% EXISTING OPEN SPACE = 40.6% PROPOSED OPEN SPACE = 40.6%



NOTES

- SEE DEED RECORDED IN MIDDLESEX COUNTY REGISTRY OF DEEDS IN DEED BOOK 19918, PAGE 117.
- 2. SEE PLAN RECORDED IN MIDDLESEX COUNTY REGISTRY OF DEEDS IN PLAN BOOK 324, PAGE 45.
- 3. SUBJECT PARCEL IS LOCATED IN ZONE GR.
- 4. SUBJECT PARCEL IS LOCATED IN FLOOD ZONE X AS SHOWN ON PANEL 25017C0418E WITH AN EFFECTIVE DATE OF JUNE 4, 2010.
- 5. ONE PUBLIC SHADE TREE IS LOCATED WITHIN THE LIMITS OF THE PROPERTY FRONTAGE OF THE SUBJECT PROPERTY.
- 6. FRONT SETBACK=24.9'+19.5'=44.4'





(IN FEET)
1 inch = 20 ft.

CERTIFIED PLOT PLAN IN BELMONT, MA

SCALE: 1" = 20' AUGUST 23, 2019

DLJ GEOMATICS
PROFESSIONAL LAND SURVEYING
276 NORTH STREET
WEYMOUTH, MA 02191
(781) 812-0457

100-102 GILBERT RD BELMONT.dwg

Zoning Compliance Check List

Properties Located within the GR Zoning Districts

(To be Completed by a Registered Land Surveyor)

Property Address: 100-102 GILBERT ROAD

Surveyor Signature and Stamp: 4 Date: 8/19/19


			A Street	10/2	*		. ,
	Per §4.2 of the Zoning By-Law						
			REQUIRED	EXISTING		PROPOSE	D
Lot Area (se	q. ft.)		5,000 S.F.	5,7	100 S.F.	5,7005	F.
Lot Frontag	e (fee	t)	5,060 S.F. 50.0'	57	:0'	57.0'	
Lot Area/Ur	nit (sq.	. ft./d.u.)		,			
Lot Coverag	ge (%	of lot)	30.0%			30.8%	,
Open Spac	e (% c	of lot)	40%	40.	6%	40.6%	
	> F	ront ^(a)	22.2'	24	7'	24.7'	
Setbacks:	> 2	nd Front Door (25%)	NIA	N		NIA	
(feet)	> S	ide/Side	10' 16'			15.8' 6.1	1
	> R	ear	19.97'		.3'	25.3'	
Building	> F	eet	33'	27.	8'	27.8'	
Height:	> Stories		21/2	3		3	
1/2 Story	> P	erimeter (50%)					
(feet)	> A	rea (60%)					
(Per §1.4)	> L	ength (75%)					
		Per §6D of t	he Zoning By-	Law			
HVAC: Prohibited in Front Yard and Side and Rear Setbacks							
Front Doors	Front Doors: Both Must Face Street (b)						
S1			STANDAI	STANDARD PI		ROPOSED	
Curb Cut (O	ne pe	r 70' Frontage) ^(c)	/			1	

Front setback is equal to the average front setbacks of the abutting properties on either side.

(b) The second unit's front door may be allowed to face the side yard only if the existing structure is historically or architecturally significant.

SUBMIT CALCULATIONS for all of the requirements listed above on a separate piece of paper(s) to verify how they were calculated

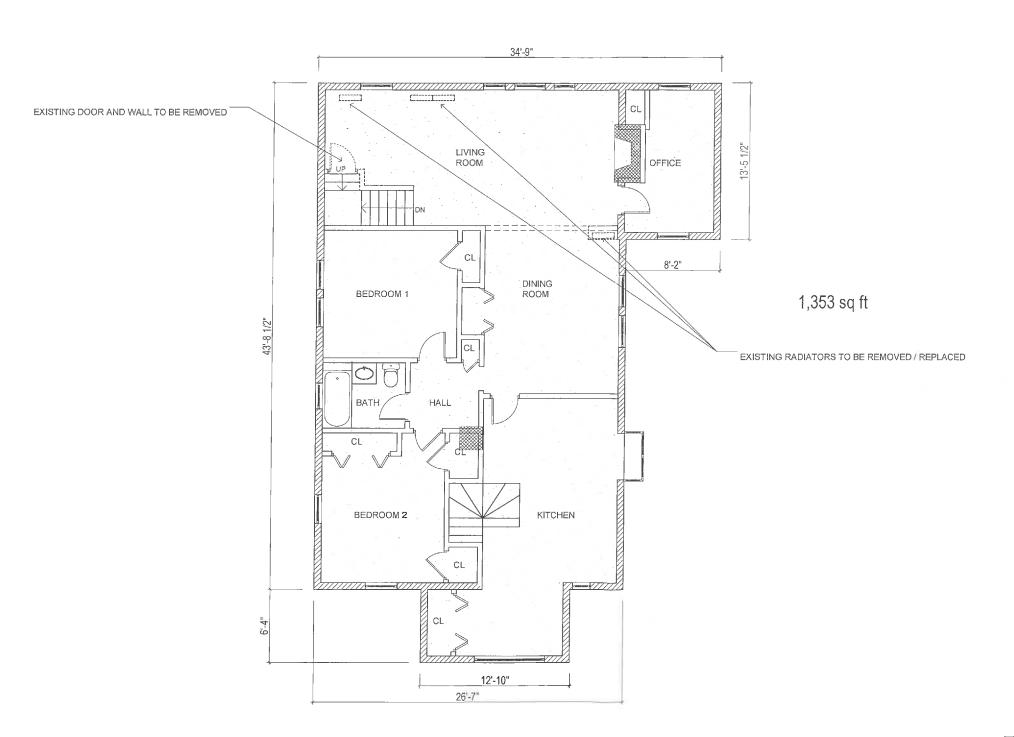⁽c) A second curb cut may be allowed where the Applicant can demonstrate that creating a second curb cut is harmonious with the surrounding neighborhood.



M9LLER
DESIGN LLC

80 CLARK STREET
BELMONT, MA 02478

Architect: Miller Design LLC 80 Clark Street Belmont MA 02478 617-993-3157

Date:	Issued for:
5/17/19	SCHEMATIC DESIGN
8/9/19	DESIGN DEVELOPMENT
8/14/19	CONSTRUCTION DOCS



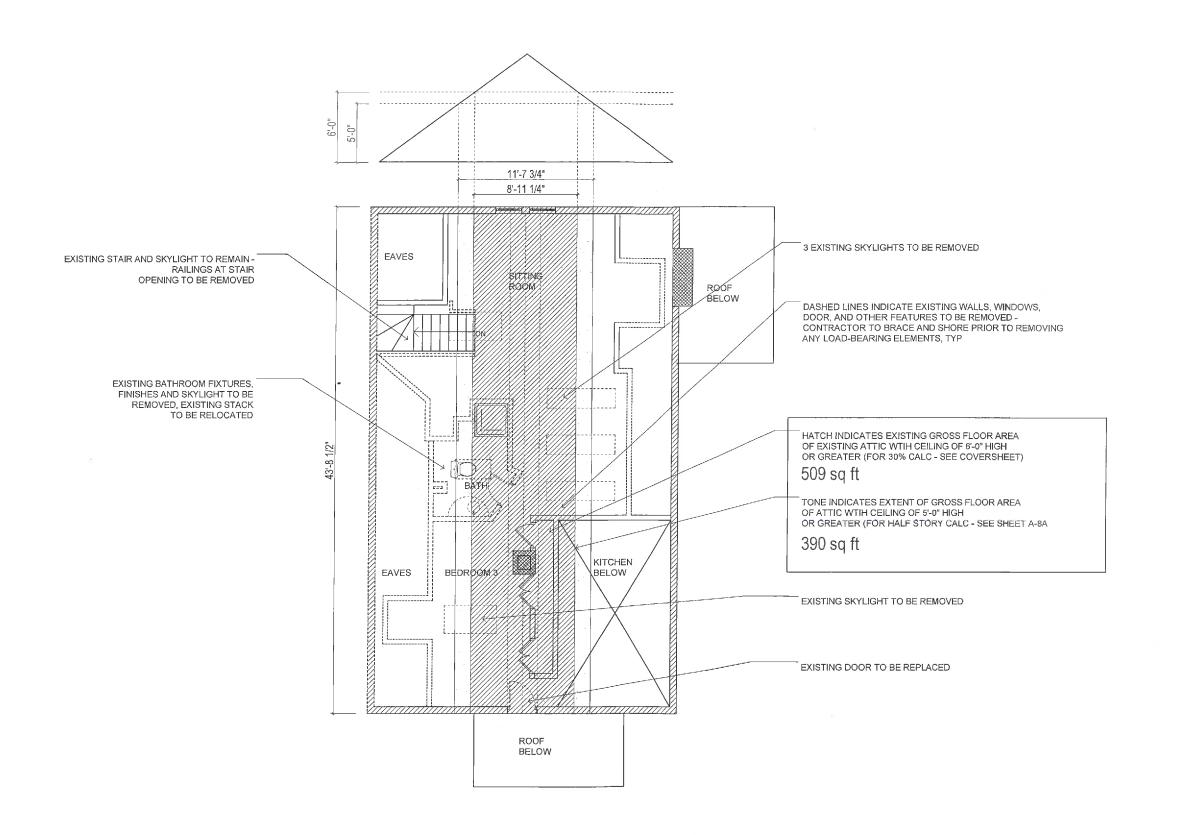
FRANCK RESIDENCE 102 GILBERT ROAD BELMONT MA 02478

EXISTING SECOND FLOOR

Sheet Number:

A4

1 PLAN SCALE: 1/8" = 1' 0 5 10



MILLER DESIGN LLC



80 CLARK STREET BELMONT, MA 02478

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FRANCK RESIDENCE 102 GILBERT ROAD BELMONT MA 02478

EXISTING ATTIC

Sheet Number:

A5

1 PLAN SCALE: 1/8" = 1' 0 5 10






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FRANCK RESIDENCE 102 GILBERT ROAD BELMONT MA 02478

EXISTING ELEVATIONS





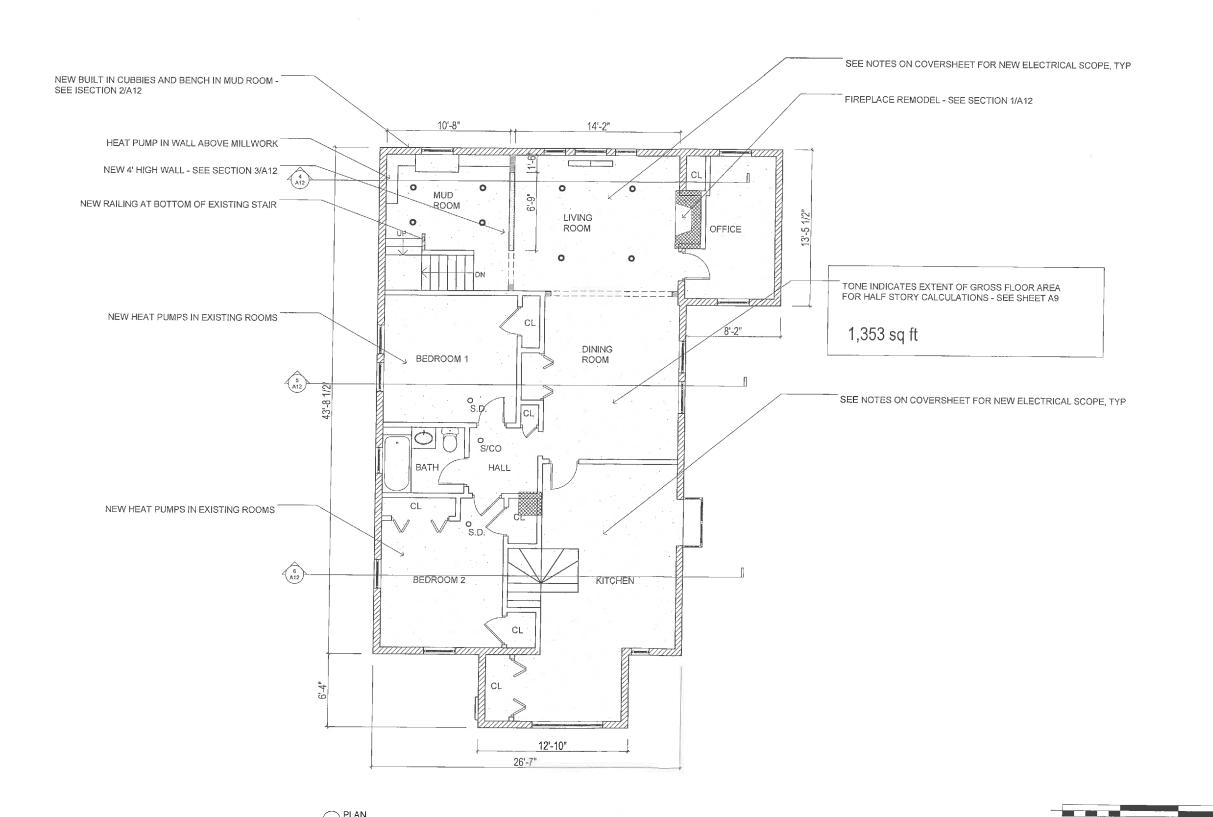Architect: Miller Design LLC 80 Clark Street Belmont MA 02478 617-993-3157


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FRANCK RESIDENCE 102 GILBERT ROAD BELMONT MA 02478


NEW SECOND FLOOR PLAN

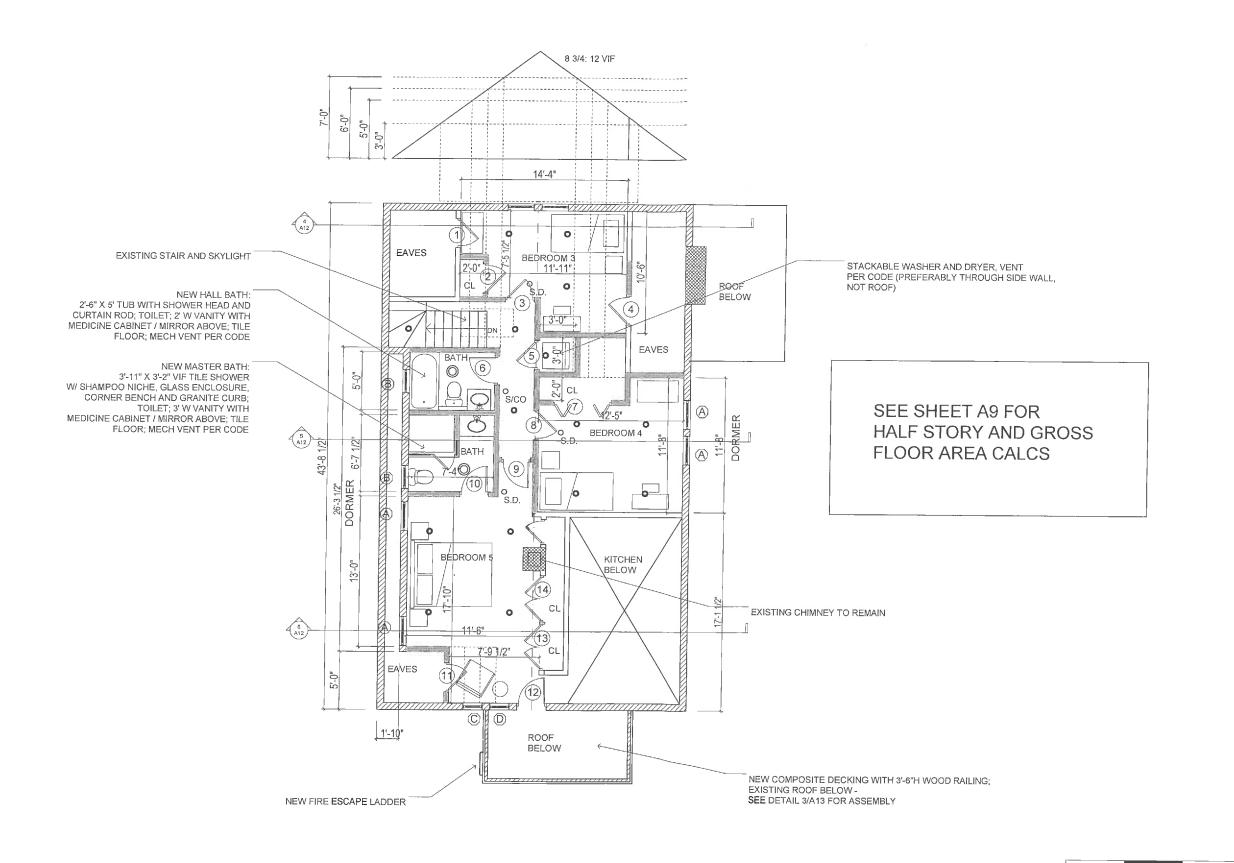Sheet Number;





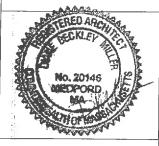Architect Miller Design LLC 80 Clark Street Belmont MA 02478 617-993-3157



FRANCK RESIDENCE 102 GILBERT ROAD BELMONT MA 02478

NEW ATTIC FLOOR PLAN

Shee

10

HALF STORY AREA CALCULATIONS:

ALLOWABLE: AREA WITH CEILING HEIGHT OF 5' OR GREATER CAN BE NO MORE THAN 60% OF SECOND FLOOR AREA

SECOND FLOOR AREA = 1353 SF 60% OF 1353 = B11.8 SF MAX ACTUAL: 390 SF EXISTING + 148 + 93 SF PROPOSED = 631 SF, CONFORMING (PROPOSED AREA W/ CEILING HEIGHT OF 5' OR GREATER IS DESIGNATED BY TONE)

HALF STORY PERIMETER CALCULATIONS:

SECOND FLOOR PERIMETER = 149'-9" LF

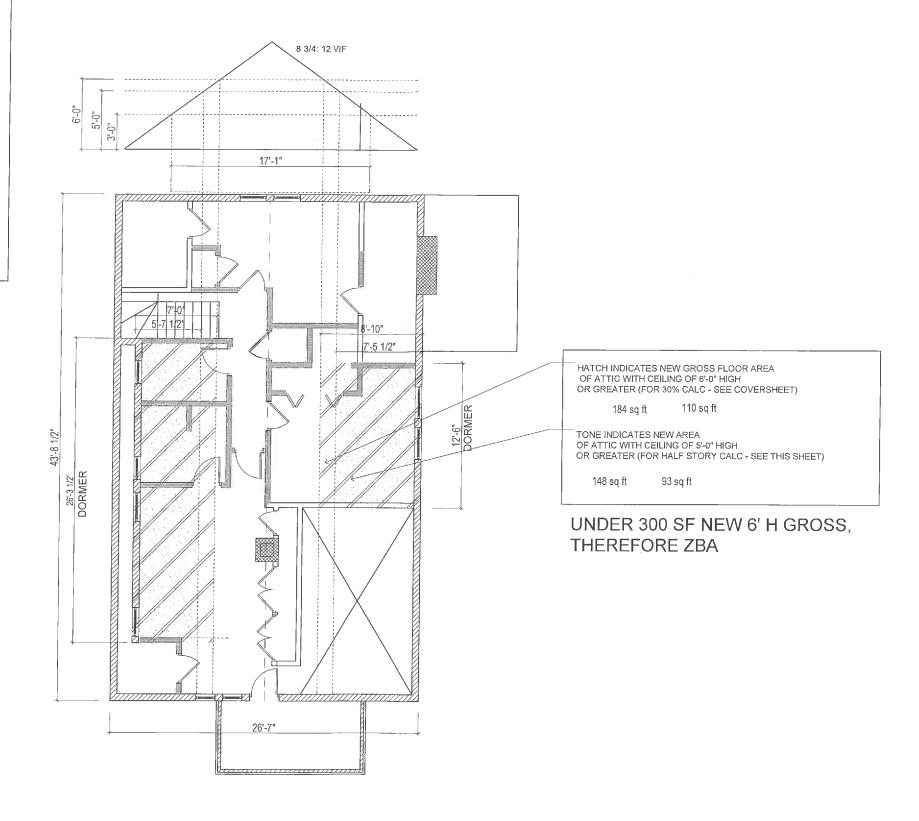
ALLOWABLE: MAX 74'-10 1/2" W/ RAFTER BOTTOMS AT 3' OR GREATER (BASED ON 50% OF 149'-9" PERIMETER).

ACTUAL 26'-3 1/2" + 12'-6" + 17'-1" + 17'-1" = 72'-11 1/2", CONFORMING

DORMER LENGTH CALCULATIONS:

ALLOWABLE: 32'-9 1/2" MAX PER ROOF SIDE (75% OF 43'-8 1/2")


ACTUAL: 26'-3 1/2", CONFORMING





Architect: Miller Design LLC 80 Clark Street Belmont MA 02478 617-993-3157


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FRANCK RESIDENCE 102 GILBERT ROAD BELMONT MA 02478

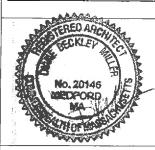ATTIC CALCULATIONS
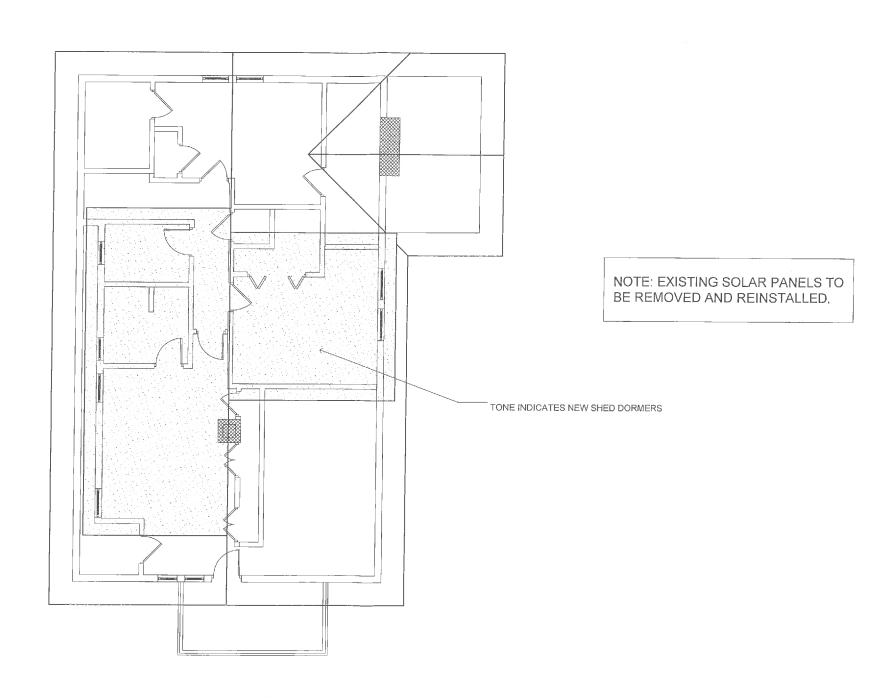
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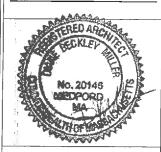


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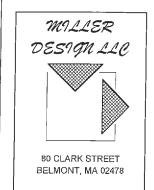


FRANCK RESIDENCE 102 GILBERT ROAD BELMONT MA 02478

ROOF PLAN


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Architect: Miller Design LLC 80 Clark Street Belmont MA 02478 617-993-3157

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FRANCK RESIDENCE 102 GILBERT ROAD BELMONT MA 02478

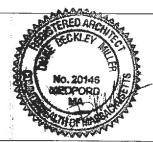NEW ELEVATIONS

Sheet