

RECEIVED TOWN CLERK BELMONT, MA

2019 JAN 22 PM 3: 20

NOTICE OF PUBLIC HEARING BY THE BELMONT ZONING BOARD OF APPEALS

ON APPLICATION FOR A SPECIAL PERMIT

Notice is hereby given that the Belmont Zoning Board of Appeals will hold a public hearing on Monday, February 4, 2019 at 7:00 PM in the Art Gallery, 3rd floor, Homer Municipal Building, 19 Moore St. to consider the application of Jay Bonnar for One (1) Special Permit under Section 1.5 of the Zoning By-Law to construct a one story addition at 61 Warwick Road located in a General Residence (GR) Zoning District. Section 4.2 of the By-Laws require a minimum side setback of 10.0°. The existing side setback is 5.0° and the proposed is 5.6°.

ZONING BOARD OF APPEALS



Town of Belmont Zoning Board of Appeals

2019 JAN 22 PM 3: 20

APPLICATION FOR A SPECIAL PERMIT

	Date: 12/26/18
Zoning Board of Appeals Homer Municipal Building 19 Moore Street Belmont, MA 02478	
To Whom It May Concern:	
Pursuant to the provisions of Massachuse Section 9, as amended, and the Zoning By-Laws undersigned, being the owner(s) of a certain par situated on 6 Warwick sfor a SPECIAL PERMIT for the erection or alterathereof under the applicable Section of the Zonin One Story addition	s of the Town of Belmont, I/we the cel of land (with the buildings thereon) treet/Road, hereby apply to your Board ation on said premises or the use ag By-Law of said Town for
on the ground that the same will be in harmony said Zoning By-Law.	with the general purpose and intent of
Address	Bolmont MA 02478
USVIIME Lelenhone Number	617-484-0627

Belmont Special Permit Application Statement 61 Warwick Road

Jay Bonnar of 61 Warwick Road is seeking a special permit for a side setback on the west side of his property in order to construct a small one story expansion to his kitchen. Jay and his wife Ayae have lived in Belmont in their current home since 2008. Their daughter, Michiru, now 5, was born in 2013.

The <u>side yard setback</u> is currently at 5.0 (10.0 allowed in the GR district). The kitchen addition has a proposed setback of 5.63'. The profile of the expansion is the same as the current condition (one story hip roof), and the addition is set back from the front of the home and will be screened by landscaping. Currently, there is a 31 sf one story pantry on this side. The proposed plan is to replace the pantry space with a 103 sf kitchen expansion (72 additional sf) to allow for a more functional work space. Due to the small scale and consistent massing, this addition is very de minimus in nature and will not be significantly detrimental to the neighborhood.



OFFICE OF COMMUNITY DEVELOPMENT TOWN OF BELMONT

19 Moore Street Homer Municipal Building Belmont, Massachusetts 02478-0900

Telephone: (617) 993-2650 Fax: (617) 993-2651

Building Division (617) 993-2664 Engineering Division (617) 993-2665 Planning Division (617) 993-2666

November 28, 2018

Jay Bonnar 61 Warwick Road Belmont, MA 02478

RE: Denial to Construct a One Story Addition.

Dear Mr. Bonnar,

The Office of Community Development is in receipt of your building permit application for your proposal to construct a one story addition at 61 Warwick Road located in a General Residence (GR) Zoning District.


Your application has been denied because it does not comply with the current Town of Belmont Zoning By-Laws. More specifically, Section 4.2 of the Zoning By-Laws Dimensional Regulations require a minimum side setback of 10.0°.

1. The existing side setback is 5.0' and the proposed is 5.6'. A Special Permit.

You may alter your plans to conform to the current Town of Belmont Zoning By-Laws and resubmit a building permit application, or you may request One (1) Special Permit from the Zoning Board of Appeals. If you choose this option, please contact the Office of Community Development to schedule an appointment with Ara Yogurtian, Assistant Director, at (617) 993-2650 in order to begin the process.

Sincerely,


Glenn R. Clancy, P.E. Inspector of Buildings

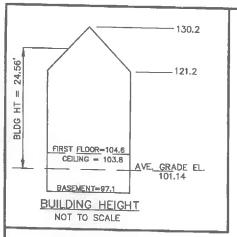

PROPOSED -HVAC UNIT

WARWICK ROAD

60.64% OF BASEMENT UNDERGROUND THEREFOR BASEMENT IS NOT A STORY

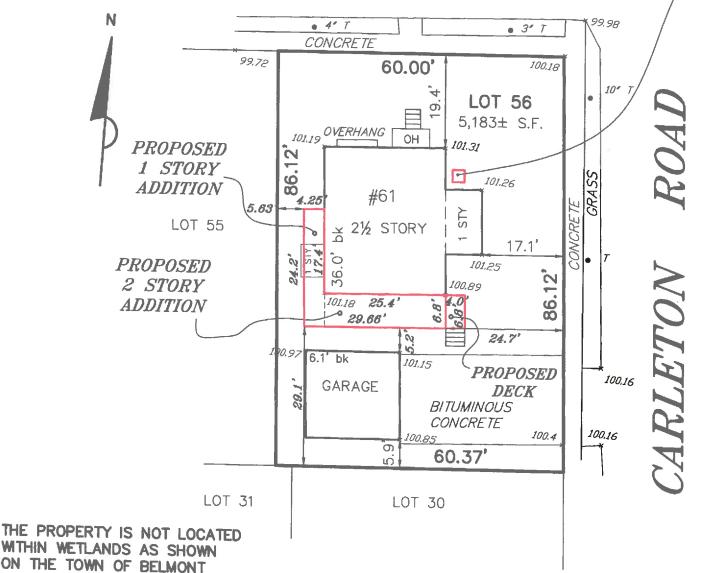

WITHIN WETLANDS AS SHOWN ON THE TOWN OF BELMONT WETLANDS ATLAS.

ZONING DISTRICT: GR (GENERAL RESIDENCE)

REQ. EXISTING PROP. FRONT SETBACK: 20' 19.4 SIDE SETBACK: 10' 5.0' 5.6' REAR SETBACK: 17.22 36.0' 29.1' MAXIMUM LOT COVERAGE:

30% MINIMUM OPEN SPACE: 40% 62.3%

LOT FRONTAGE:

25.3%

RESERVE DE

G 131mm

60.0

30.0% 57.6%

TOTAL LOT AREA: 5,183± S.F.

OWNER: JAY BONNAR

51579/465 ASSESSORS MAP 6 - PARCEL 113

PROPOSED PLOT PLAN #61 WARWICK ROAD

> BELMONT, MA (MIDDLESEX COUNTY)

SCALE: 1"= 20'

DATE: 5/26/2017

60 ft

40 ROBER SURVEY

1072 MASSACHUSETTS AVENUE ARLINGTON, MA 02476 (781) 648-5533 DWG. NO. 5234PP2.DWG

CLIFEORD E. ROBER, PLS

Zoning Compliance Check List

Properties Located within the GR Zoning Districts

(To be Completed by a Registered Land Surveyor)

Property Address:	(0)	Warwick	Road
CLIFFORD \ E			


Survey Signature and Stamp: ___

Date: 11/16/18

D SHVETOR	Per §	4.2 of the Zonin	ng By-Laws	
		REQUIRED	EXISTING	PROPOSED
Lot Area (sq. ft.)	5,000	5,183	5,183
Lot Fronta	ige (feet)	50	60.	_
Lot Area/L	Jnit (sq. ft./d.u.)	3,500		
Lot Covera	age (% of lot)	30%	25.3%	30 %
Open Spa	ce (% of lot)	40%	62.3%	57.6%
	> Front	20'	19.4'	3 1.0 10
Setbacks: (feet)	> Side/Side	10 10	17.1 5.0	24,7 5.6
	> Rear	2017.22	36.	29.1
Building	> Feet	33	24.56	24.56
Height: ➤ Stories		21/2	21/2	21/2
1/2 Story	> Perimeter			<i>D</i> = 100
(feet) (Per §1.4)	> Area			
(Fer §1.4)	> Length			
	Per §6	D of the Zoning	By-Laws	
		REQUIRED	EXISTING	PROPOSED
Front	> Face Street			
Doors:	> Setback			
Curb Cut				
10/40	➤ Front Yard			
HVAC:	Side/RearSetbacks			

SUBMIT CALCULATIONS for all of the requirements listed above on a separate piece of paper(s) to verify how they were calculated

\$5234 #61 Warwide RJ.

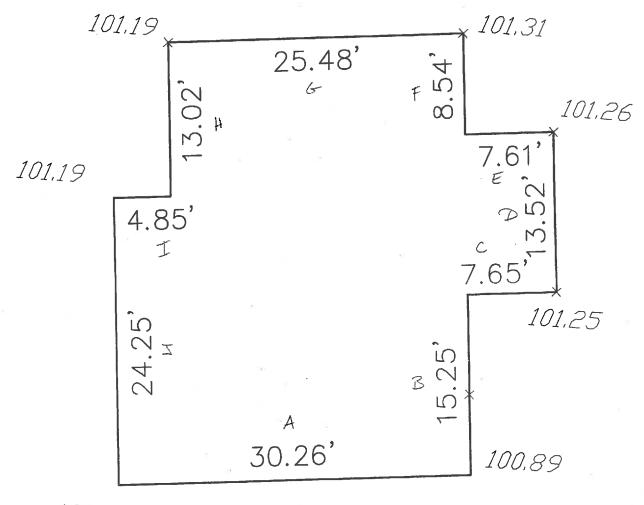


100,97

W/ADDITION

Se	om	en	÷	To
JE	KIII	EU.	L	10

_	Segment From Existing	Segment From New	Existing	Segment To	Segment	Avg				
Segment	Grade	Grade	Grade	New Grade	Length	Existing	Avg New	Difference	Ceiling Height:	6.66
A	100.97	100.97	100.89	100.89	30.26	3054.142	3054.142	0.00	Basement Floor Elevation	97.1
В	100.89	100.89	101.25	101.25	15.25	1541.318	1541.318		Ceiling Elevation	103.76
C	101.25	101.25	101.25	101.25	7.65	774.5625	774.5625		Perimeter Total Length	150.43
D	101.25		101.26	101.26	13.52	1368.968	1368.968	0.00	Total Perimeter Square Foot	1001.86
t .	101.26	202120	101.31	101.31	7.61	770.7789	770.7789	0.00	Average Existing Grade	101.14
F	101.31			101.31	8.54	865.1874	865.1874	0.00	New Average Grade	101.14
G H	101.31			101.19	25.48	2579.85	2579.85	0.00	Difference in Grade in feet	
n I	101.19		-+2:25		13.02	1317.494	1317.494	0.00		
1	101.19			202,25		490.7715	490.7715	0.00		
,	101.19	101.19	100.97	100.97						
					150.43	15214.26	15214.26	0	% Covered using Avg Grade	60.64%

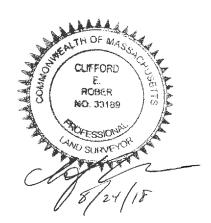

							Exposed	
	Ceiling	Elevation	Elevation		Ceiling	Square	Square	
Segment	Elevation	From	То	Length	Height	Footage	Footage	% Covered
A	 103.76	100.97	100.89	30.26	6.66	201.53	85.64	57.51%
В	103.76	100.89	101.25	15.25	6.66	101.57	41.02	59.61%
C	103.76	101.25	101.25	7.65	6.66	50.95	19.20	62.31%
D	103.76	101.25	101.26	13.52	6.66	90.04	33.87	62.39%
E	103.76	101.26	101.31	7.61	6.66	50.68	18.83	62.84%
F	103.76	101.31	101.31	8.54	6.66	56.88	20.92	63.21%
G	103.76	101.31	101.19	25.48	6.66	169.70	63.95	62.31%
H	103.76	101.19	101.19	13.02	6.66	86.71	33.46	61.41%
1	103.76	101.19	101.19	4.85	6.66	32.30	12.46	61.41%
J	103.76	101.19	100.97	24.25	6.66	161.51	64.99	59.76%
	103.76	i		150.43	6.66	1001.86	394.36	60.64%

1					
6.66	<- enter	North	South	East	West
97.1	<- enter	#REF!	#REF!	#REF!	#REF!
103.76		#REF!	#REF!	#REF!	#REF!
150.43		0.00	0.00	0.00	0.00
1001.86		0.00	0.00	0.00	0.00
394.36		0.00	0.00	0.00	0.00
k Deen east	<- result	0.00	n ón	0.00	0.00
	~- resuit				
		0.00	0.00	0.00	0.00
		0.00	0.00	0.00	0.00
		0.00	0.00	0.00	0.00
	97.1 103.76 150.43 1001.86 394.36	150.43 1001.86	97.1 <- enter #REF! 103.76 #REF! 150.43 0.00 1001.86 0.00 394.36 0.00 result 0.00 0.00	97.1 <- enter #REF! #REF! 103.76 #REF! #REF! 150.43 0.00 0.00 1001.86 0.00 0.00 394.36 0.00 0.00 0.00 0.00 0.00 0.00 0.00 0.00	97.1 <- enter #REF! #REF! #REF! #REF! 103.76 #REF! #REF! #REF! #REF! 150.43 0.00 0.00 0.00 1001.86 0.00 0.00 0.00 394.36 0.00 0.00 0.00 0.00 0.00 0.00 0.00 0.00 0.00 0.00 0.00 0.00



WINDOW SCHEDULE:

ALL WINDOWS TO BE ANDERSON 400 OR APPROVED EQUAL. WINDOW SPECIFICATIONS TO BE APPROVED BY OWNER. EXACT DIMENSIONS MAY BE ADJUSTED TO MEET STANDARD SIZING AVAILABLE, WITH OWNER'S CONSENT.

WINDOW A: DOUBLE-HUNG - 2'-6"W X 3'-4"H, SILL AT 3'-6" AFF

WINDOW B: DOUBLE-HUNG - 2'-6"W X 4'-8"H, SILL AT 2'-2" AFF (VIF, TME) TO MEET EGRESS REQUIREMENTS FOR BEDROOMS (MIN 23" X 20" AND 3.3 CLEAR OPENING)

WINDOW C: COMPOSITE WINDOW - 2'-3"W X 3'-4"H OVERALL DIMENSIONS (FIXED UPPER AND AWNING STYLE LOWER), SILL AT 3'-3" AFF

WINDOW D: BASEMENT WINDOW - 2'-3"W X 1'-7"H TME, VIF

ENERGY AUDIT:

REFERENCE CH 11 - ENERGY EFFICIENCY 2015 INTERNATIONAL RESIDENTIAL CODE W/ MASS AMENDMENTS.

PRESCRIPTIVE OPTION FOR RESIDENTIAL ADDITION (401.3):

- 1. RENOVATION TO COMPLY WITH ENERGY STAR QUALIFIED HOMES THERMAL BYPASS INSPECTION CHECKLIST. INSULATION VALUES AS FOLLOWS: R49 ROOF R-VALUE, R20 WALL R-VALUE, R15/19 BASEMENT / CRAWL SPACE WALL R-VALUE.
- 2. RENOVATION TO COMPLY WITH ENERGY STAR PROGRAM REQUIREMENTS FOR RESIDENTIAL WINDOWS, DOORS, AND SKYLIGHTS VERSION 5.0. ALL NEW WINDOW GLAZING TO BE .30 U FACTOR AND SKYLIGHTS TO BE .55 U-FACTOR.
- 3. HEATING / COOLING DUCTS TO BE SEALED AND TESTED TO MEET REQUIREMENTS OF 401.3.

REVIEW SET 7/9/18 REVISED 11/8/18

PROJECT INFORMATION:

ZONING GR:

REQUIRED: FRONT YARD SETBACK: AVERAGE REAR YARD SETBACK: 17.2' (20% OF 86.12') SIDE YARD SETBACK: 10'-0"

MAX HEIGHT: 33' AND 2 1/2 STORIES

MAX LOT COVERAGE: 30% MIN OPEN SPACE: 40%

ACTUAL: SEE CERTIFIED PLOT PLAN

CELLAR IS MORE THAN 60% BELOW GRADE -SEE CERTIFIED PLOT PLAN FOR CALCULATIONS.

EXISTING GROSS FLOOR AREA: 0 SF CELLAR 900 SF FIRST FLOOR 400 SF GARAGE 758 SF SECOND FLOOR 36 SF ATTIC 2094 SF TOTAL

30% OF 2,094 SF = 628.2 SF MAX ADDITION

NEW ADDITION GROSS FLOOR AREA: 0 SF CELLAR 246 SF FIRST FLOOR 172 SF SECOND FLOOR 10 SF ATTIC 426 SF TOTAL

426 SF < 628.2 SF THEREFORE CONFORMS

DRAWING LIST

A1 COVER SHEET

A2 EXISTING CELLAR FLOOR PLAN

A3 EXISTING FIRST FLOOR PLAN
EXISTING SECOND FLOOR PLAN

A5 EXISTIGN ATTIC PLAN

A6 EXISTING ELEVATIONS
A7 NEW CELLAR FLOOR PLAN

A8 NEW FIRST FLOOR PLAN

A9 NEW SECOND FLOOR PLAN

SYMBOL LEGEND

WALL TO BE DEMOLISHED

EXISTING WALL TO REMAIN

INTERIOR ELEVATION

NEW WALL

SECTION

DOOR TAG

WINDOW TAG

A10 NEW ATTIC PLAN

A11 NEW ROOF PLAN

A12 NEW ELEVATIONS

Architect: Miller Design LLC 52 Statler Road Belmont MA 02478 617-993-3157

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2/25/18 SCHEMATIC DESIGN

3/12/18 DESIGN DEVELOPMENT

7/9/18 PLANNING BD REVIEW

11/8/18 REVISIONS



BONNAR RESIDENCE 61 WARWICK ROAD BELMONT MA 02478

COVERSHEET

Sheet Numb**er**:

A'

LIGHTING LEGEND

RECESSED LED CAN LIGHT - AS SELECTED BY OWNER

© CEILING MOUNTED PENDANT - AS SELECTED BY OWNER

AS SELECTED BY OWNER




S.D. SMOKE DETECTOR - NOTE ALL NEW AND EXISTING SMOKES TO BE HARD-WIRED PER CODE

S/CO HARD-WIRED SMOKE / CARBON MONOXIDE DETECTOR

A DATA CONNECTION

ELECTRIC OUTLET (SPECIFIC LOCATIONS ONLY - ALL OUTLETS : REQUIRED BY CODE ARE NOT SHOWN ON PLANS)

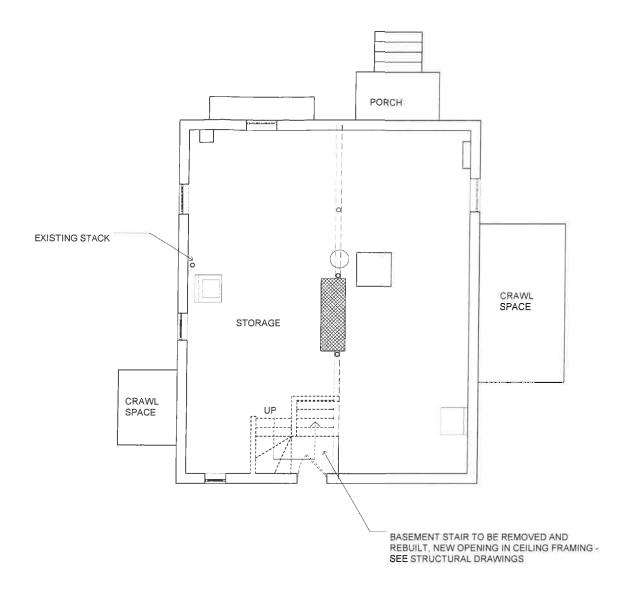

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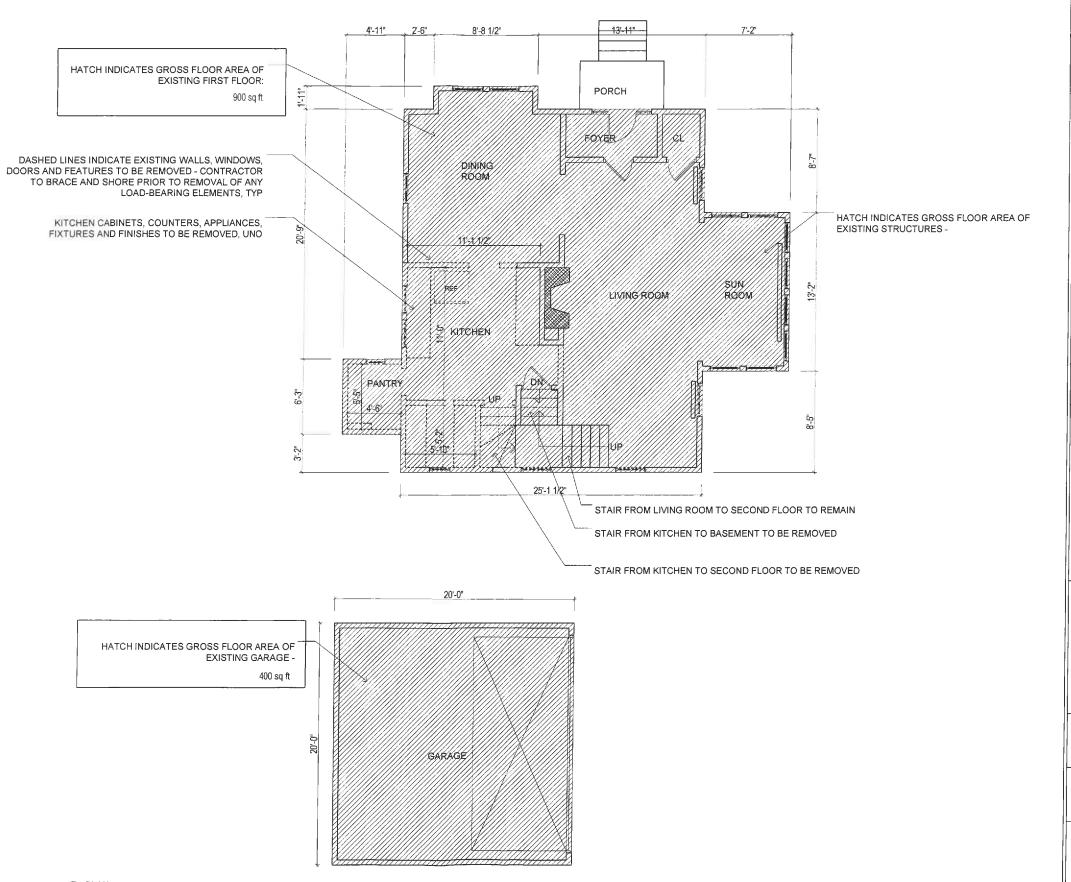
7/9/18 PLANNING BD REVIEW



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EXISTING CELLAR FLOOR PLAN

Sheet Number:



Date: Issued for:

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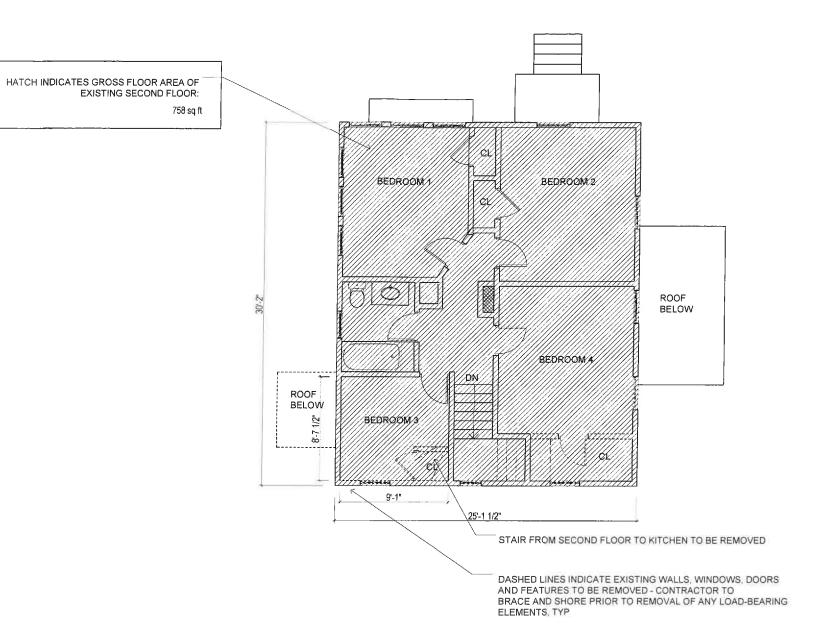
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EXISTING FIRST FLOOR PLAN

Numb



Date:

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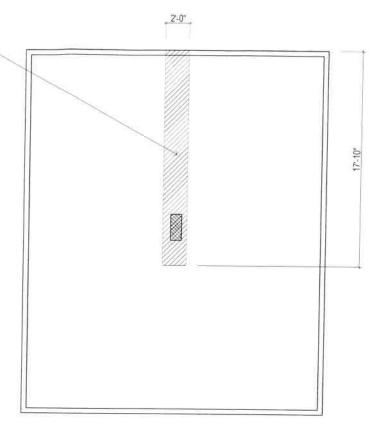


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EXISTING SECOND FLOOR PLAN

Sheet

HATCH INDICATES GROSS FLOOR AREA OF EXISTING ATTIC SPACE WITH CEILING HEIGHT OF 6' OR GREATER 36 sq ft



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3/12/18 DESIGN DEVELOPMENT
7/9/18 PLANNING BD REVIEW

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EXISTING ATTIC FLOOR PLAN


Sheet

A5

1 PLAN SCALE: 1/8" = 1'



1 REAR ELEVATION SCALE: 1/8" = 1'

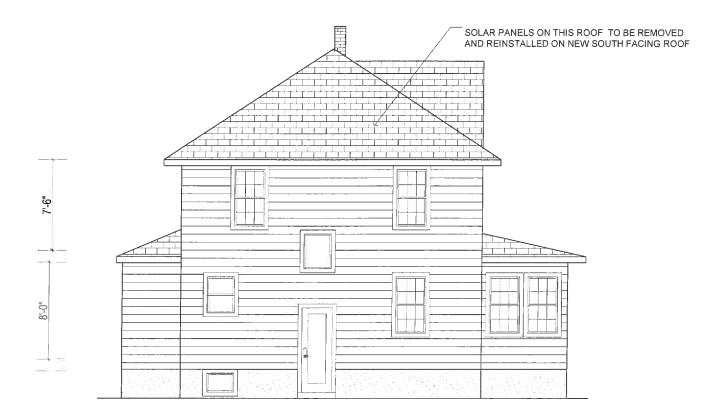





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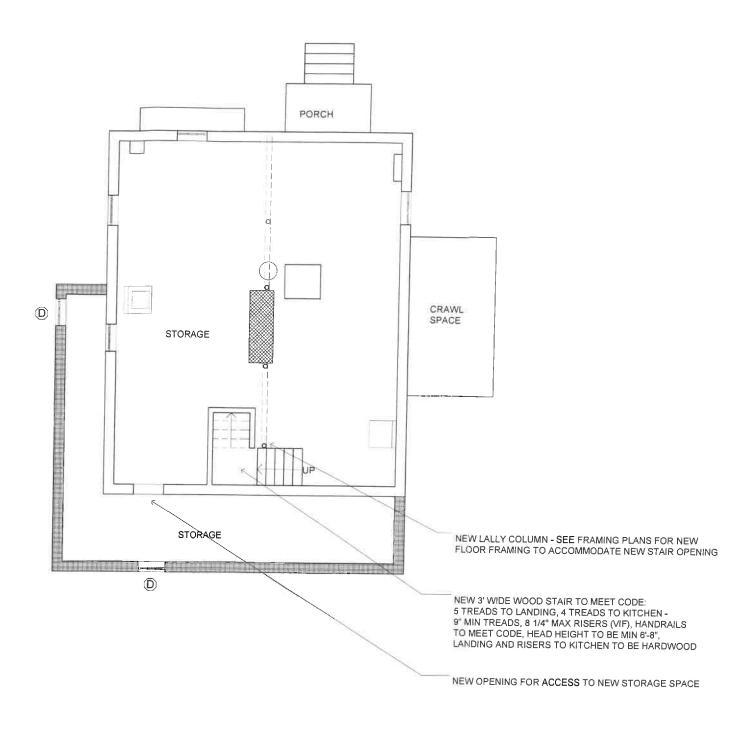
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BONNAR RESIDENCE 61 WARWICK ROAD BELMONT MA 02478

EXISTING ELEVATIONS

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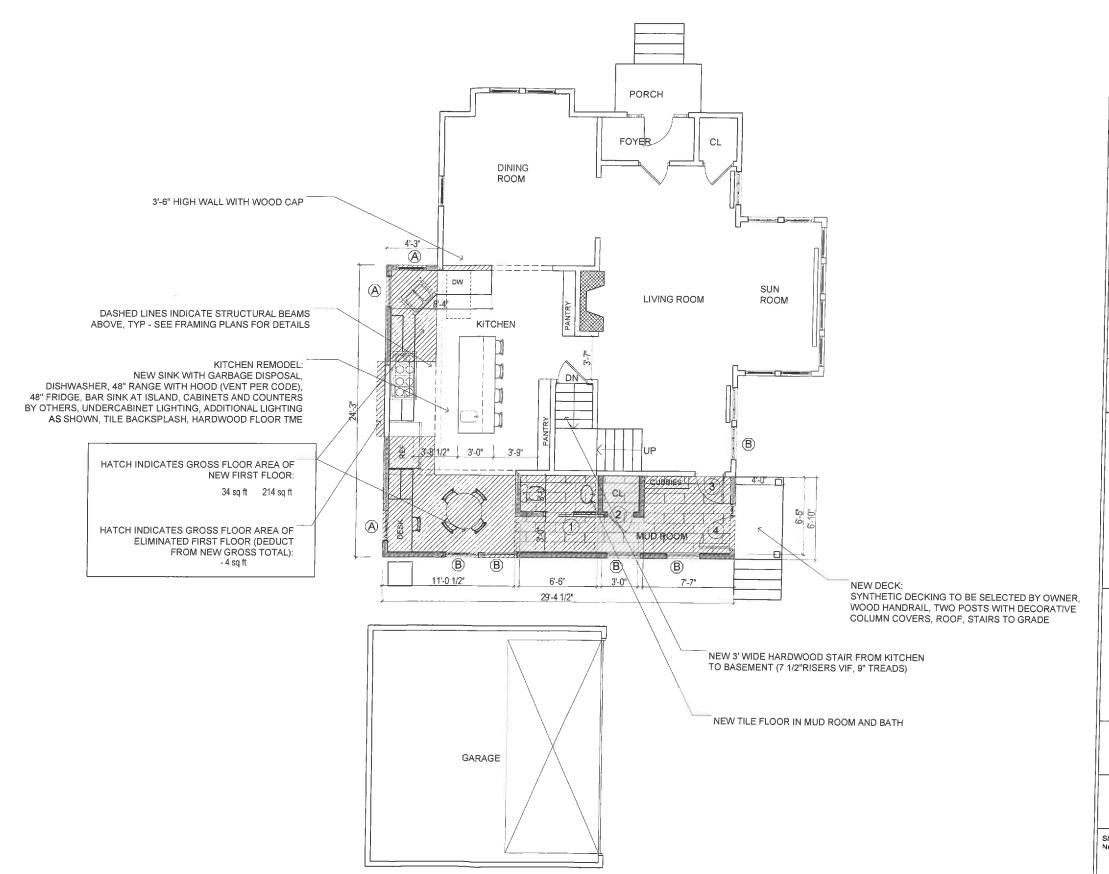




BONNAR RESIDENCE 61 WARWICK ROAD BELMONT MA 02478

NEW CELLAR FLOOR PLAN

Sheet Number:



1 PLAN SCALE: 1/8" = 1'


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Issued for: SCHEMATIC DESIGN 3/12/18 DESIGN DEVELOPMENT **5/9**/18 PBOORESSED REVIEW REVISIONS 11/8/18



BONNAR RESIDENCE 61 WARWICK ROAD BELMONT MA 02478

NEW FIRST FLOOR PLAN

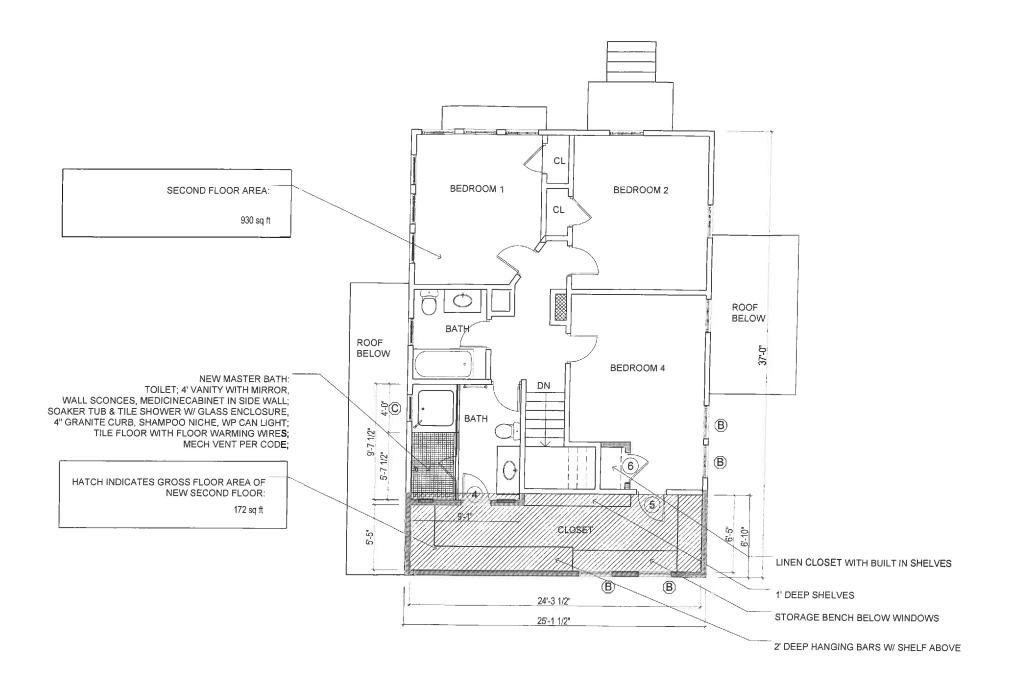

Date: Issued for:

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/18 PROWNESSED REVIEW

PO PROGRAD REVIEW



BONNAR RESIDENCE 61 WARWICK ROAD BELMONT MA 02478

NEW SECOND FLOOR PLAN

Sheet Number:

A9

1 PLAN SCALE: 1/8" = 1' DASHED LINE INDICATES PORTION OF ATTIC SPACE WITH CEILING HEIGHT OF 5' OR GREATER - 95 sq ft

HATCH INDICATES GROSS FLOOR AREA OF NEW ATTIC SPACE WITH CEILING HEIGHT OF 6' OR GREATER 10 sq ft

HALF STORY AREA CALCULATIONS:

SECOND FLOOR AREA = 930 SF

ALLOWABLE: MAX 558 SF W/ CEILING HEIGHT OF 5' OR GREATER (BASED ON 60% OF 930 SF SECOND FLOOR).

ACTUAL: 95 SF (AREA W/ CEILING HEIGHT OF 5' OR GREATER IS DESIGNATED BY SHORT DASHED LINES

HALF STORY PERIMETER CALCULATIONS:

SECOND FLOOR PERIMETER = 124'-3"

ALLOWABLE: MAX 62'-1 1/2" W/ RAFTER BOTTOMS AT 3' OR GREATER (BASED ON 50% OF 124'-3" PERIMETER).

ACTUAL: 8'-0"

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2/25/18 SCHEMATIC DESIGN
3/12/18 DESIGN DEVELOPMENT

8 PLANNING BD REVIEW

PRED ARC

GENERAL

Mo. 20146

SECROPORD

MA

BIOTHESIS


BONNAR RESIDENCE 61 WARWICK ROAD BELMONT MA 02478

NEW ATTIC FLOOR PLAN

Sheet

A10

1 PLAN SCALE: 1/8" = 1'

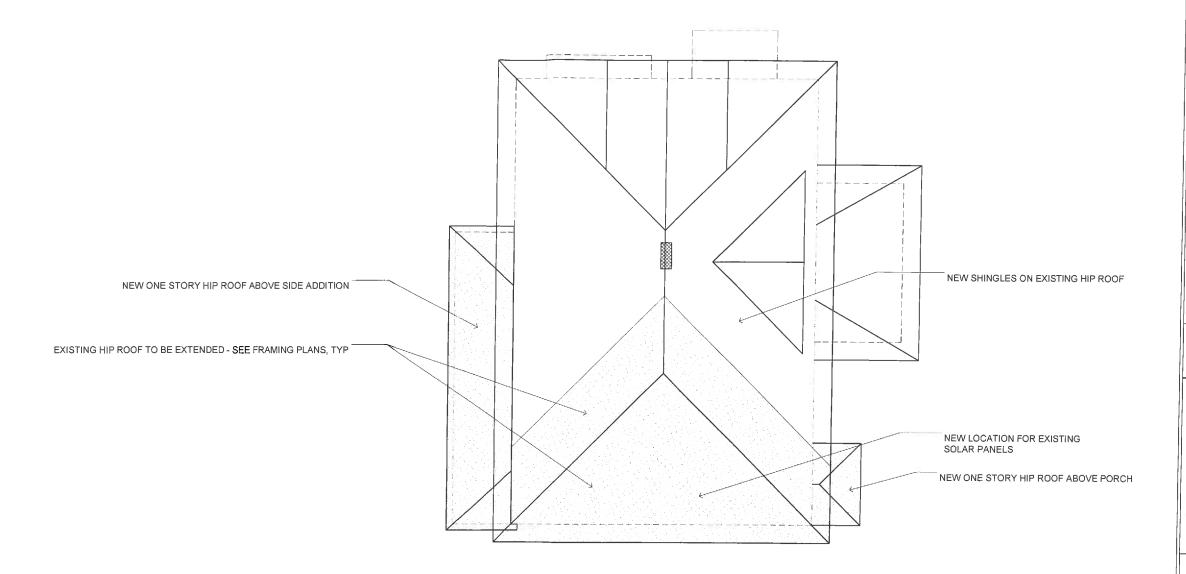

Date:

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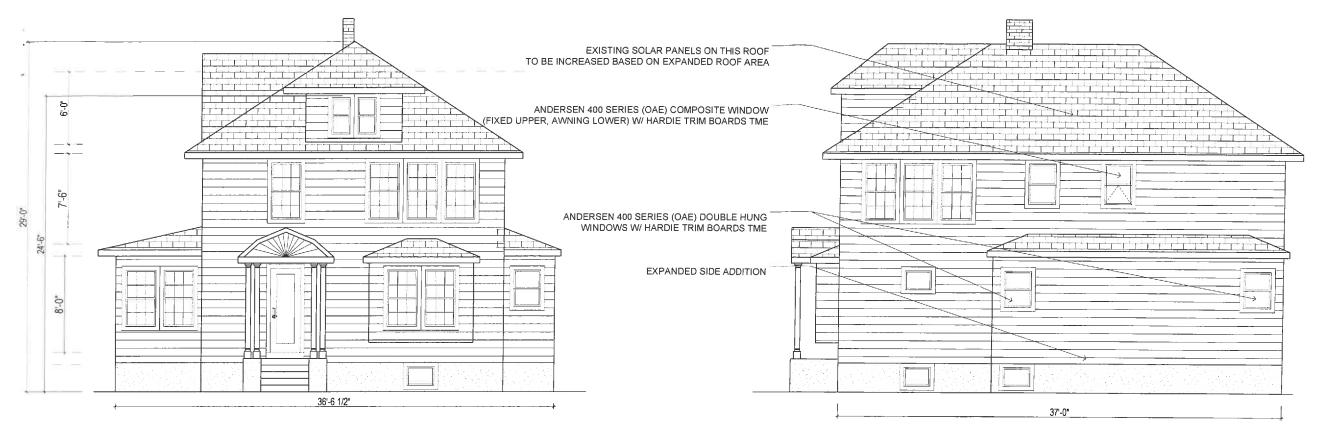
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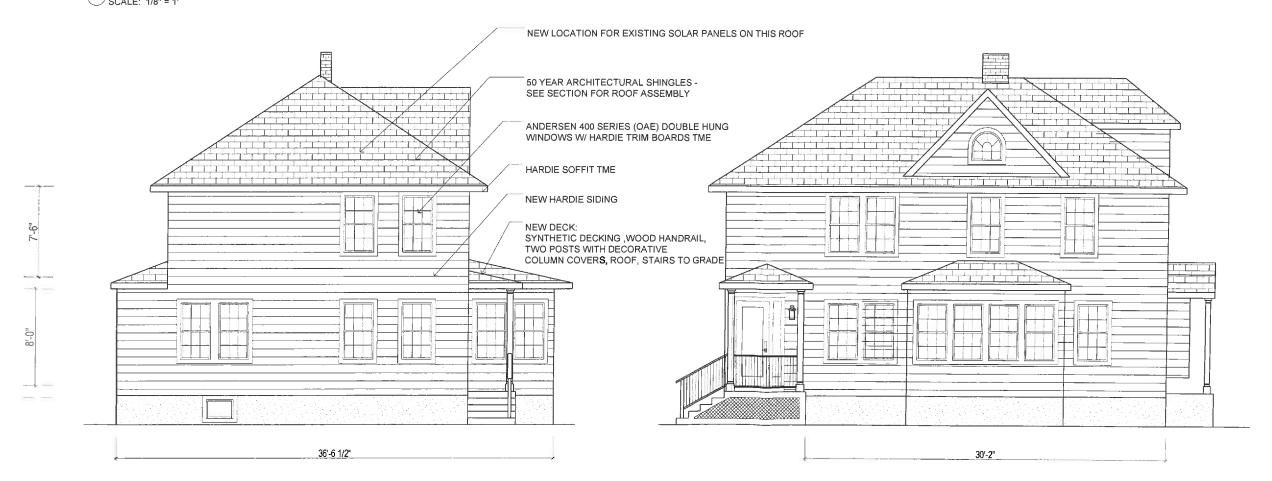
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NEW ROOF PLAN

Sheet Number:



1 REAR ELEVATION SCALE: 1/8" = 1'



Architect: Miller Design LLC 52 Statter Road Belmont MA 02478 617-993-3157

II 	
2/25/18	SCHEMATIC DESIGN
3/12/18	DESIGN DEVELOPMENT
7/9/18	PLANNING BD REVIEW
11/8/18	REVISIONS

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BONNAR RESIDENCE 61 WARWICK ROAD BELMONT MA 02478

NEW ELEVATIONS

Sheet