

# Town of Belmont Zoning Board of Appeals

## **APPLICATION FOR A SPECIAL PERMIT**

Date: Jul 11, 2017

Zoning Board of Appeals Homer Municipal Building 19 Moore Street Belmont, MA 02478	
To Whom It May Concern:	
Pursuant to the provisions of Massachuse	tts General Laws, Chapter 40A,
Section 9, as amended, and the Zoning By-Laws	of the Town of Belmont, I/we the
undersigned, being the owner(s) of a certain pard	cel of land (with the buildings thereon)
situated on63 BerwickSt	reet/Road, hereby apply to your Board
for a SPECIAL PERMIT for the erection or altera	tion on said premises or the use
thereof under the applicable Section of the Zonin	
construction of a screen wall on existing garage	
	ı
on the ground that the same will be in harmony	with the general purpose and intent of
said Zoning By-Law.	
	$\Omega$
Signature of Petitioner	latt S
Print Name	Carl Solander
Address	63 Berwick St, Apt 2
	Belmont, MA 02478
Daytime Telephone Number	617-331-2397



# OFFICE OF COMMUNITY DEVELOPMENT TOWN OF BELMONT

19 Moore Street Homer Municipal Building Belmont, Massachusetts 02478-0900

Telephone: (617) 993-2650 Fax: (617) 993-2651

Building Division (617) 993-2664 Engineering Division (617) 993-2665 Planning Division (617) 993-2666

July 17, 2017

Carl Solander 63 Berwick Street Belmont, MA 02478

RE: Denial to Construct a Screen Wall on garage.

Dear Mr. Solander,

The Office of Community Development is in receipt of your building permit application for your proposal to construct a screen wall on your garage at 63 Berwick Road located in a General Residence (GR) Zoning District.

Your application has been denied because it does not comply with the current Town of Belmont Zoning Bylaws. More specifically, Section 4.2 of the Zoning Bylaws Dimensional Regulations allows maximum lot coverage of 30% and requires a minimum of 5.0' side and rear setbacks for accessory buildings.

- 1. The existing lot coverage is 37.0% and the proposed is 37.8%.
- 2. The existing side setback of your garage is 2.0' and the proposed is 1.4'.
- 3. The existing rear setback of your garage is 1.5' and the proposed is 1.0'.

You may alter your plans to conform to the current Town of Belmont Zoning Bylaws and resubmit a building permit application, or you may request three (3) Special Permits from the Zoning Board of Appeals. If you choose this option, please contact the Office of Community Development to schedule an appointment with Ara Yogurtian, Assistant Director, at (617) 993-2650 in order to begin the process.

Sincerely,

Glenn R. Clancy, P.E. Inspector of Buildings

### **Project Statement: Application for Special Permit**

Property Address: 63 Berwick St, Belmont, MA Owners: Carl Solander and Gillian Feiner

We are seeking a special permit to construct a wooden screen over our existing garage. The screen projects approximately 6-1/2" from the roof and walls of the garage, and planting boxes will be inserted into this space between the screen and the wall so that greenery appears to grow out of the wall and roof. This screen will be an improvement to our property and the neighborhood. The garage is located near the corner of our property and is very visible from our home and the surrounding homes. The screen will transform what has been an every part and attractive feature. eyesore into an attractive feature.

- The screen in the form it has been designed has 3 major purposes:1. To enhance the appearance of the garage by creating a smooth and continuous wood surface which hides projecting elements such as gutters, downspouts, and electrical conduits. The depth and shape of the screen is determined primarily by the need to conceal the gutter, so the projection of the screen is not more substantial than the projection of a gutter.
  - 2. To promote sustainability. The depth of the screen will allow us to insert planter boxes into the screen. This is meant to be a modular green wall and roof system which contains plants. Green walls and roofs reduce the urban heat island effect and reduce stormwater runoff into the town's sewers. We propose to use thermally modified poplar for the screen which can be exposed to the weather without the use of chemical coatings. The gutters will be connected to rain barrels to collect rain water for irrigation.
  - 3. Improved performance and longevity. The existing garage had eaves which dripped water onto the fences on the property line, causing the support posts to rot rapidly. The renovated garage will have a gutter to prevent this, and the wood screen covers the gutter so it will not become clogged with leaves from the overhanging tree. Back-ventilation of wood cladding prolongs its life, and the screen will protect the roof and wall membranes from solar degradation.

### BERWICK

105.22

V

105.72

105.85

106.22

**\*** 105.97

15.2

105.81

105.68

(2) - 12" DECIDUOUS

105.45 ×

9

00

106.17

## STREET

PK NAIL FOUND

THRESHOLD

- ELEV=109.0

R 1 ELEV=126.9

ELEV=108.2

105.12

105.57

105.78

105.27

- ROOF AT EAVE

TOP OF FOUNDATION

- FI EV=104.24

103.56

105.14

WA

DRIVE

105.54

105.86

,00

00

103.42

EXIST PORCH

LOT 110

AREA =

5.000±S.F.

105.93

ြက

105/97

**REALTY TRUST** 

106.076

#### **RECORD OWNER:**

GILLIAN R. FEINER & CARL A. SOLANDER 63 BERWICK STREET #2, BELMONT, MA

#### REFERENCES:

**DEED BOOK 58792 PAGE 211** PLAN BOOK 91, PLAN 6

**ZONING:** 

GENERAL RESIDENCE

ASSESSOR: 1-132

TOP OF ROOF-ELEV=139.2

> N/F **JOLANE**

**REALTY TRUST** 

7.9' TO EXIST GAR

7.4' TO PROP SCREEN

### **ZONING TABLE:**

EXISTING PROPOSED REQUIRED LOT COVERAGE MAX 30% 37.0% 37.8% OPEN SPACE MIN. 40% 51.8% FRONTAGE 70 50 N/A N/A LOT AREA 5000 7000 FRONT SETBACK 12.6 N/A 20 REAR SETBACK 20 27.7 N/A ACC. REAR 1.0 1.5 SIDE SETBACK 10 8.1 N/A ACC. SIDE 5 2.0 1.4 HEIGHT 33 27.5 N/A STORIES 2.5 2.5 N/A 12.6 ACC. HEIGHT 12 15

50.9%

105.73 106.64 50.00 EXISTING ---1.5 EXIST GAR TOP OF ROOF 1.0' TO PROP SCREEN ELEV=121.0 **MARGARET MAHONEY** N/F & MARY WALLACE THE CALTHORPE

N/F

GARAGE

REMODEL

N/F

JOAN F. MAHER

LIVING TRUST

GAR FLOOR

ELEV=105.9

PURPORTED

ROOF EAVE

2.0 TO EXIST GAR

TO PROP SCREEN

PAUL & EUNICE LAFFEY

#### NOTES:

- 1.) THIS PLAN WAS PREPARED TO SHOW EXISTING DWELLING RELATIVE TO PROPERTY LINES AND PROPOSED GARAGE. EXISTING GARAGE UNDER RENOVATION.
- 2.) THE PLAN WAS PREPARED BY PERFORMING AN INSTRUMENT SURVEY IN APRIL OF 2017.
- 3.) NO UTILITY LOCATION, RESEARCH OR PLOTTING PERFORMED.
- 4.) NO TITLE EXAMINATION PROVIDED, THEREFORE OTHER EASEMENTS NOT SHOWN HEREON COULD EXIST.
- 5.) EXISTING LOT COVERAGE = 37.0%; PROPOSED 37.8%
- 6.) EXISTING OPEN SPACE = 51.8%; PROPOSED 50.9%
- 7.) VERTICAL DATUM: ASSUMED
- 8.) BASEMENT FLOOR ELEVATION = 100.78
- 9.) LOT IS IN ZONE X OF FEMA MAP NO. 25017C04183 WITH DATE OF 6-4-2010.



### PLOT PLAN

OF LAND IN

### BELMONT, MASSACHUSETTS

AT 63 BERWICK STREET

PREPARED FOR


### **CARL SOLANDER**

BY

### SUMMIT SURVEYING INC.

4 S. POND STREET, NEWBURYPORT, MA 01950 TEL. 978-692-7109

CBRENNAN@SUMMITSURVEYINGINC.COM

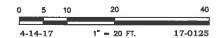


SHEET 1 OF 2

# HOUSE AVERAGE GRADE CALCULATION:

					AVG X	LEN
SEGMENT 1						
SEGMENT 2						ŀ
SEGMENT 3						
SEGMENT 4	105.9	105.9	105.9	20.4	2160.3	
SECMENT 5						
SEGMENT 6	106.2	105.7	105.98	41.8	4428.7	
SEGMENT 7	105.7	105.2	105.45	17.6	1855.9	

SEGMENT 8 105.2 104.9 105.05 28.4 2773.3


SUM OF SEGMENTS = 18145.8 PERIMETER = 171.8 AVERAGE PLANE = 105.6

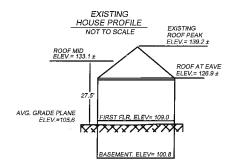

# GARAGE AVERAGE GRADE CALCULATION:

	EL 1	EL 2	AVG. I	LENGTH	AVG X	LENGT
SEGMENT 1						
SECMENT 2						
SEGMENT 3	105.3	105.7	105.5	21.2	2236.6	
SEGMENT 4	105.7	106.0	105.9	19.2	2033.3	

SUM OF SEGMENTS = 8542.5 PERIMETER = 80.8 AVERAGE PLANE = 105.7

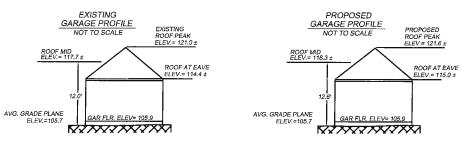

#### LOT COVERAGE AND OPEN SPACE CALCS.

EXISTING LOT COVERAGE = 37.0%

= (1325+148+369+5)/5000 = 36.96% HOUSE+PORCH+GARAGE+LANDING / TOTAL AREA

PROPOSED LOT COVERAGE =37.8%

= (1326+148+413+5)/5000 = 37.84% HOUSE+PORCH+NEW GARAGE+LANDING / TOTAL AREA

#### EXISTING OPEN SPACE = 51.8%

[5000-(1326+148+369+5+562)]/5000 = 51.80% HOUSE+PORCH+GARAGE+LANDING+DRIVEWAY

#### PROPOSED OPEN SPACE = 50.9%

[5000-(1326+148+413+5+562)]/5000 = 50.92% HOUSE+PORCH+NEW GARAGE+LANDING+DRIVEWAY



### **PLOT PLAN**

OF LAND IN

### BELMONT, MASSACHUSETTS

AT 63 BERWICK STREET

PREPARED FOR


### **CARL SOLANDER**

BY

### SUMMIT SURVEYING INC.

4 S. POND STREET, NEWBURYPORT, MA 01950 TEL. 978-692-7109

CBRENNAN@SUMMITSURVEYINGINC.COM

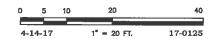

SHEET 2 OF 2



# Zoning Compliance Check List (Registered Land Surveyor)

7 Property Address: 63 Berwick St.

Zone: GR

Surveyor Signature and Stamp: \_

Date: 7-11-17

PLS # 47135

	REQUIRED	EXISTING	PROPOSED
Lot Area	7000 SF	5000 S.F.	5000 S.F.
Lot Frontage	70 SF.	SO ST.	56 S.F.
Floor Area Ratio	40 % (MAK)	26.6%	29.7 %
Lot Coverage	30 % (MAK)	37%	37.8%
Open Space	40% (min)	51.8%	50.9%
Front Setback	N/A		
Side Setback	5' (sw)	27.7'	77.2'
Side Setback	5' (NE)	7.0'	1.4'
Rear Setback	5'	1.5'	1.0'
Building Height	15'	12'	12.6'
Stories	1	1	1
½ Story Calculation	NIA		

NOTES:
SET BACKS HEIGHT STORIES AND FAR ARE CALCULATED
FOR THE GARAGE (ACCESSORY BUILDING). INCLUDED
UNDER FAR IS THE CHCULATION FOR % OF BACK YAR!
COVERED BY ACCESSORY BUILDING FROM PONING BYLAU
4.3.5 C1.1



### EXISTING VIEW FROM SECOND-FLOOR PORCH




### PROPOSED VIEW FROM SECOND-FLOOR PORCH




### EXISTING VIEW FROM DRIVEWAY





### PROPOSED VIEW FROM DRIVEWAY

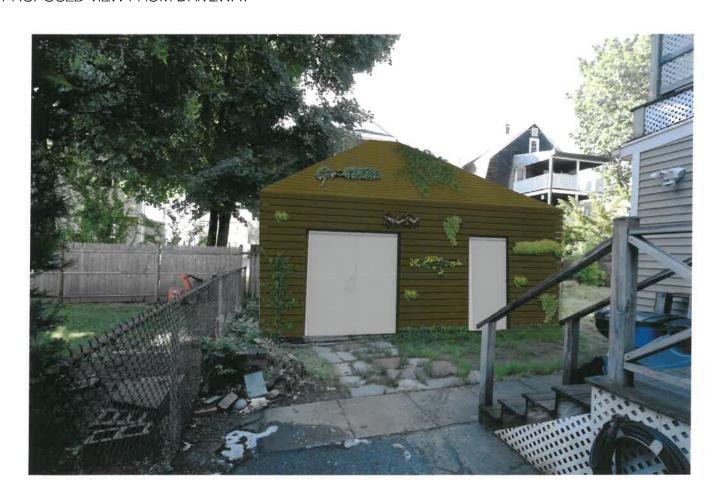

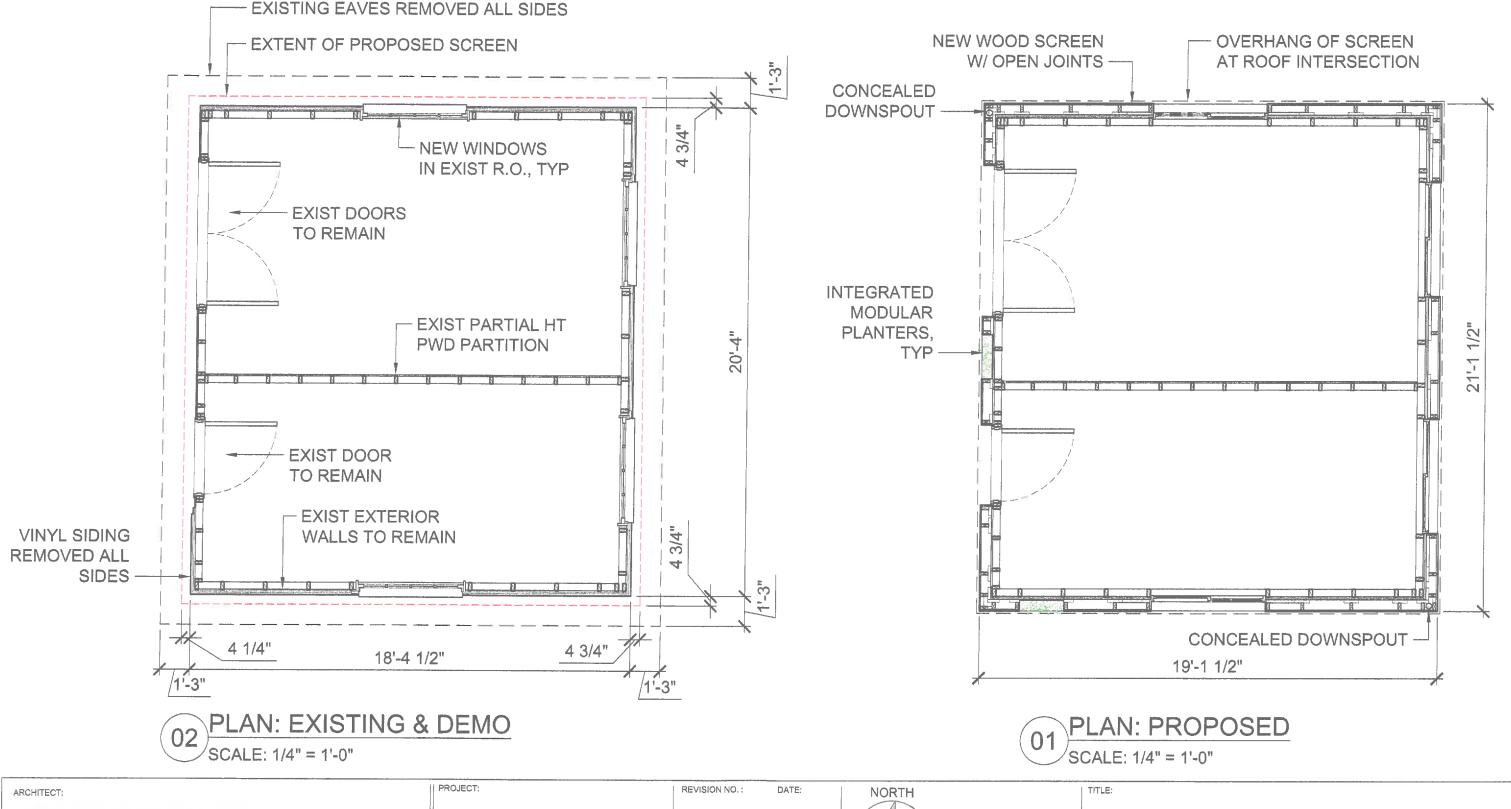

F-S GARAGE PLANS: EXIST AND PROPOSED 561 WINDSOR ST. #A304 SOMERVILLE, MA 02143 ph / f: 617.440.3622 info@reversearchitecture.com CARL SOLANDER DRAWN BY: PHASE: DATE: SECTION: www.reversearchitecture.com 63 BERWICK ST. Belmont, MA 02478-3641 4/28/2017 **PERMIT** CHECKED BY: SCALE: CS 1/2" = 1'-0"

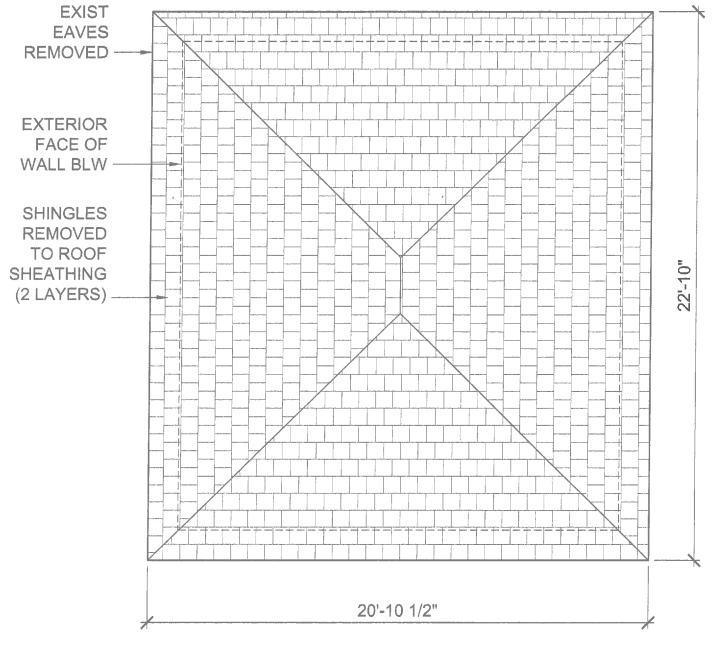

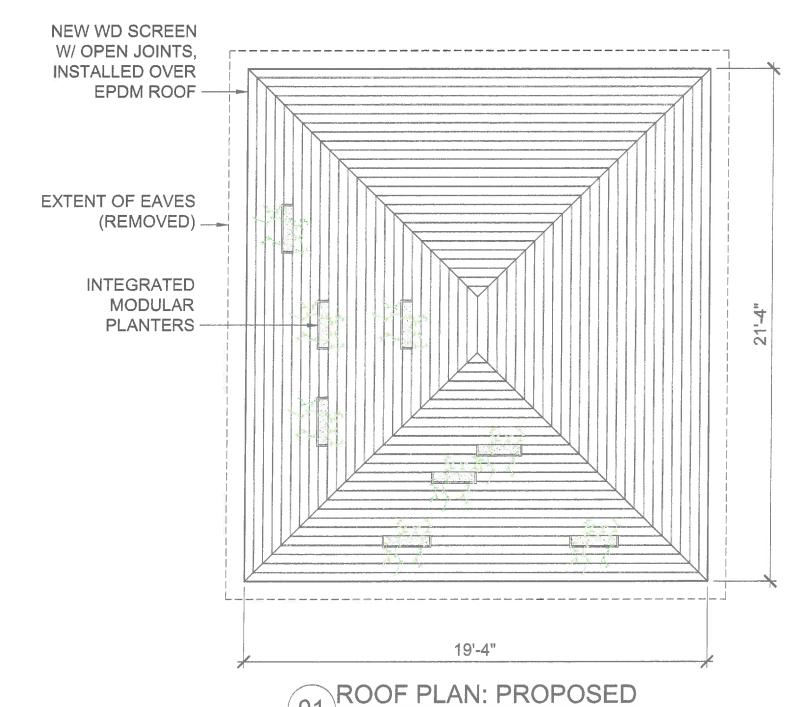

02 ROOF PLAN: EXISTING & DEMO SCALE: 1/4" = 1'-0"

ARCHITECT:

561 WINDSOR ST. #A304 SOMERVILLE, MA 02143 ph / f: 617.440.3622 info@reversearchitecture.com www.reversearchitecture.com

F-S GARAGE

CARL SOLANDER 63 BERWICK ST. Belmont, MA 02478-3641

NORTH

REVISION NO.:

DRAWN BY: | DATE: TR 4/28/2017


CHECKED BY: SCALE: 1/2" = 1'-0" CS


**ROOF PLANS: EXIST AND PROPOSED** 


PHASE:

**PERMIT** 

SCALE: 1/4" = 1'-0"

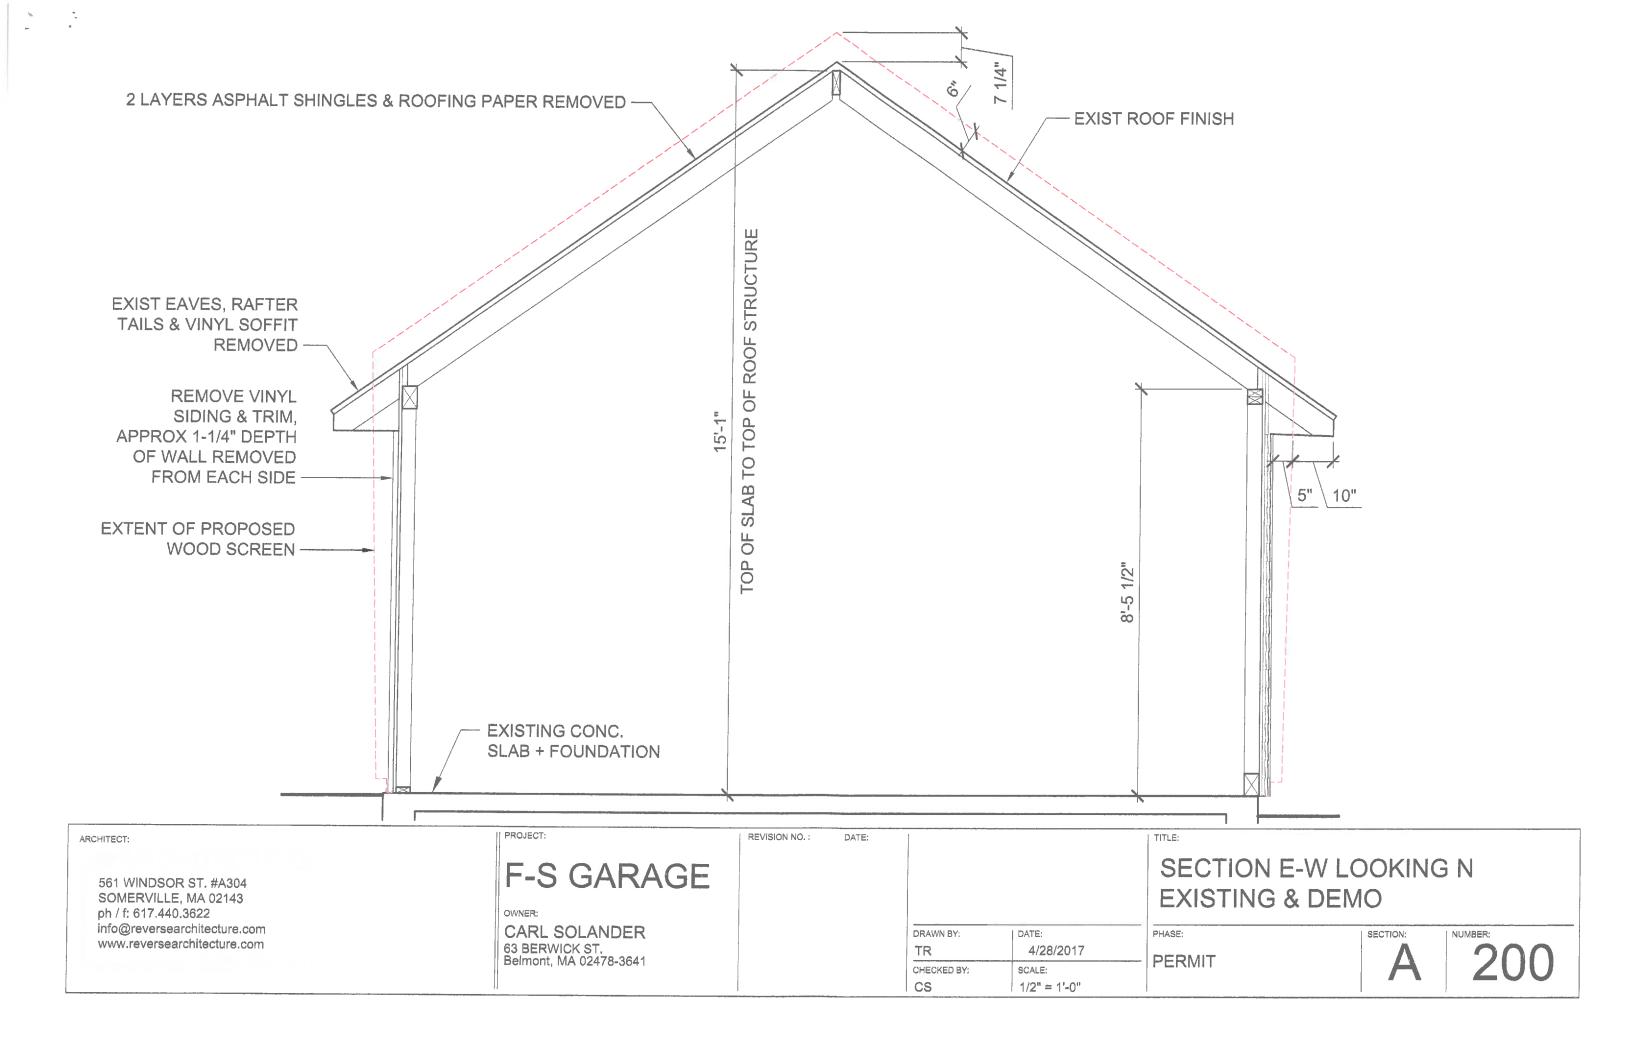

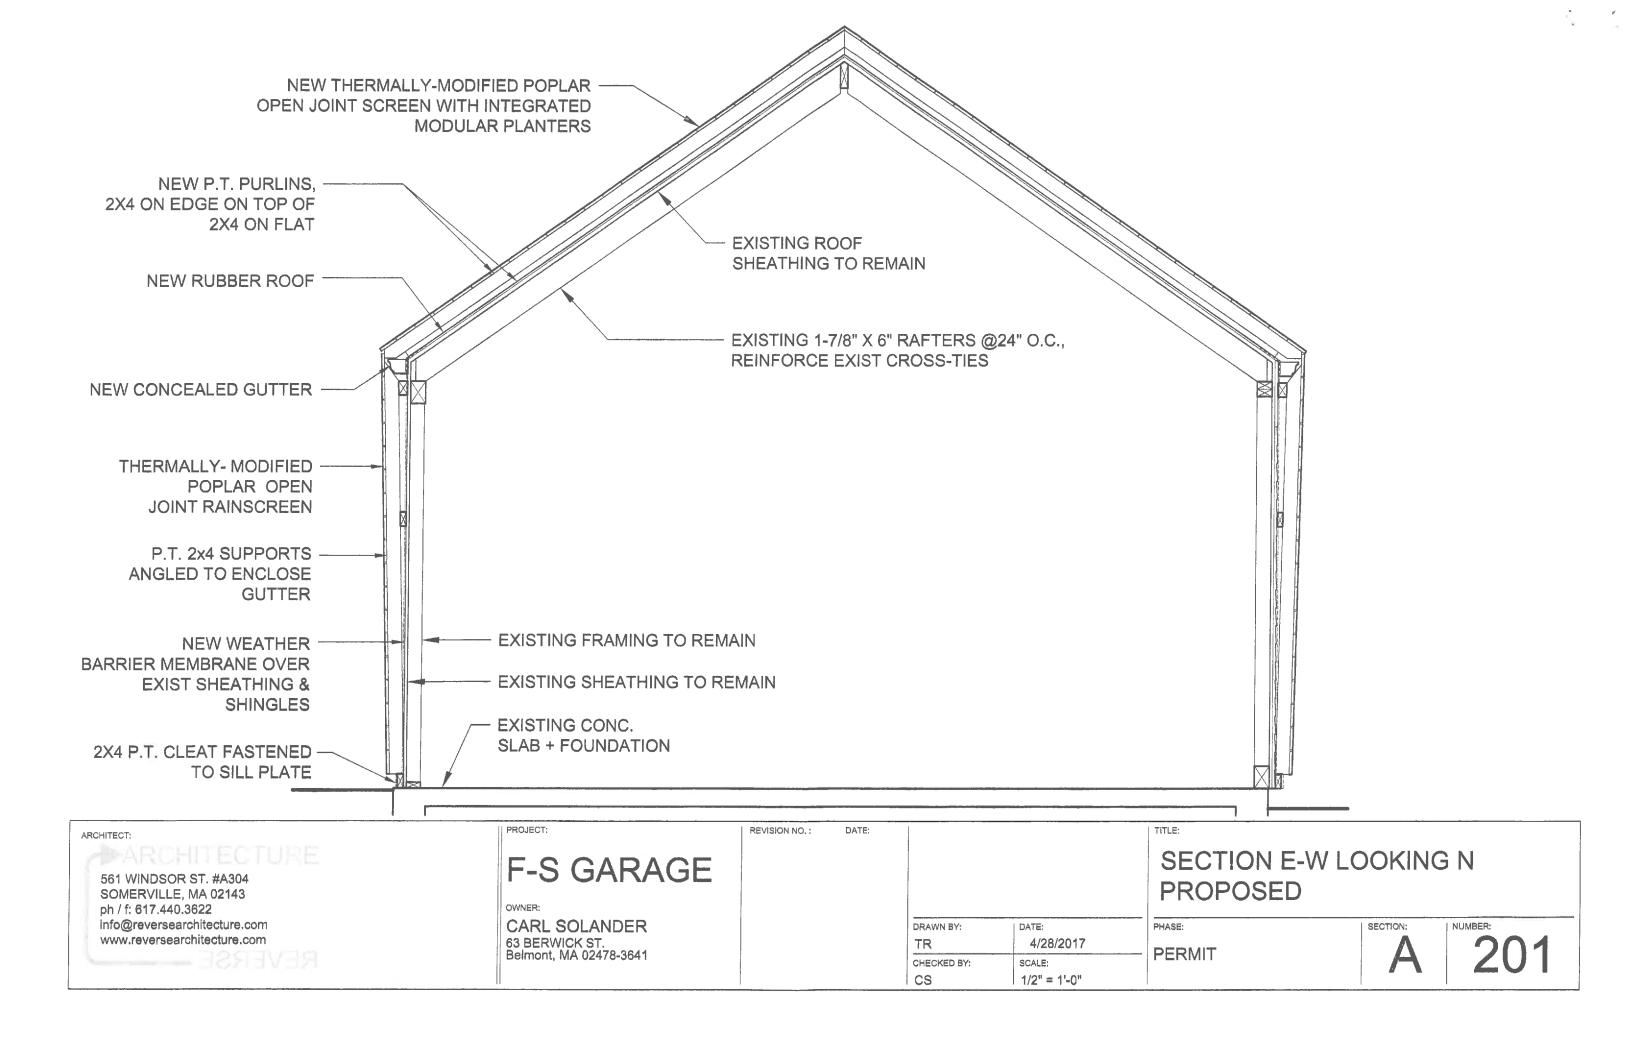


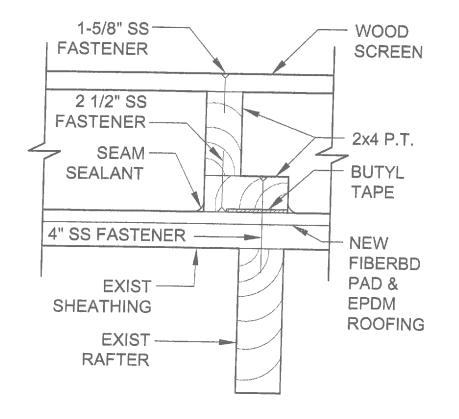

**EXIST WD SHINGLES** 2X4 FRAME FOR SCREEN - WD SCREEN W/ OPEN JOINTS DRAINAGE CONC PLANE SLAB 2X4 PT CLEAT. FLASHED 4 1/4" 

SECTION @ RAFTER SCALE: 3" = 1'-0"

SECTION @ SCREEN BASE SCALE: 1-1/2" = 1'-0"

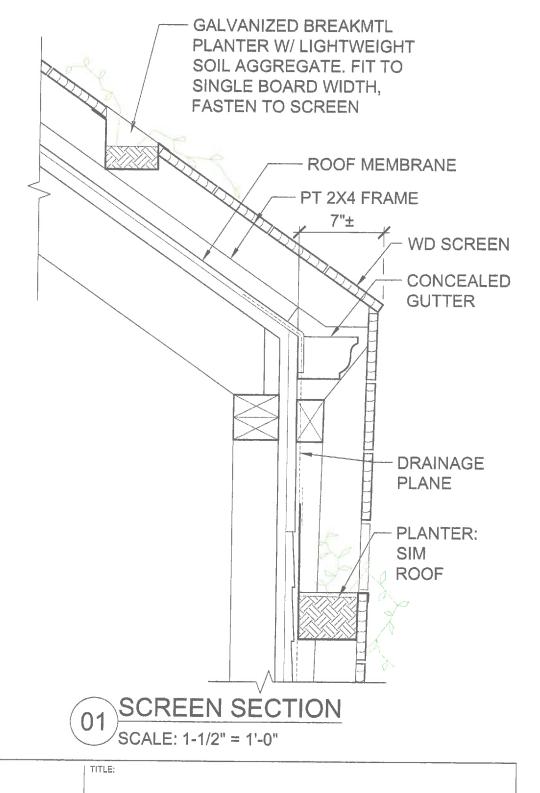

561 WINDSOR ST. #A304 SOMERVILLE, MA 02143 ph / f: 617.440.3622 info@reversearchitecture.com www.reversearchitecture.com

ARCHITECT:

F-S GARAGE


PROJECT:

CARL SOLANDER 63 BERWICK ST. Belmont, MA 02478-3641 REVISION NO.: DATE:


DRAWN BY: TR 4/28/2017 PERMIT CHECKED BY: SCALE: CS AS NOTED

SECTION DETAILS

PHASE:

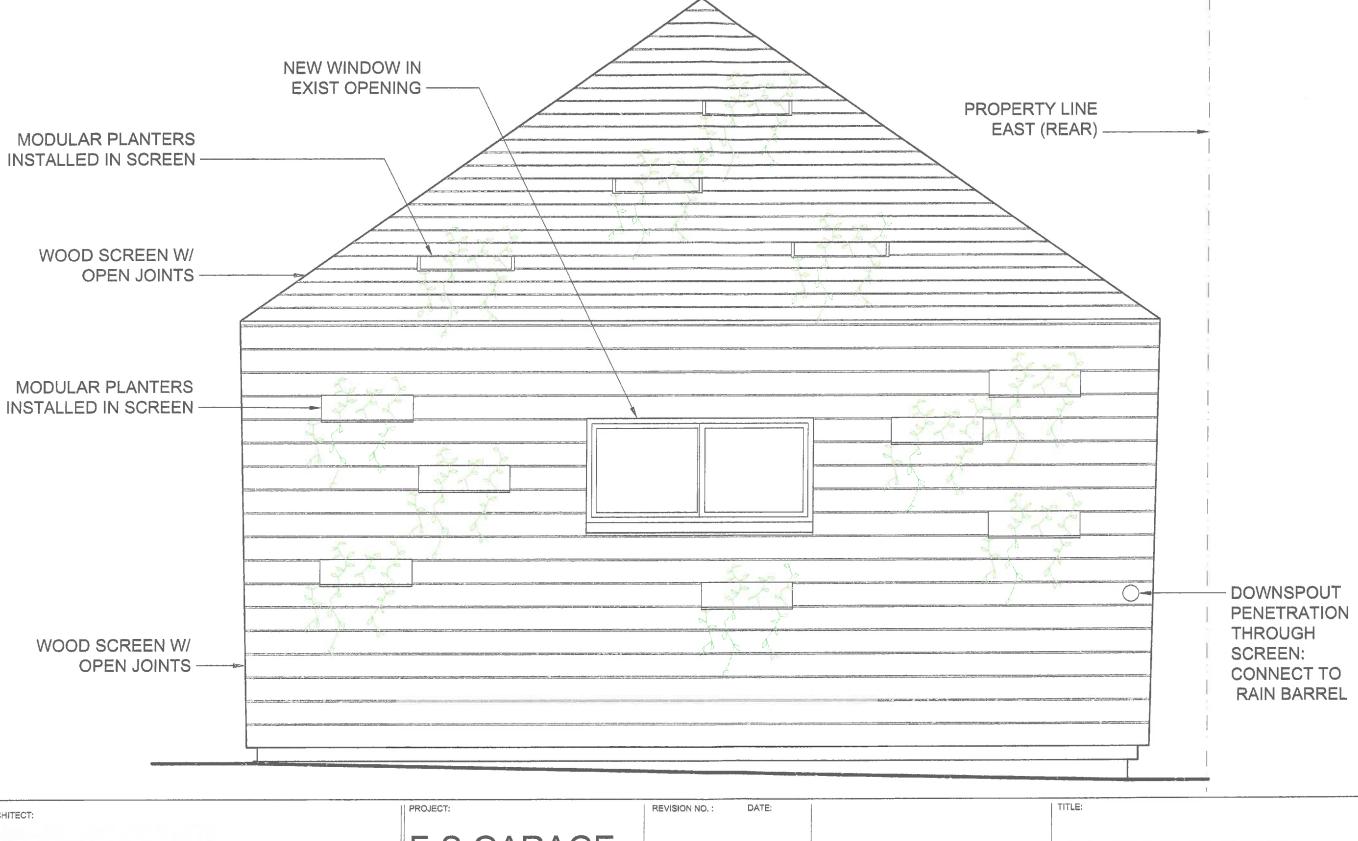

ARCHITECT: F-S GARAGE **SOUTH ELEVATION** 561 WINDSOR ST. #A304 SOMERVILLE, MA 02143 ph / f: 617.440.3622 info@reversearchitecture.com CARL SOLANDER DRAWN BY: DATE: PHASE: www.reversearchitecture.com 63 BERWICK ST. Belmont, MA 02478-3641 4/28/2017 TR PERMIT CHECKED BY: SCALE: 1/2" = 1'-0" CS

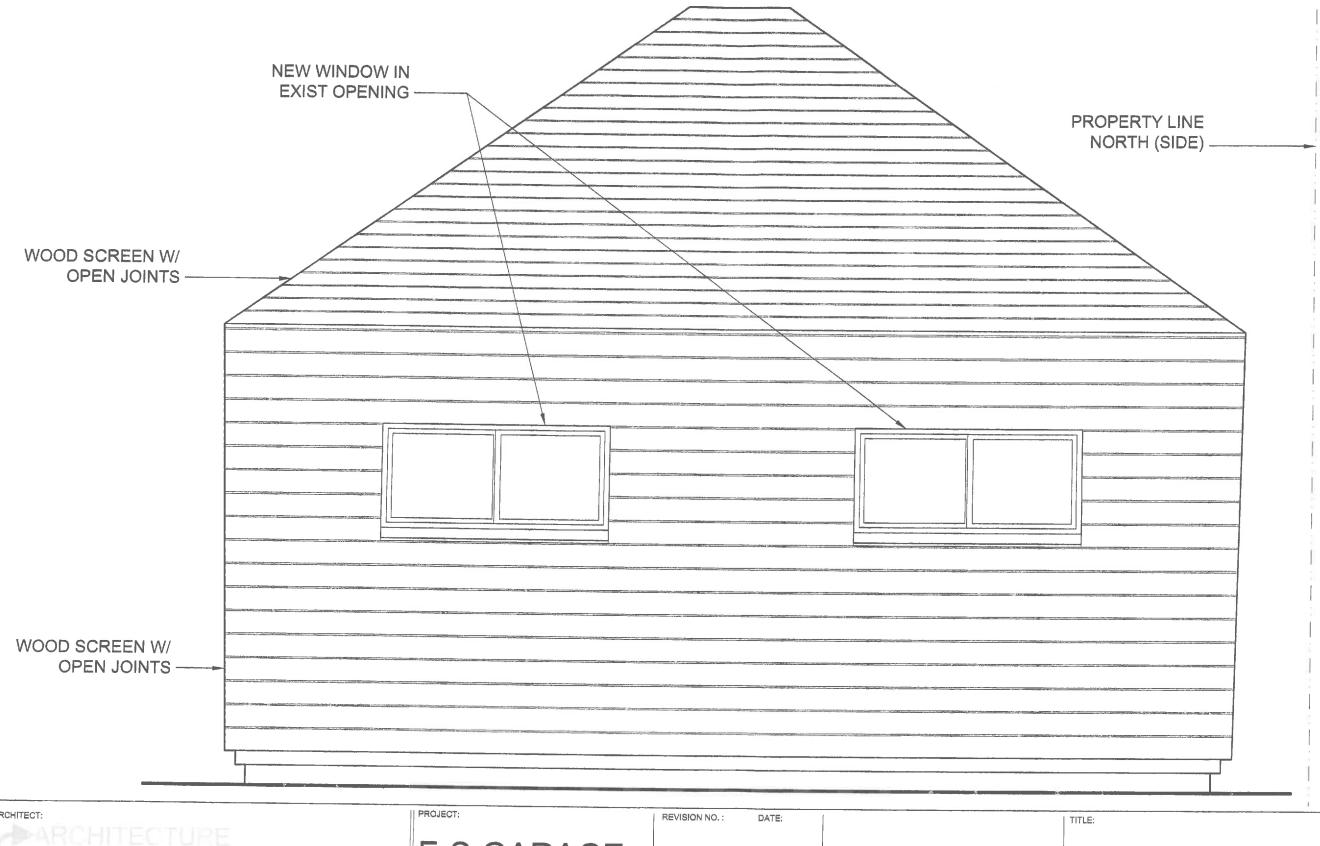

ARCHITECT:

561 WINDSOR ST. #A304 SOMERVILLE, MA 02143 ph / f: 617.440.3622 Info@reversearchitecture.com www.reversearchitecture.com


F-S GARAGE

CARL SOLANDER 63 BERWICK ST. Belmont, MA 02478-3641 DRAWN BY: DATE: PHASE: TR 4/28/2017 PERMIT CHECKED BY:

1/2" = 1'-0"

CS

**EAST ELEVATION** 

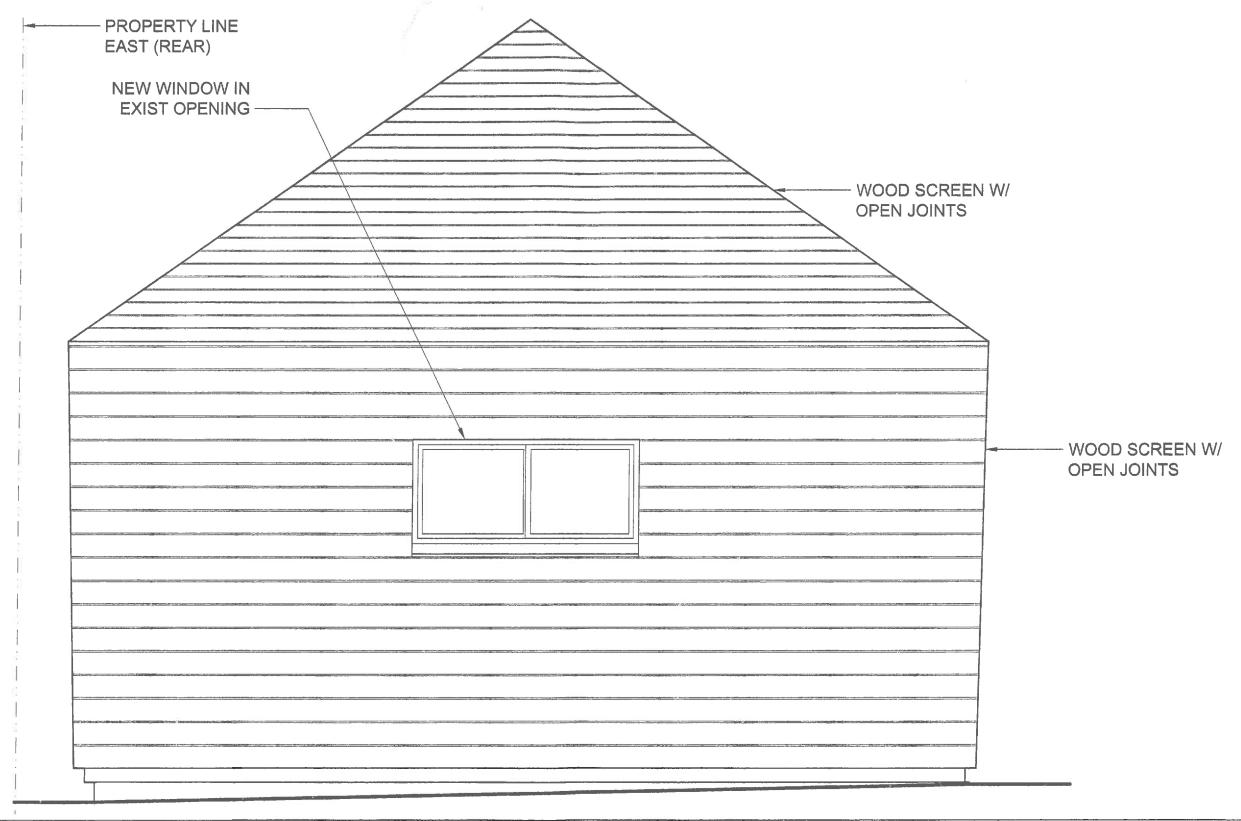

REVISION NO. : DATE: F-S GARAGE **NORTH ELEVATION** 561 WINDSOR ST. #A304 SOMERVILLE, MA 02143 ph / f: 617.440.3622 CARL SOLANDER info@reversearchitecture.com DRAWN BY: DATE: PHASE: www.reversearchitecture.com 63 BERWICK ST. Belmont, MA 02478-3641 4/28/2017 TR PERMIT CHECKED BY: 1/2" = 1'-0" CS



PROJECT: ARCHITECT: F-S GARAGE WEST ELEVATION 561 WINDSOR ST. #A304 SOMERVILLE, MA 02143 ph / f: 617.440.3622 PHASE: DRAWN BY: DATE: CARL SOLANDER info@reversearchitecture.com 213 4/28/2017 63 BERWICK ST. Belmont, MA 02478-3641 TR www.reversearchitecture.com **PERMIT** CHECKED BY: SCALE: 1/2" = 1'-0" CS