

Comprehensive Land Holdings, LLC

August 12, 2020

VIA ELECTRONIC MAIL

Ms. Jessica Malcolm Mr. Mike Busby MassHousing One Beacon St Boston, MA 02108

RE: Application for Site Eligibility – 91 Beatrice Circle

Dear Ms. Malcolm and Mr. Busby:

On behalf of 91 Beatrice Circle, LLC, we are pleased to provide the attached supplement to the Application for Site Eligibility submitted to MassHousing on May 12, 2020, for the Chapter 40B project at 91 Beatrice Circle, Belmont, MA.

Per feedback during the Site Approval process and our discussions with MassHousing to date, we have adjusted the building design and massing to address concerns with the original layout. Based on these changes, we have also updated the project's pro forma.

Enclosed please find electronic copies of:

- Revised MassHousing Comprehensive Permit Site Approval Application pages 4, 9-10, 14-19
- Updated Architectural Plans
- Narrative Summary of Architectural Revisions
- Updated Civil Engineering Plans

Please do not hesitate to contact me if you have any questions.

Sincerely,

Joe Tamposi 91 Beatrice Circle, LLC

CC: Town of Belmont Select Board Jeffrey Wheeler, Town Planner



Comprehensive Permit Site Approval Application/Rental

www.masshousing.com | www.masshousingrental.com

Additional Contact Information (optional)
Name of Individual:
Relationship to Applicant:
Name of Company (if any):
Street Address:
City/Town/Zip:
Telephone (office and cell) and Email:
Anticipated Construction Financing: MassHousing NEF Bank If NEF Bank, Name of Bank:
Anticipated Permanent Financing: MassHousing NEF Bank If NEF Bank, Name of Bank:
Total Number of Units # Affordable Units # Market Rate Units Age Restricted? Yes/No If Yes, 55+ or 62+?
Brief Project Description (150 words or less):

Brief Project Description (150 words or less):

Required Attachments Relating to Section 1

1.1 Location Map

Provide a USGS or other form of map clearly marked to show the site's location, and an approximate property boundary.

1.2 Tax Map

Provide a copy of municipal tax map (assessor's plan) with subject parcels and parcel ID #'s clearly identified.

1.3 Directions

Provide detailed written directions to the site, noting the entrance to the site, relevant boundaries and any prominent landmarks that can be used for identification purposes.

Application for Chapter 40B Project Eligibility/Site Approval

for MassHousing-Financed and New England Fund ("NEF") Rental Projects

Section 3: PROJECT INFORMATION	(also see Required Attachments listed at end of Section 3)
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In order to issue Site Approval, MassHousing must find (as required by 760 CMR 56.04 (4)) that the proposed project appears
generally eligible under the requirements of the housing subsidy program and that the conceptual project design is generally
appropriate for the site.

generally eligible under the appropriate for the site.	e requirements of	the housing subsic	ly program and that	the conceptual proj	ect design is generally
Name of Proposed Proje	ect:				
Project Type (mark both	if applicable): Nev	v Construction _	Rehabilitati	on Both _	
Total Number of Dwelli	ng Units:				
Total Number of Afford	able Units:	_			
Number of 50% AMI	Affordable Units:	:			
Number of 80% AMI	Affordable Units:	:			
Number of Market Rate	: Units:				
Unit Mix: Affordable Un	nits				
Unit Type	Studio	1 Bedroom	2 Bedroom	3 Bedroom	4 Bedroom
Number of Units					
Number of Bathrooms					
Square Feet/Unit					
Unit Mix: Market Rate					
Unit Type	Studio	1 Bedroom	2 Bedroom	3 Bedroom	4 Bedroom
Number of Units					
Number of Bathrooms					
Square Feet/Unit					
Percentage of Units wit			ding Hayaing Opposi	www.ikioo.fow.Fownilioo	with Children requires that
	in the Project mus				with Children requires that with this requirement mus
Number of Handicappe		s: Market	Rate: Affo	ordable:	
Gross Density (units per	r acre):				
Net Density (units per b	ouildable acre): _				

Residential Building Information					
Building Type and Style (single family detached, townhouse, multi-family)	Construction or Rehabilitation	Number of Stories	Height	GFA	Number Bldgs. of this type

(single family detached, townhouse, multi-family) Renabilitation of Stories of this type

Non-Residential Building Information

Building Type and Style	Construction or Rehabilitation	Number of Stories	Height	GFA	Number Bldgs. of this type

Will all features and amenities available to market unit residents also be available to affordable unit residents? If not, explain the differences.

Parking

· ······g
Total Parking Spaces Provided:
Ratio of Parking Spaces to Housing Units:
Lot Coverage (Estimate the percentage of the site used for the following)
Buildings:
Parking and Paved Areas:
Usable Open Space:
Unusable Open Space:
Lot Coverage:
Does project fit definition of "Large Project" (as defined in 760 CMR 56.03 (6))? Yes/No
DUCS DIDICCE HE UCHINICUL DE LATUCE FOICCE LAS UCHNEU III 700 CIVIN 30.03 1011! TCS/NO

Application for Chapter 40B Project Eligibility/Site Approval

for MassHousing-Financed and New England Fund ("NEF") Rental Projects

Section 5: FINANCIAL INFORMATION - Site Approval Application Rental 40B

In order to issue Site Approval, MassHousing must find (as required by 760 CMR 56.04 (4)) that an initial pro forma has been reviewed and that the Proposed Project appears financially feasible and consistent with the Chapter 40B Guidelines, and that the Proposed Project is fundable under the applicable program.

Name of Proposed Project:	

Initial Capital Budget (please enter "0" when no such source or use is anticipated)

Sources

Description	Source	Budgeted
Private Equity	Owner's Cash Equity	
Private Equity	Tax Credit Equity	
Private Equity	Developer Fee Contributed or Loaned	
Private Equity	Developer Overhead Contributed or Loaned	
Other Private Equity		
Public/Soft Debt		
Subordinate Debt		
Permanent Debt		
Permanent Debt		
Construction Debt	For informational purposes only, not to be included in Sources total	
Additional Source (please identify)		
Additional Source (please identify)		
Total Sources		\$

Pre-Permit Land Value, Reasonable Carrying Costs

Item	Budgeted
Site Acquisition: pre-permit land value (to be determined by MassHousing commissioned appraisal) plus reasonable carrying costs.	

Uses (Costs)

. ,		
ltem	Budgeted	
Acquisition Cost (Actual)		
Actual Acquisition Cost: Land		
Actual Acquisition Cost: Buildings		
Subtotal Acquisition Costs		
Construction Costs-Building Structural Costs (Hard Costs)		
Building Structure Costs Hard Cost Contingency		
Subtotal – Building Structural Costs (Hard Costs)		
Construction Costs-Site Work (Hard Costs)		
Earth Work		
Utilities: On Site		
Utilities: Off-Site		-
Roads and Walks		_
Site Improvement		-
Lawns and Planting		-
Geotechnical Condition		-
Environmental Remediation		
Demolition		
Unusual Site Conditions/Other Site Work		-
Subtotal –Site Work (Hard Costs)		
Construction Costs-General Conditions, Builders Overhead and Profit (Hard Costs)		
General Conditions		
Builder's Overhead		
Builder's Profit		
Subtotal – General Conditions Builders Overhead and Profit (Hard Costs)		
General Development Costs (Soft Costs)		
Appraisal and Marketing Study (not 40B "as is" appraisal)		
Marketing and Initial Rent Up (include model units, if any)		
Real Estate Taxes (during construction)		
Utility Usage (during construction)		
Insurance (during construction)		
Security (during construction)		
Inspecting Engineer		

Budgeted

	buagetea
General Development Costs (Soft Costs) - Continu	red
Fees to Others	
Construction Loan Interest	
Fees to Construction Lender	
Fees to Permanent Lender	
Architecture/Engineering	
Survey, Permits, etc.	
Clerk of the Works	
Construction Manager	
Bond Premiums (Payment/Performance/Lien Bond)	
Environmental Engineer	
Legal	
Title (including title insurance) and Recording	
Accounting and Cost Certification (incl. 40B)	
Relocation	
40B Site Approval Processing Fee	
40B Technical Assistance/Mediation Fund Fee	
40B Land Appraisal Cost (as-is value)	
40B Final Approval Processing Fee	
40B Subsidizing Agency Cost Certification	
Examination Fee	
40B Monitoring Agent Fees	
MIP	
Credit Enhancement	
Letter of Credit Fees	
Other Financing Fees: Tax Credit Allocation Fee	
Other Financing Fees	
Development Consultant	
Other Consultants (describe)	
Other Consultants (describe)	
Syndication Costs	
Soft Cost Contingency	
Other Development (Soft) Costs	
Subtotal – General Development Costs (Soft Costs)	
Developer Fee and Overhead	
Developer Fee	
Developer Overhead	
Subtotal – Developer Fee and Overhead	
Capitalized Reserves	
Development Reserves	
Initial Rent-Up Reserves	
Operating Reserves	
Net Worth Account	
Other Capitalized Reserves	
Subtotal – Capitalized Reserves	16

Summary of Subtotals

Item	Budgeted
Acquisition: Land	
Acquisition: Building	
Building Structural Costs (Hard Costs)	
Site Work (Hard Costs)	
General Conditions, Builder's Overhead, Profit (Hard Costs)	
Developer Fee and Overhead	
General Development Costs (Soft Costs)	
Capitalized Reserves	
Total Development Costs (TDC)	
Summary	
Total Sources	
Total Uses (TDC)	
Projected Developer Fee and Overhead*:	
Maximum Allowable Developer Fee and Overhead**: _	

Projected Developer Fee and Overhead equals _____% of Maximum Allowable Fee and Overhead

^{*} Note in particular the provisions of Section IV.B.5.a of the Guidelines, which detail the tasks (i) for which a developer may or may not receive compensation beyond the Maximum Allowable Developer Fee and Overhead and (ii) the costs of which must, if the tasks were performed by third parties, be included within the Maximum Allowable Developer Fee and Overhead.

^{**} Please consult the most recent DHCD Qualified Allocation Plan (QAP) to determine how to calculate the Maximum Allowable Developer Fee and Overhead. If you have questions regarding this calculation, please contact MassHousing.

Initial Unit/Rent Schedule

Affordable Units @ 80% AMI	Studio	1 Bedroom	2 Bedroom	3 Bedroom	4 Bedroom
Number of Units					
Number Square Feet					
Monthly Rent					
Utility Allowance					

Affordable Units @ 50% AMI	Studio	1 Bedroom	2 Bedroom	3 Bedroom	4 Bedroom
Number of Units					
Number Square Feet					
Monthly Rent					
Utility Allowance					

Describe utility allowance assumptions (utilities to be paid by tenants):

Market Rate Units	Studio	1 Bedroom	2 Bedroom	3 Bedroom	4 Bedroom
Number of Units					
Number Square Feet					
Monthly Rent					

Initial Rental Operating Pro-Forma (for year one of operations)

Item	Notes	Amount
Permanent Debt Assumptions		
Loan Amount	Lender:	
Annual Rate		
Term		
Amortization		
Lender Required Debt Service Coverage Ratio		
Gross Rental Income		
Other Income (utilities, parking)		
Less Vacancy (Market Units)	5% (vacancy rate)	
Less Vacancy (Affordable Units)	5% (vacancy rate)	
Gross Effective Income		
Less Operating Expenses	Per Unit:	
Net Operating Income		
Less Permanent Loan Debt Service		
Cash Flow		
Debt Service Coverage		

Rental Operating Expense Assumption

Item	Notes	Amount
Assumed Maximum Operating Expenses	Calculated based on Net Operating Income, Debt Service and required Debt Service Coverage listed above.	
Assumed Maximum Operating Expense/Unit*	Number of Units:	

^{*} MassHousing may request further detail regarding projected operating expenses if such expenses appear higher or lower than market comparables.

91 BEATRICE CIRCLE

BELMONT, MA

AUGUST 11, 2020 PEL SUBMISSION



91 BEATRICE CIRCLE		
UNITS	COUNT	SF
unit type a (4-story)	8	1800 SF TYP.
unit type b (2-story)	4	1700 SF TYP.
PARKING		
Surface parking	8	
GARAGE PARKING	12	
TOTAL PARKING	20	
PARKING RATIO	1.67	

PROJECT DESCRIPTION

THE PROPOSED PROJECT AT 91 BEATRICE CIRCLE WILL REPLACE AN EXISTING RESIDENTIAL STRUCTURE AND ACCESSORY BUILDINGS WITH A MULTIFAMILY TOWNHOUSE RENTAL DEVELOPMENT CONSISTING OF 12 RENTAL UNITS

THE STRUCTURE WILL CONSIST OF (1) ROW OF 4-STORY TOWNHOUSES AND (1) ROW OF DETACHED 2-STORY RESIDENTIAL DWELLING UNITS WITH THE VEHICLE ACCESS AISLE IN THE CENTER. THE UNITS WILL BE SLAB ON GRADE WITH A DEDICATED PARKING SPACE AND LAUNDRY UNITS INCLUDED WITHIN THE INVIDIVIDUAL UNITS. 8 ADDITIONAL PARKING SPACES ARE ALSO INCLUDED ON SITE.

SHEET LIST

ARCHITECTURAL

A000 A001 A002 A005 A010 A011	COVER SHEET SITE CONTEXT EXISTING CONDITIONS PROJECT AXON ARCHITECTURAL SITE PLAN SITE SECTIONS
A100 A101 A102 A103	FIRST FLOOR PLAN SECOND FLOOR PLAN THIRD FLOOR PLAN FOURTH FLOOR PLAN
A201 A202 A203	EXTERIOR ELEVATIONS EXTERIOR ELEVATIONS EXTERIOR ELEVATIONS

BUILDING SECTION

A500 TYPICAL UNIT PLANS

CIVIL

- COVER SHEET
- 2 EXISTING CONDITIONS
- 3 DEMOLITION
- PROPOSED LAYOUT
- 5 PROPOSED GRADING
- 6 PROPOSED UTILITIES
 - CONSTRUCTION DETAILS
- 8 CONSTRUCTION DETAILS

EMBARC

60 K STREET, 3RD FLOOR
BOSTON, MA 02127
O: 617.766.8330
www.embarcstudio.com

OWNER
SITE FEASIBILITY

CONSULTANTS



DRAWING INFORMATION

ISSUE: PEL SUBMISSION

DATE: AUGUST 11, 2020


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DRAWING TITLE


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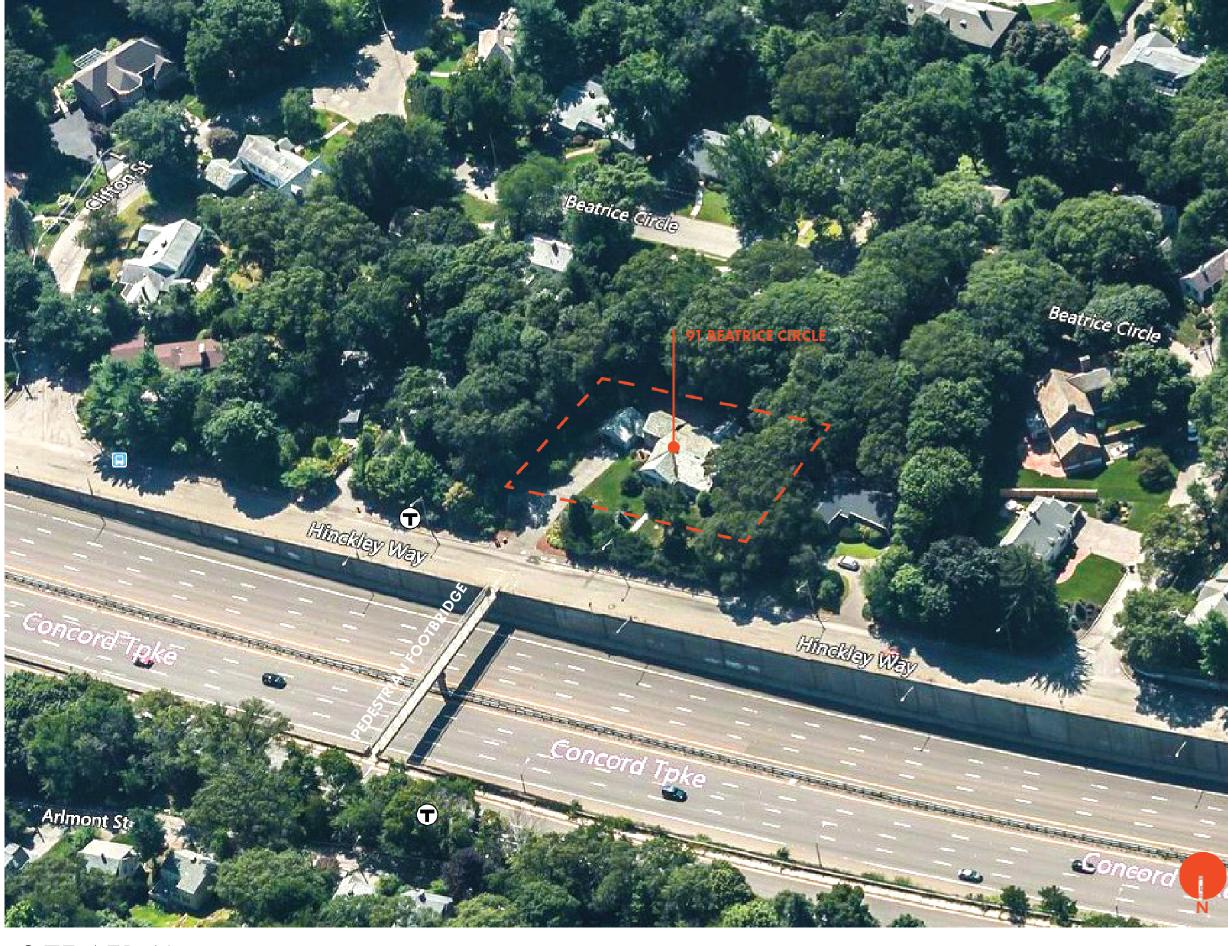
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TOWN CONTEXT



LOCAL CONTEXT

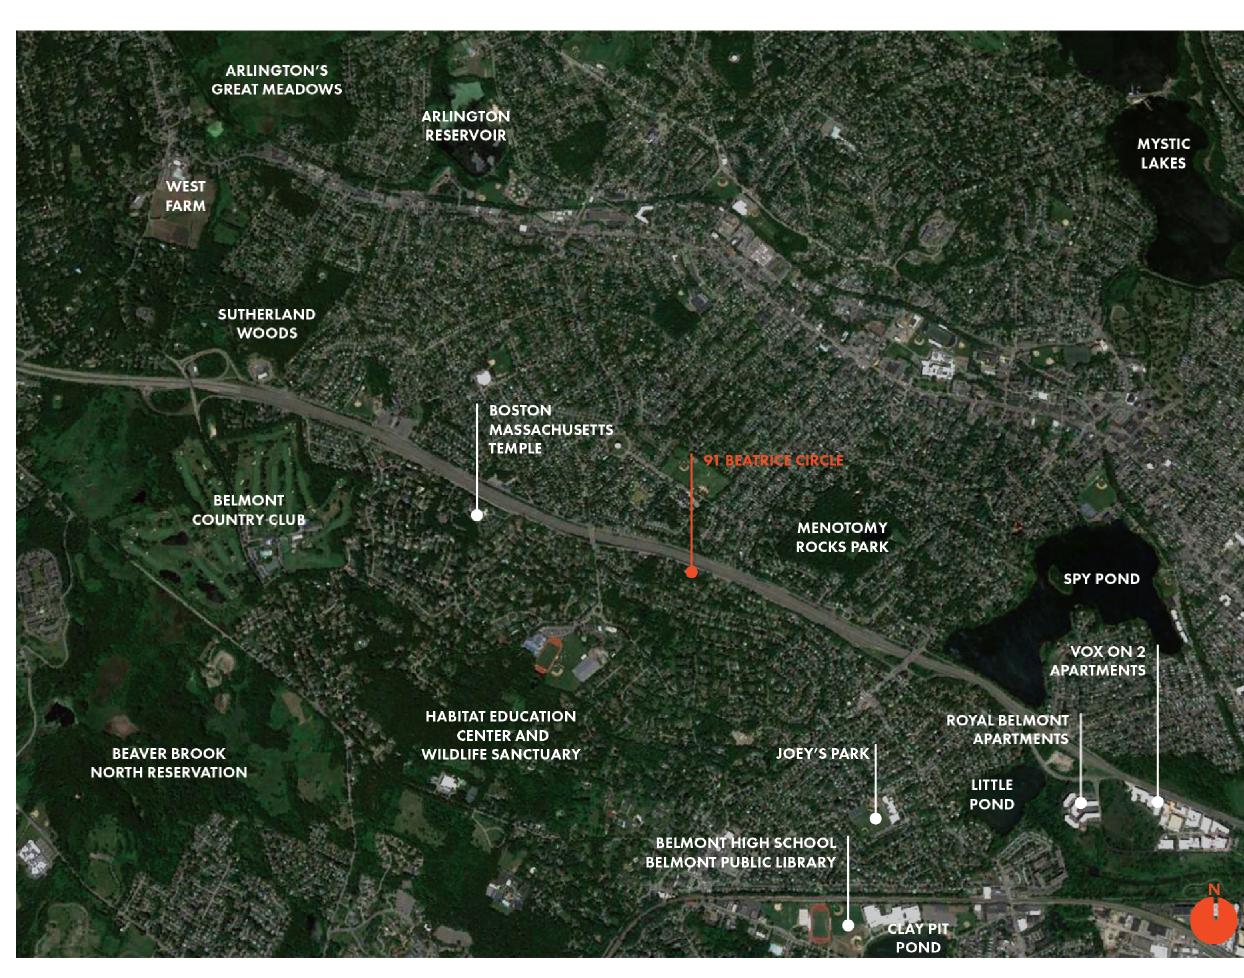

SITE AERIAL
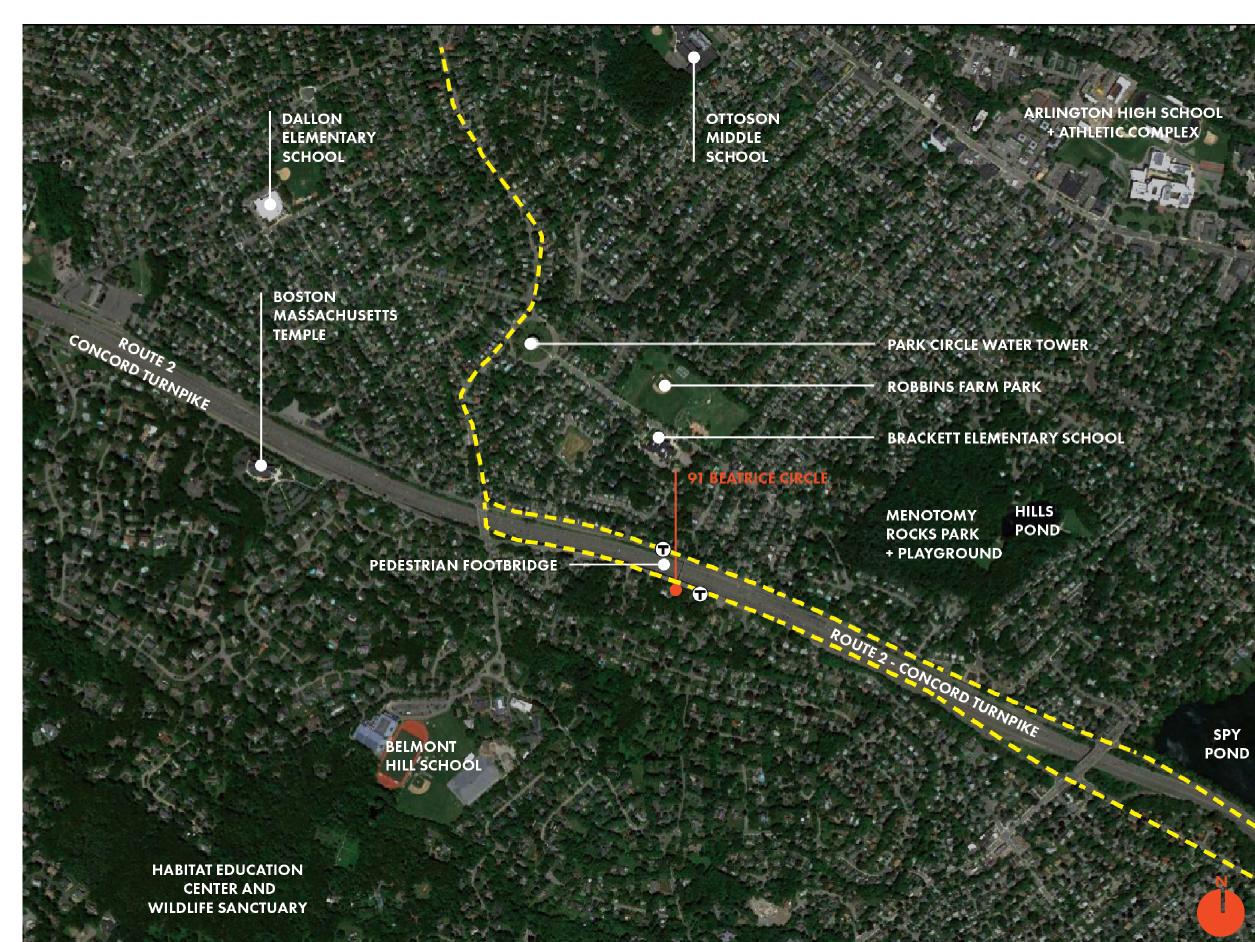
| ARCHITECT EMBARC 60 K STREET, 3RD FLOOR BOSTON, MA 02127 O: 617.766.8330 www.embarcstudio.com

OWNER

SITE FEASIBILITY

CONSULTANTS


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DRAWING INFORMATION

PROJECT #: 20004

DRAWING TITLE

SITE CONTEXT

DRAWING NUMBER
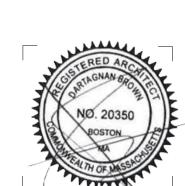
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REVISIONS

DATE: AUGUST 11, 2020
PROJECT #: 20004
SCALE:

DRAWING TITLE

EXISTING CONDITIONS

DRAWING NUMBER





VIEW OF EXISTING SITE - HINCKLEY ST. - FACING WEST

VIEW OF EXISTING SITE - HINCKLEY ST. - FACING SOUTH



VIEW OF EXISTING SITE - HINCKLEY ST. - FACING EAST



VIEW OF PEDESTRIAN CROSSING FROM SITE - FACING NORTH



VIEW OF STAIR ENTRY - FACING NORTH



VIEW OF EAST NEIGHBORING SITE - FACING EAST



VIEW OF SOUTH NEIGHBORING SITE - FACING EAST



VIEW OF WEST NEIGHBORING SITE - FACING WEST



VIEW TOWARDS ROUTE 2 - FACING NORTH



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OWNER

SITE FEASIBILITY

CONSULTANTS

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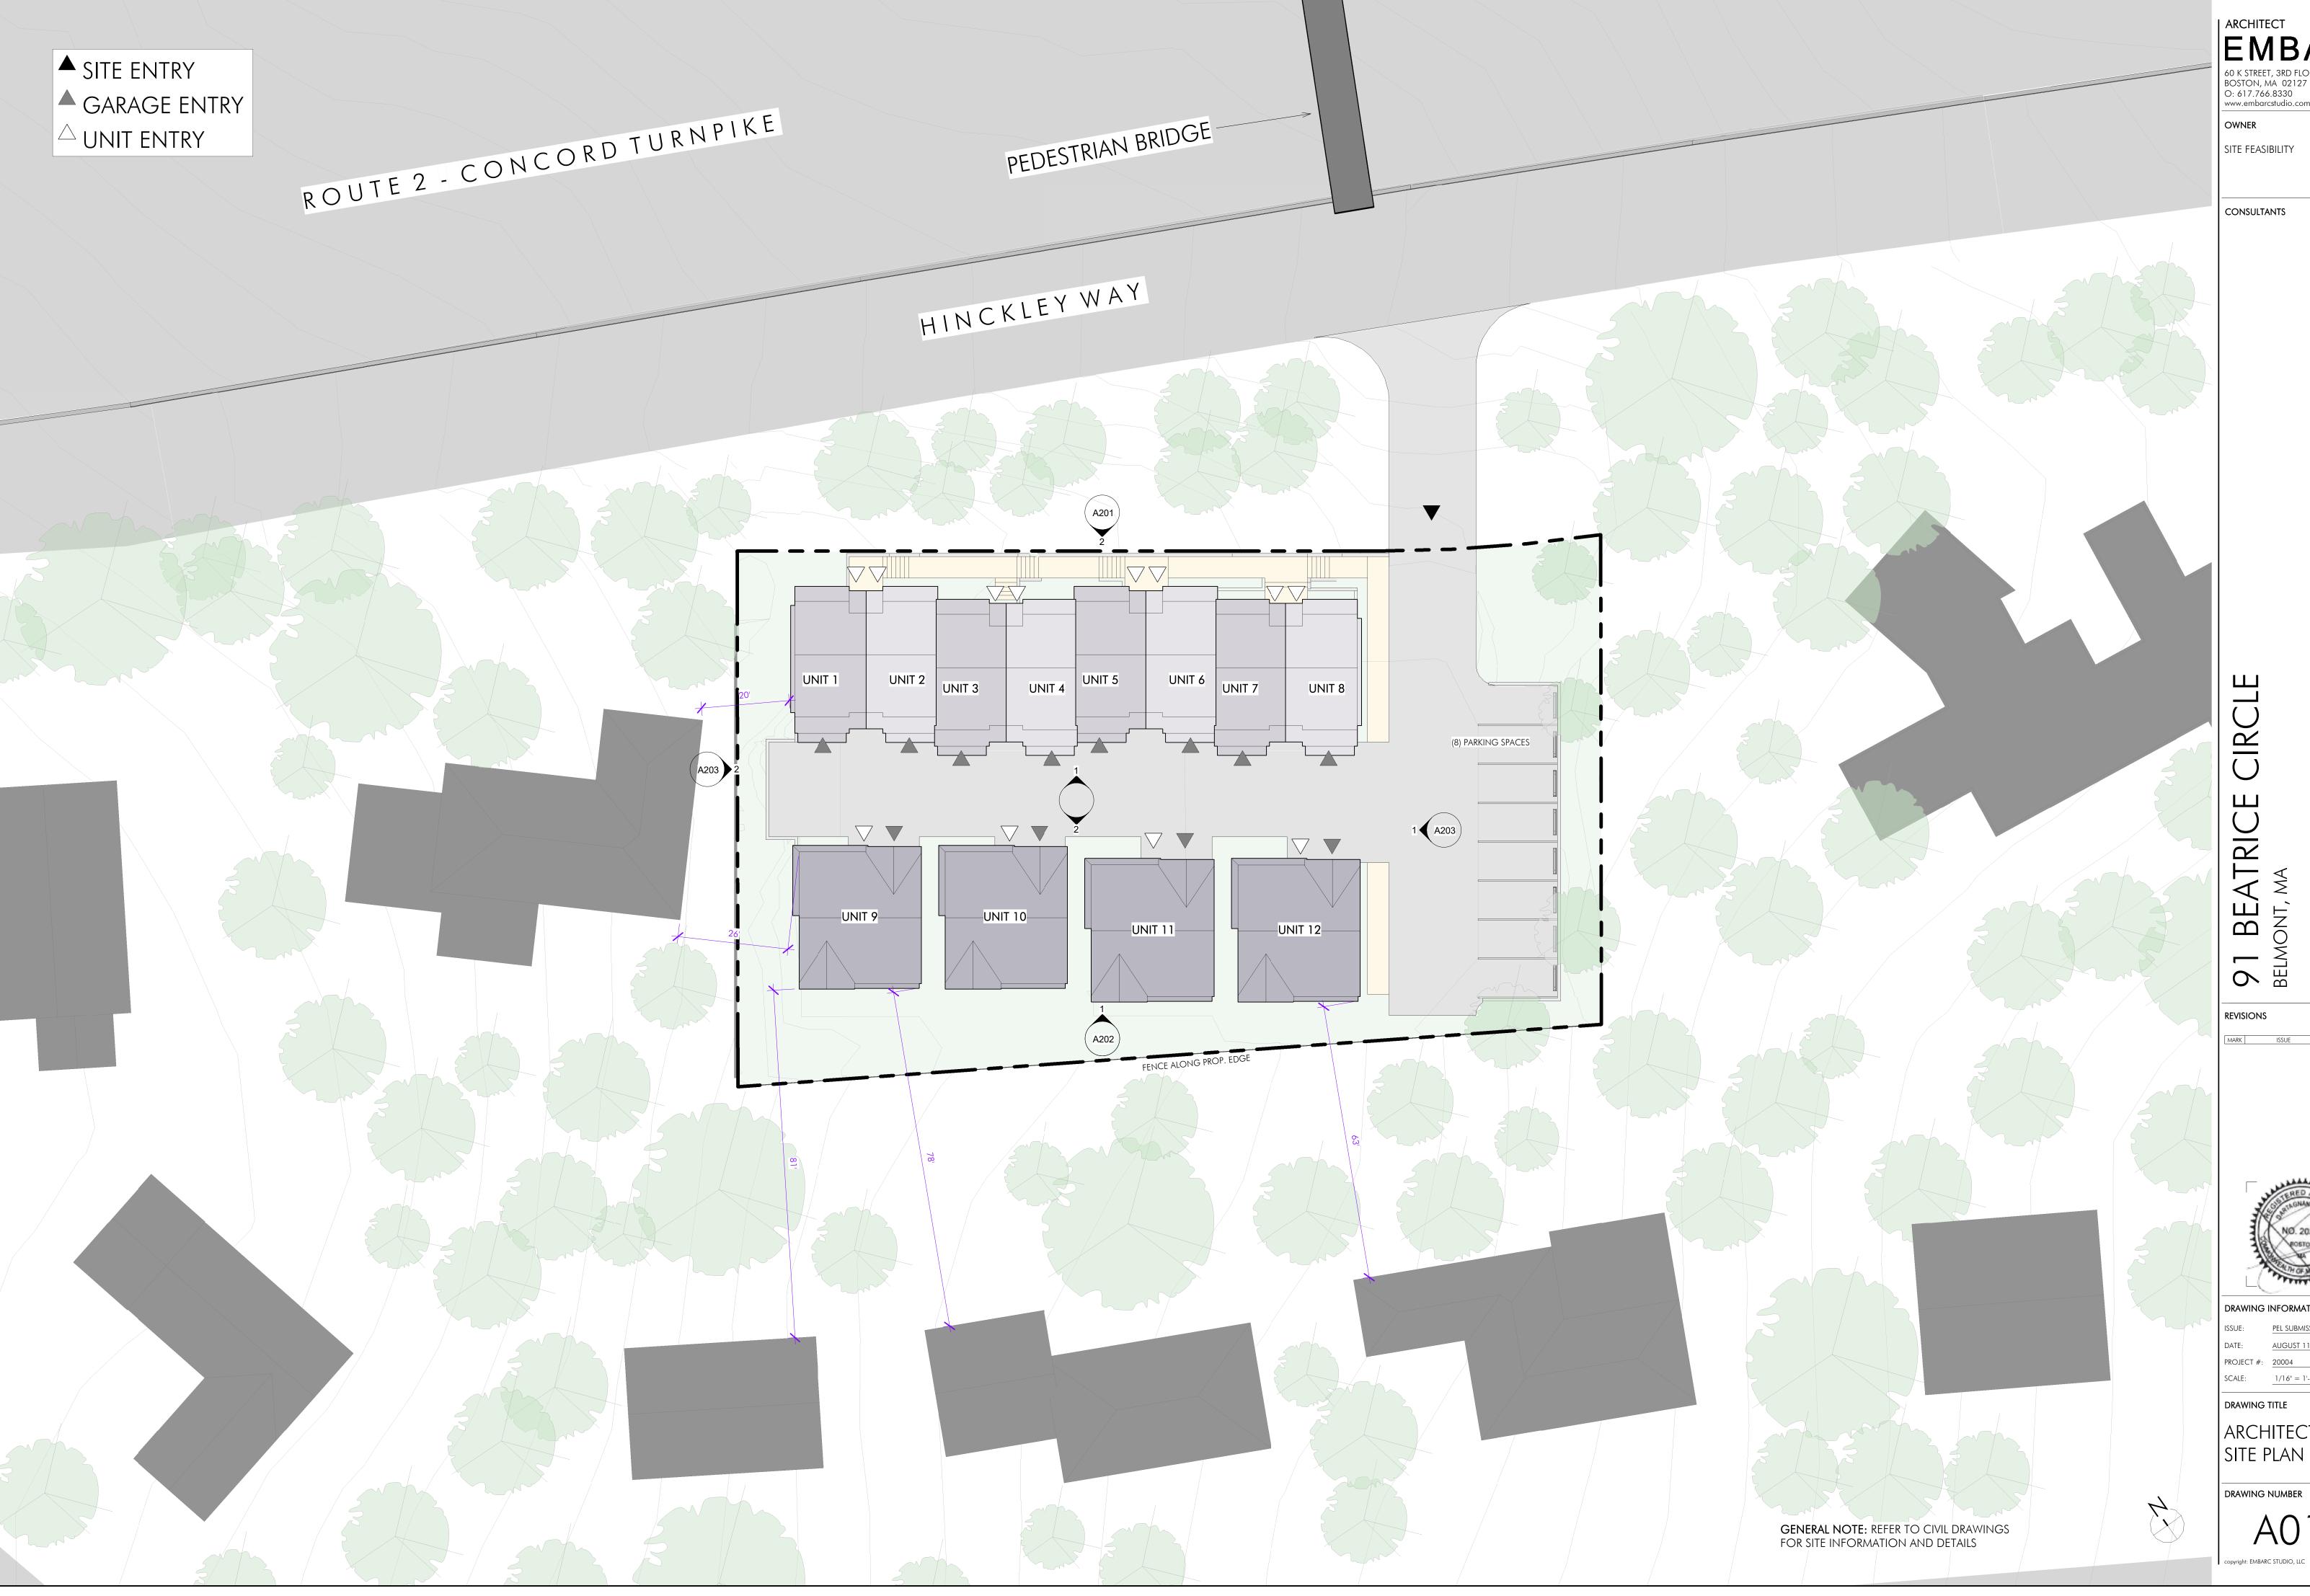
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SITE FEASIBILITY

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SITE FEASIBILITY

CONSULTANTS

91 BEAT

SUBMISSION


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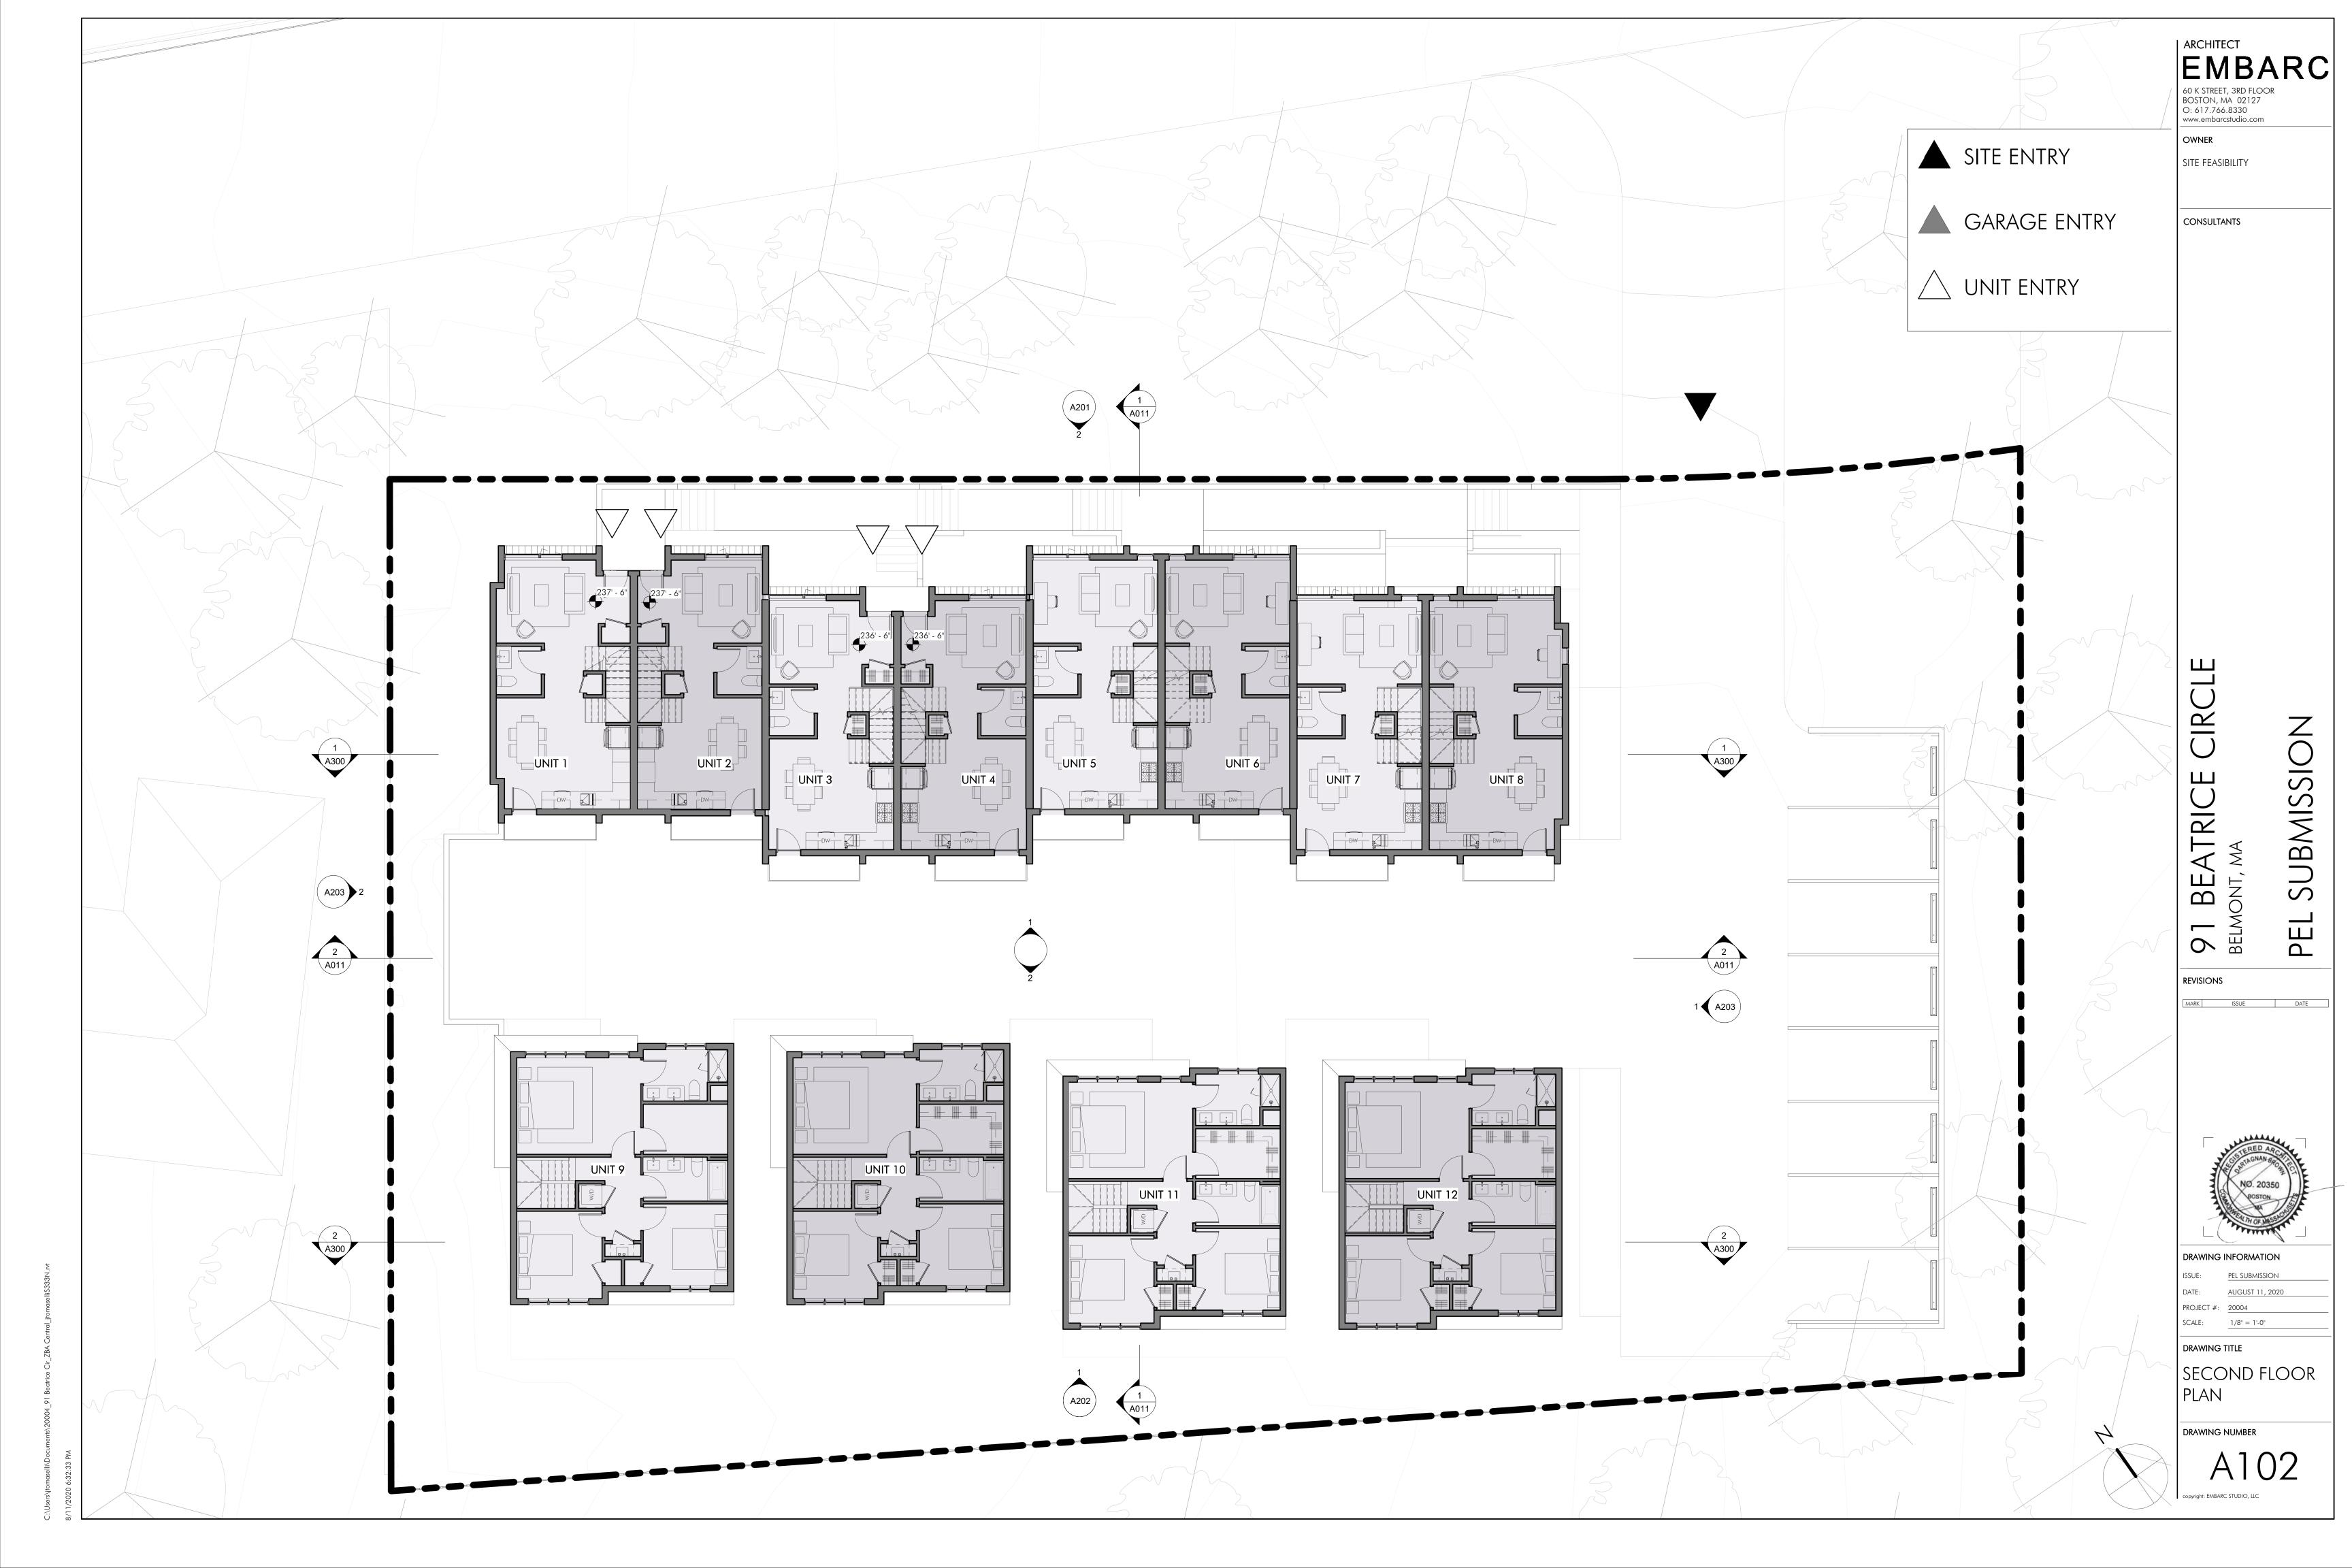



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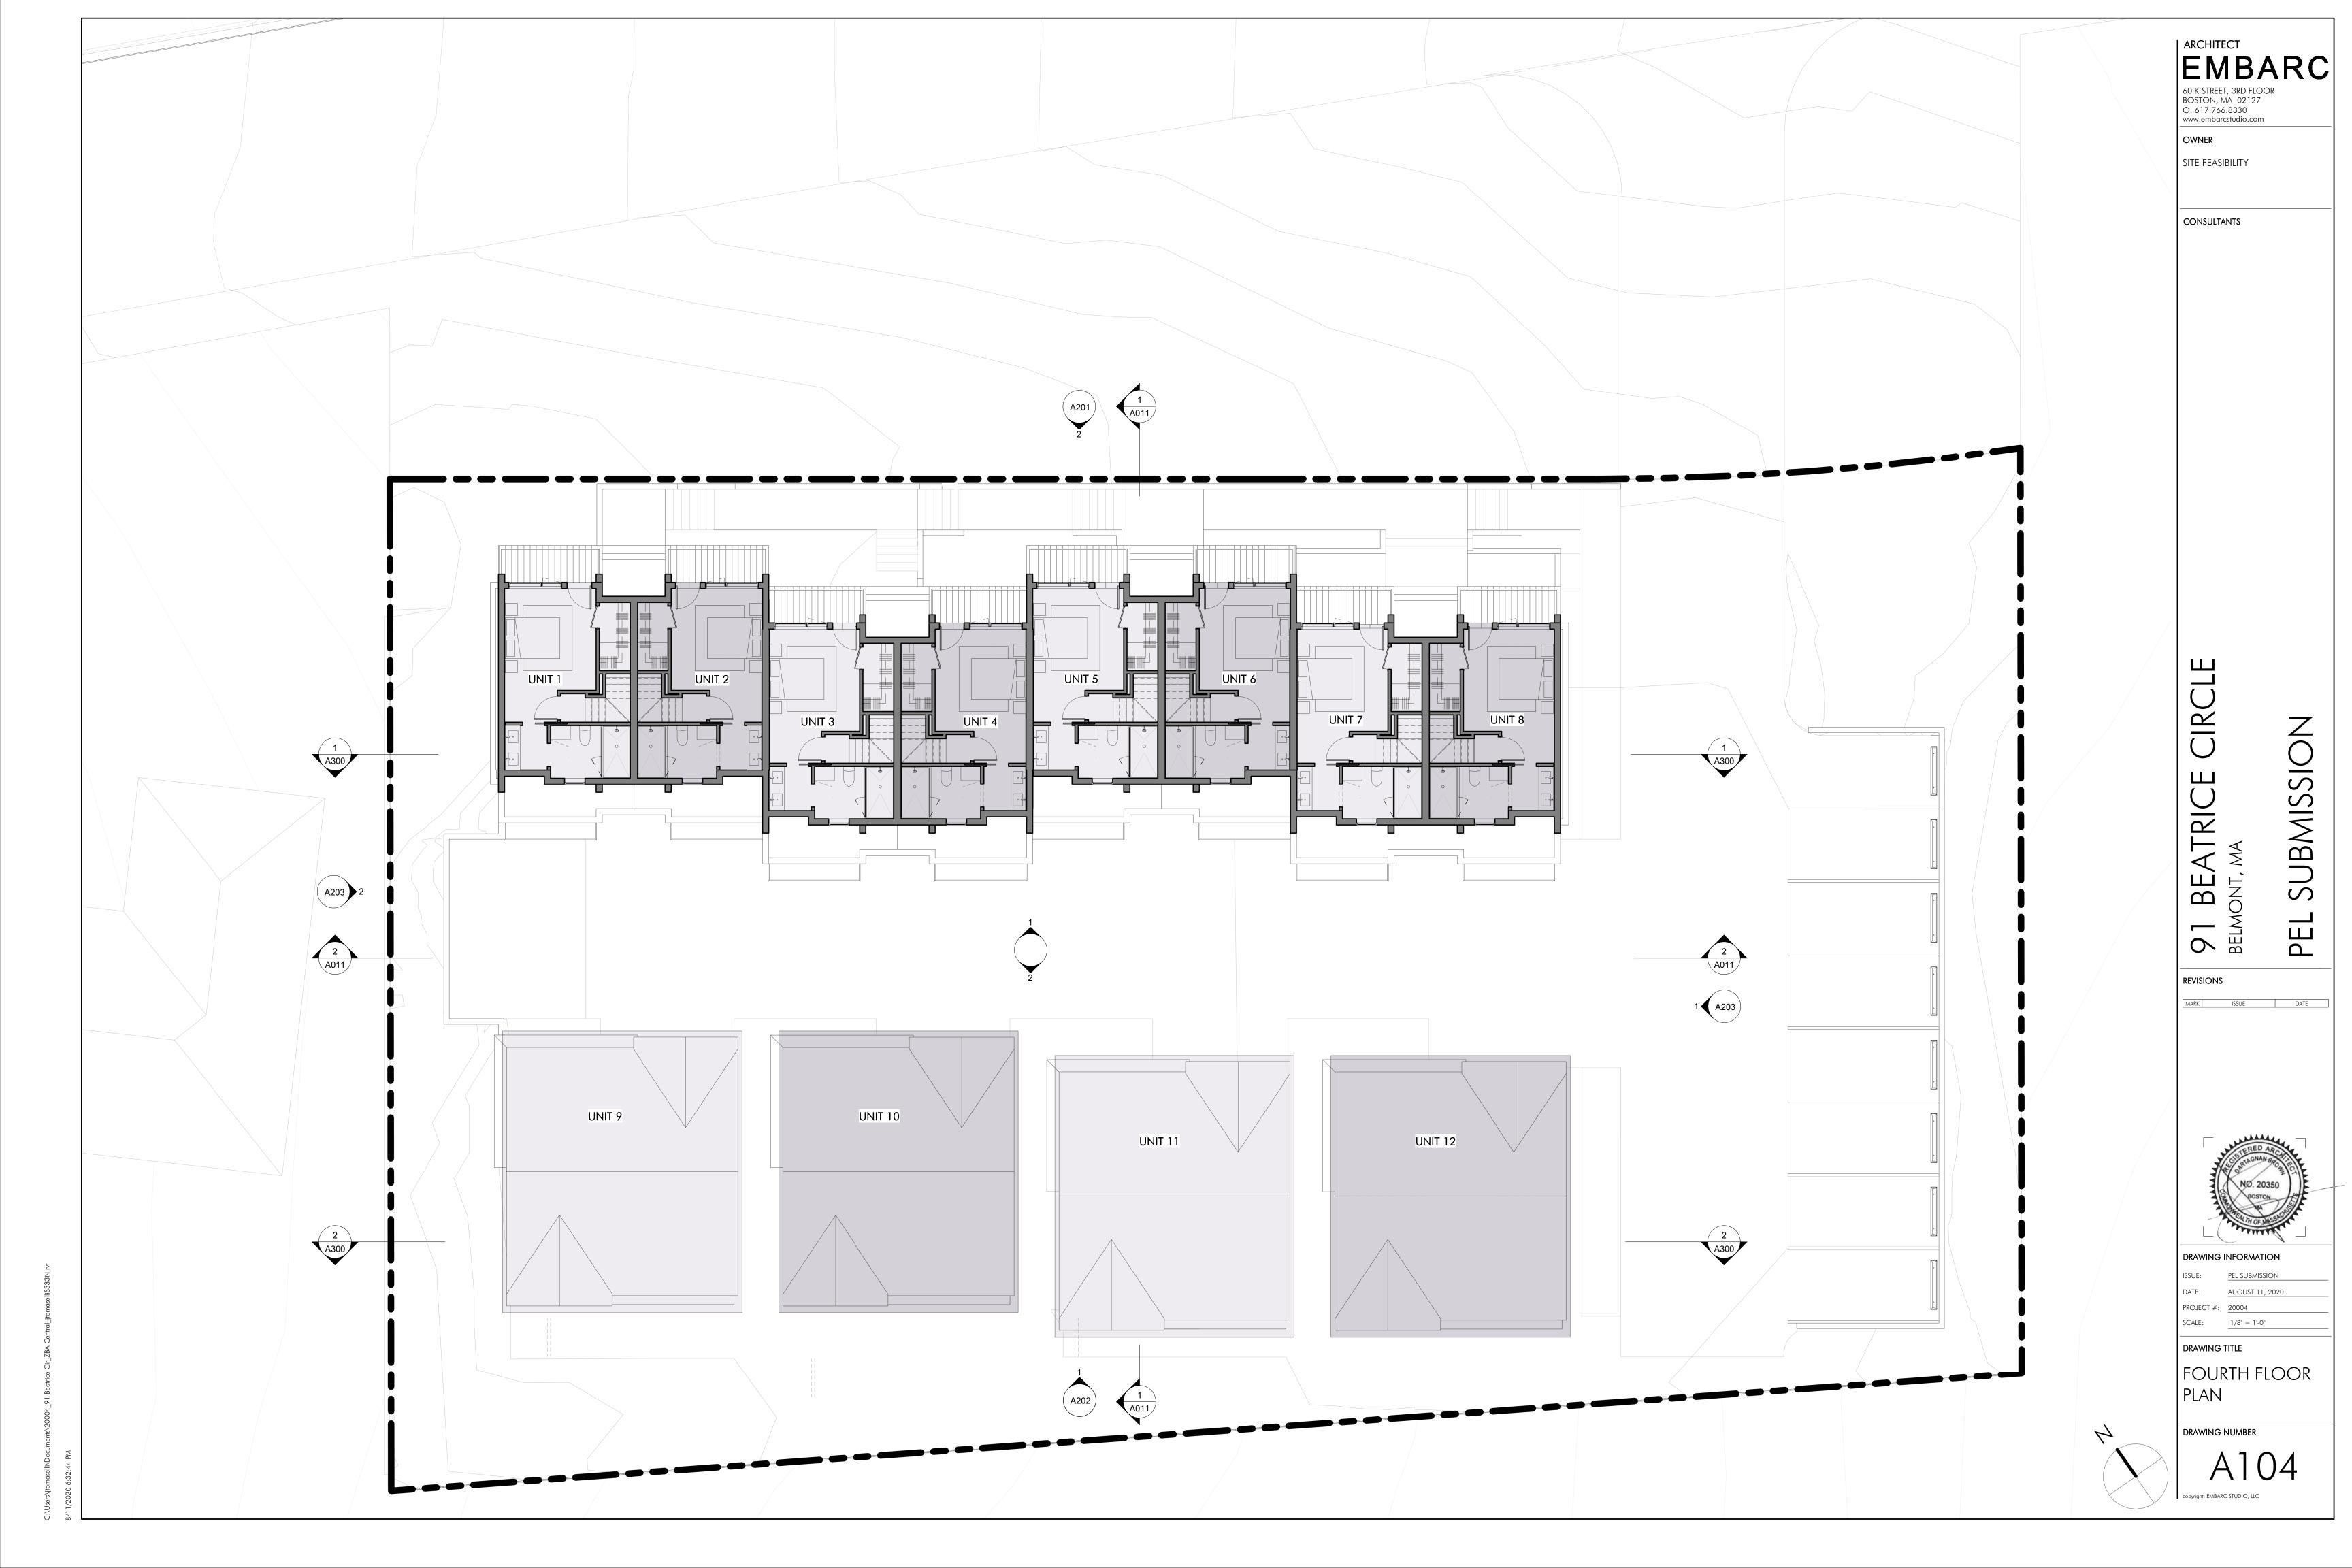
DRAWING TITLE

SITE SECTION





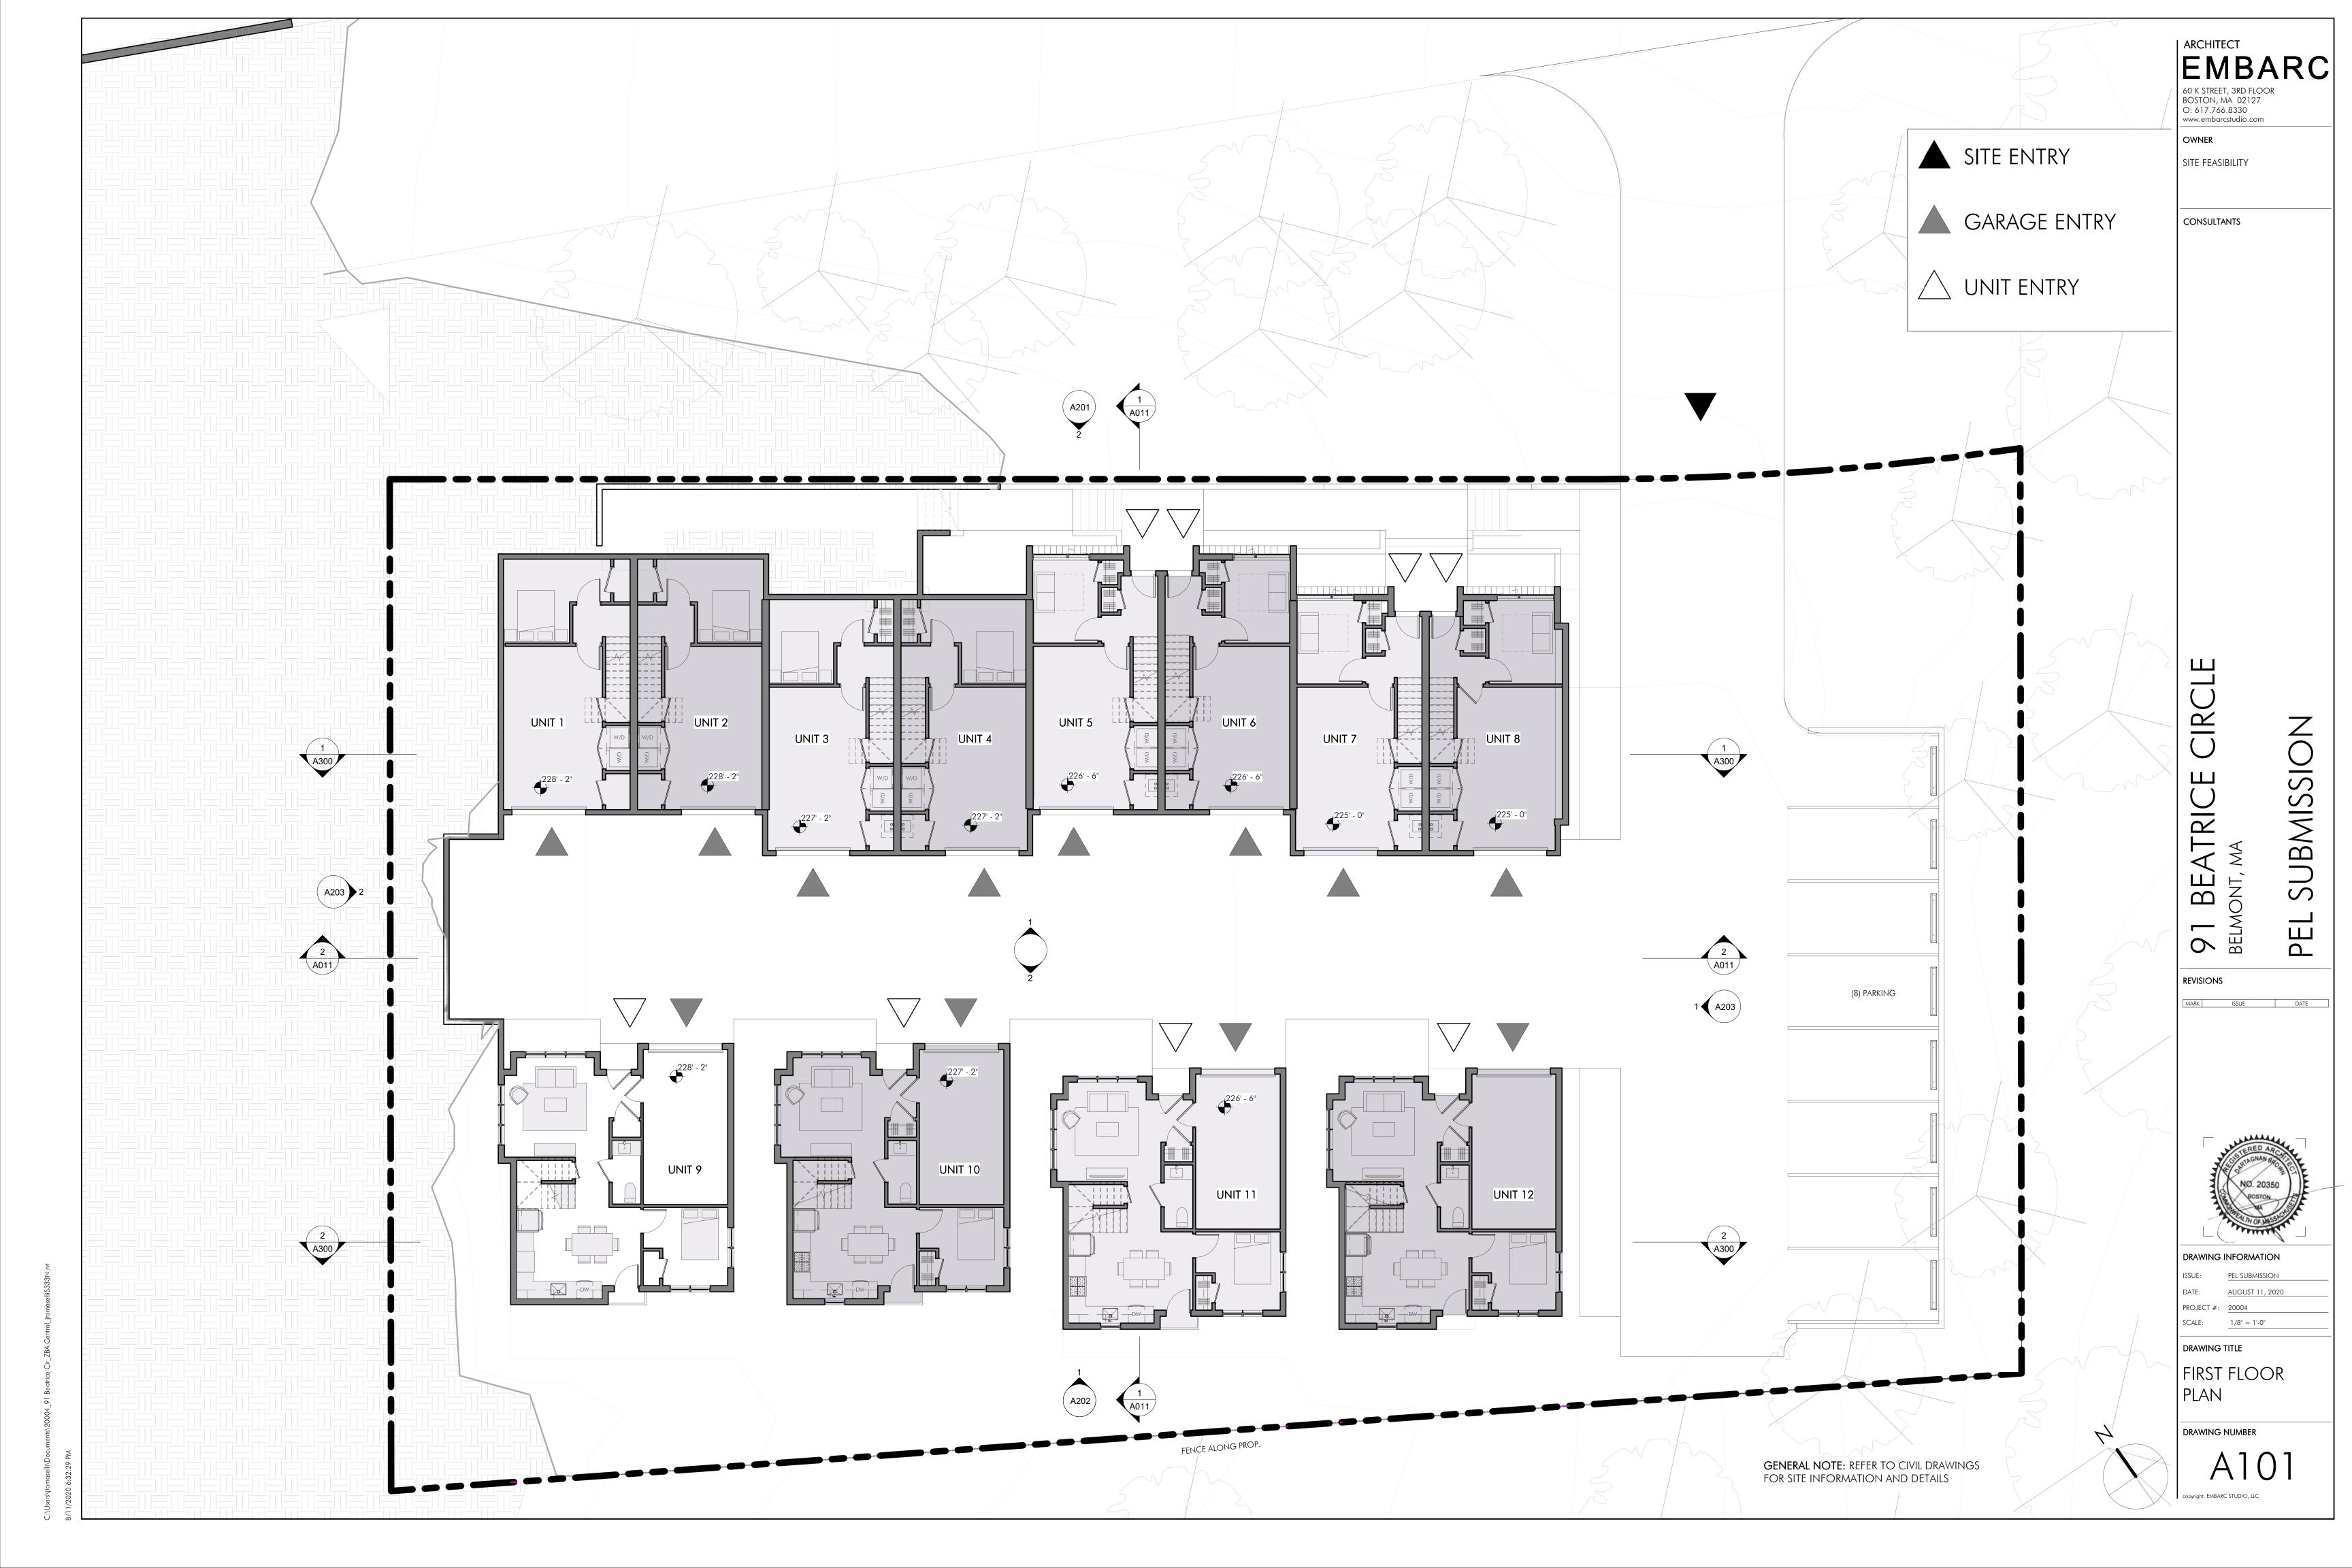

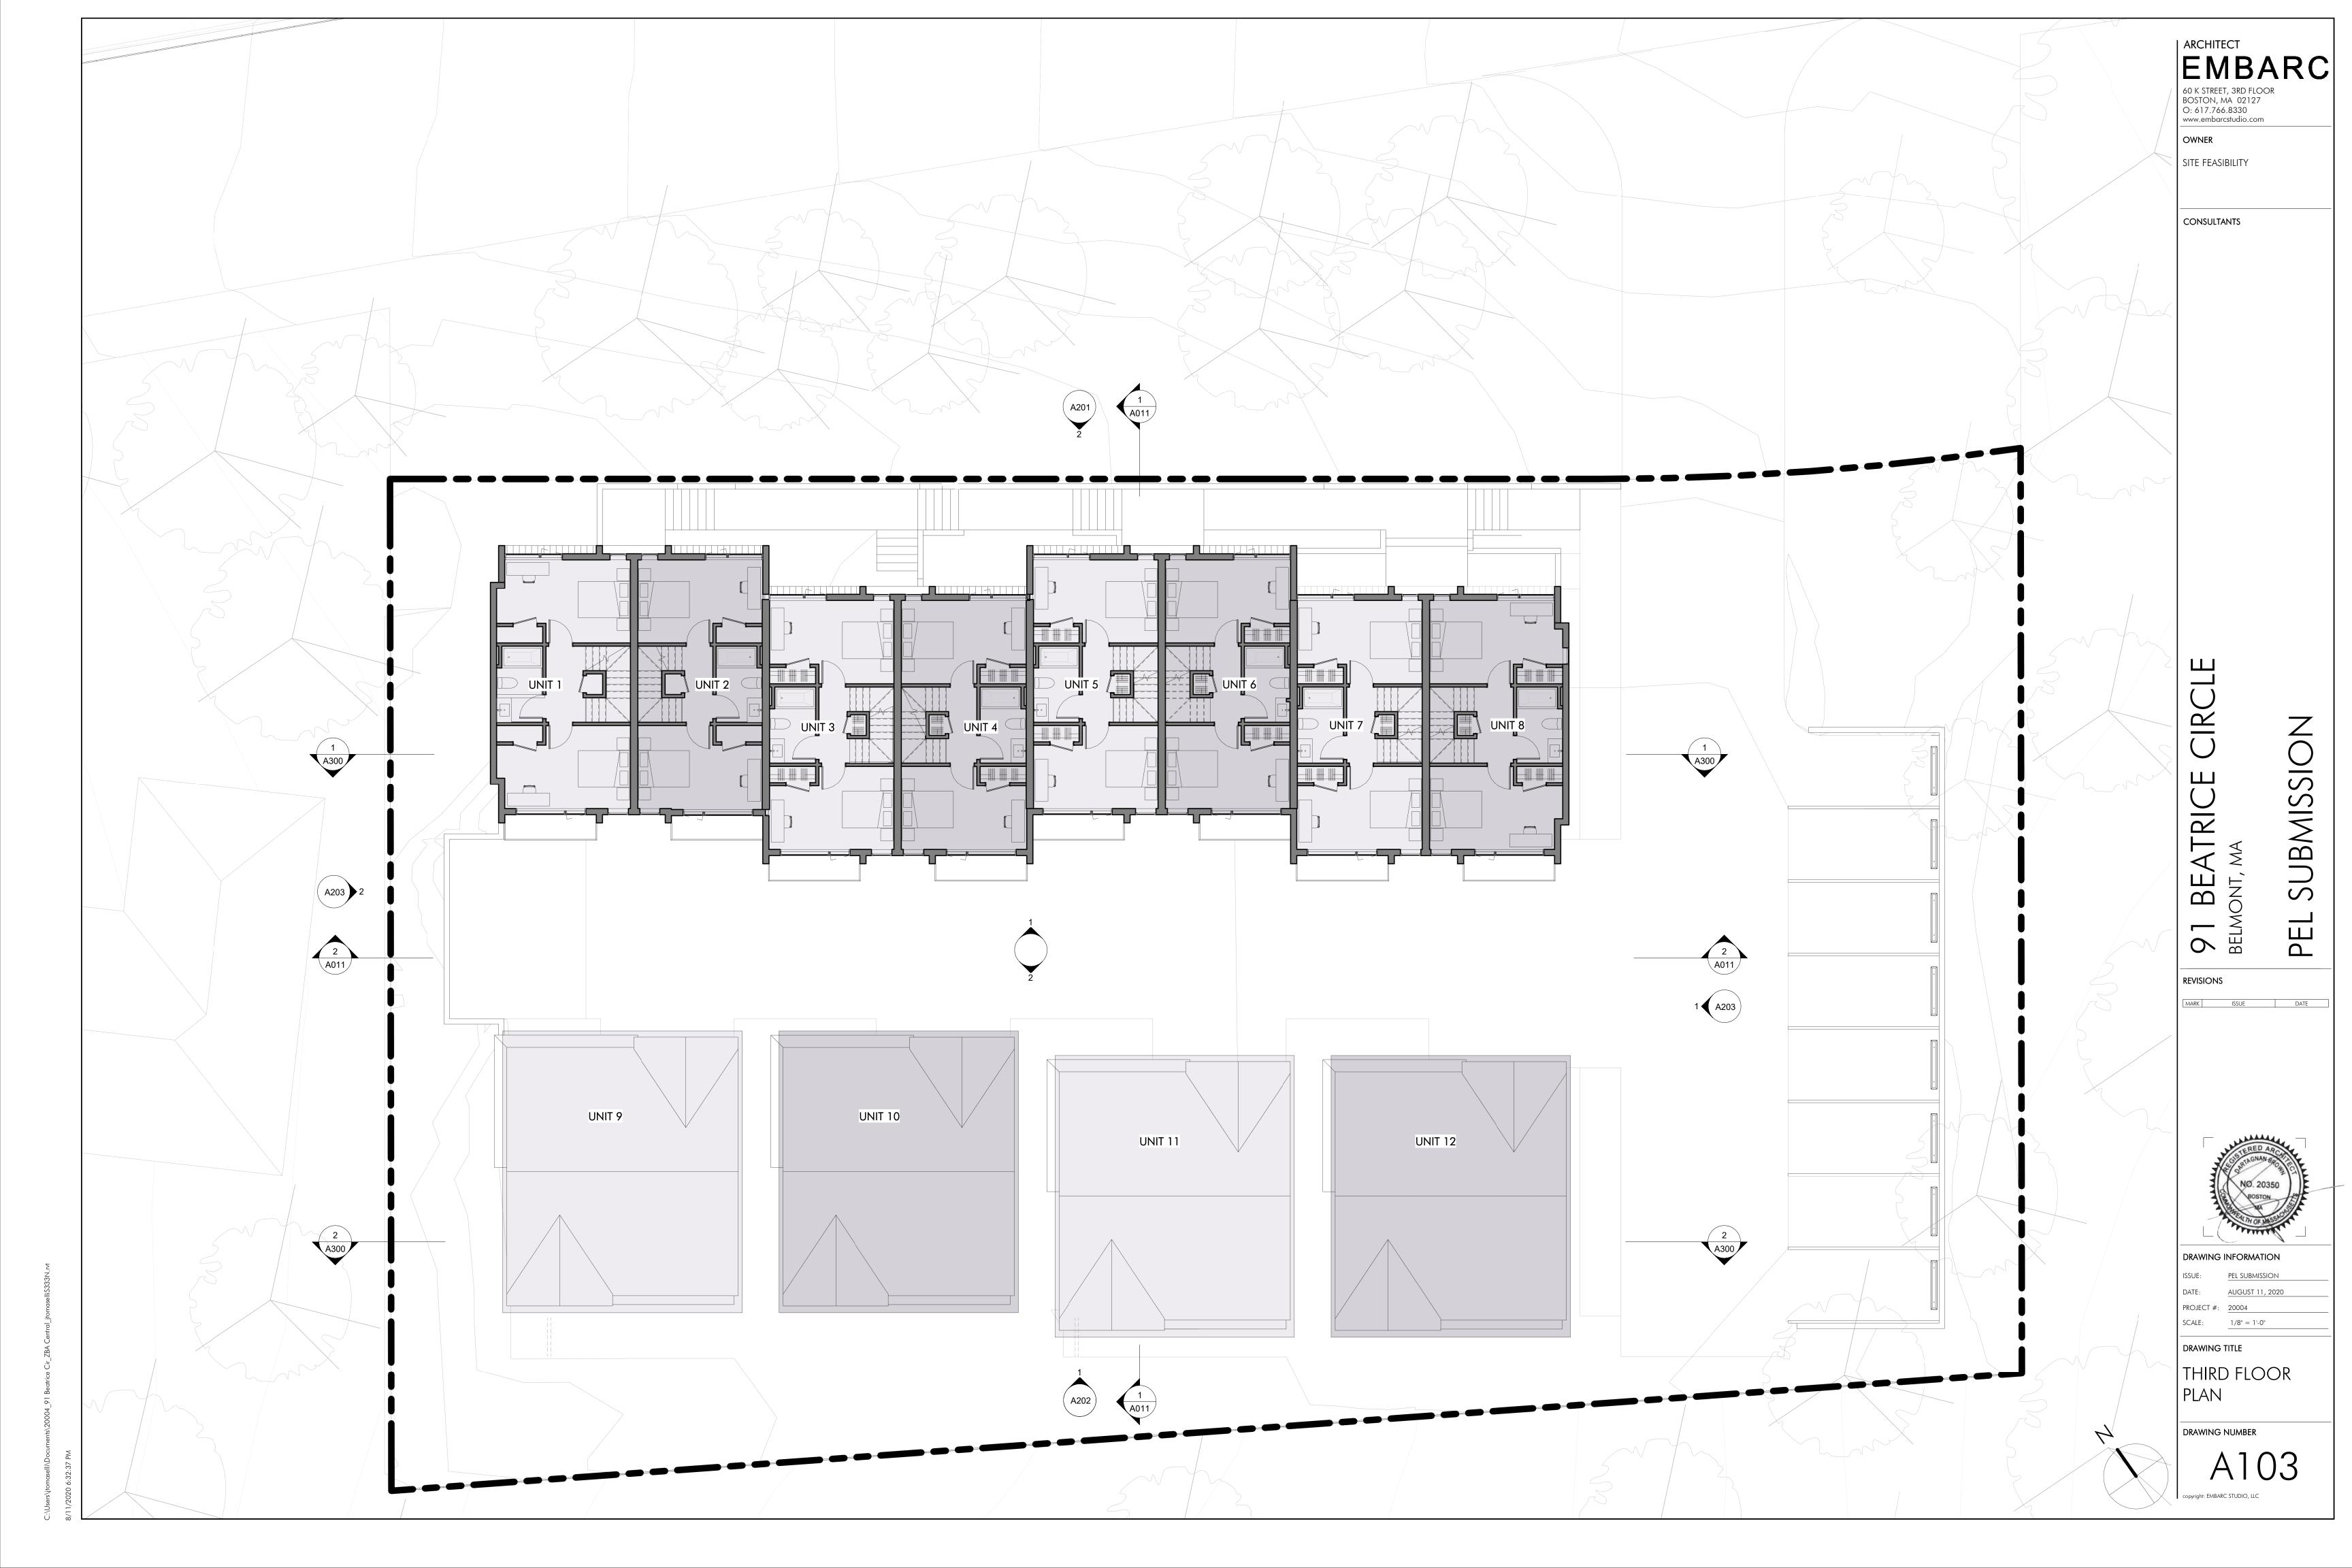

2 NORTH ELEVATION (TYPE A UNITS FRONT)

1/8" = 1'-0"



SOUTH ELEVATION (TYPE A UNITS REAR)

1/8" = 1'-0"

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> OWNER SITE FEASIBILITY


CONSULTANTS

CIRCLE BEATRI 91 BEAT BELMONT, MA

SUBMISSION

PEL

REVISIONS

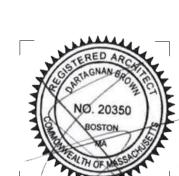

DRAWING INFORMATION

PROJECT #: 20004 SCALE: 1/8" = 1'-0"

DRAWING TITLE

EXTERIOR ELEVATIONS

DRAWING NUMBER

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PROJECT #: 20004

SCALE: 1/8" = 1'-0"

DRAWING TITLE

EXTERIOR

DRAWING NUMBER

ELEVATIONS

copyright: EMBARC STUDIO, LLC

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PA

2 NORTH ELEVATION (TYPE B UNITS FRONT)

1/8" = 1'-0"




SOUTH ELEVATION (TYPE B UNITS REAR)

1/8" = 1'-0"

1 EAST ELEVATION

1/8" = 1'-0"

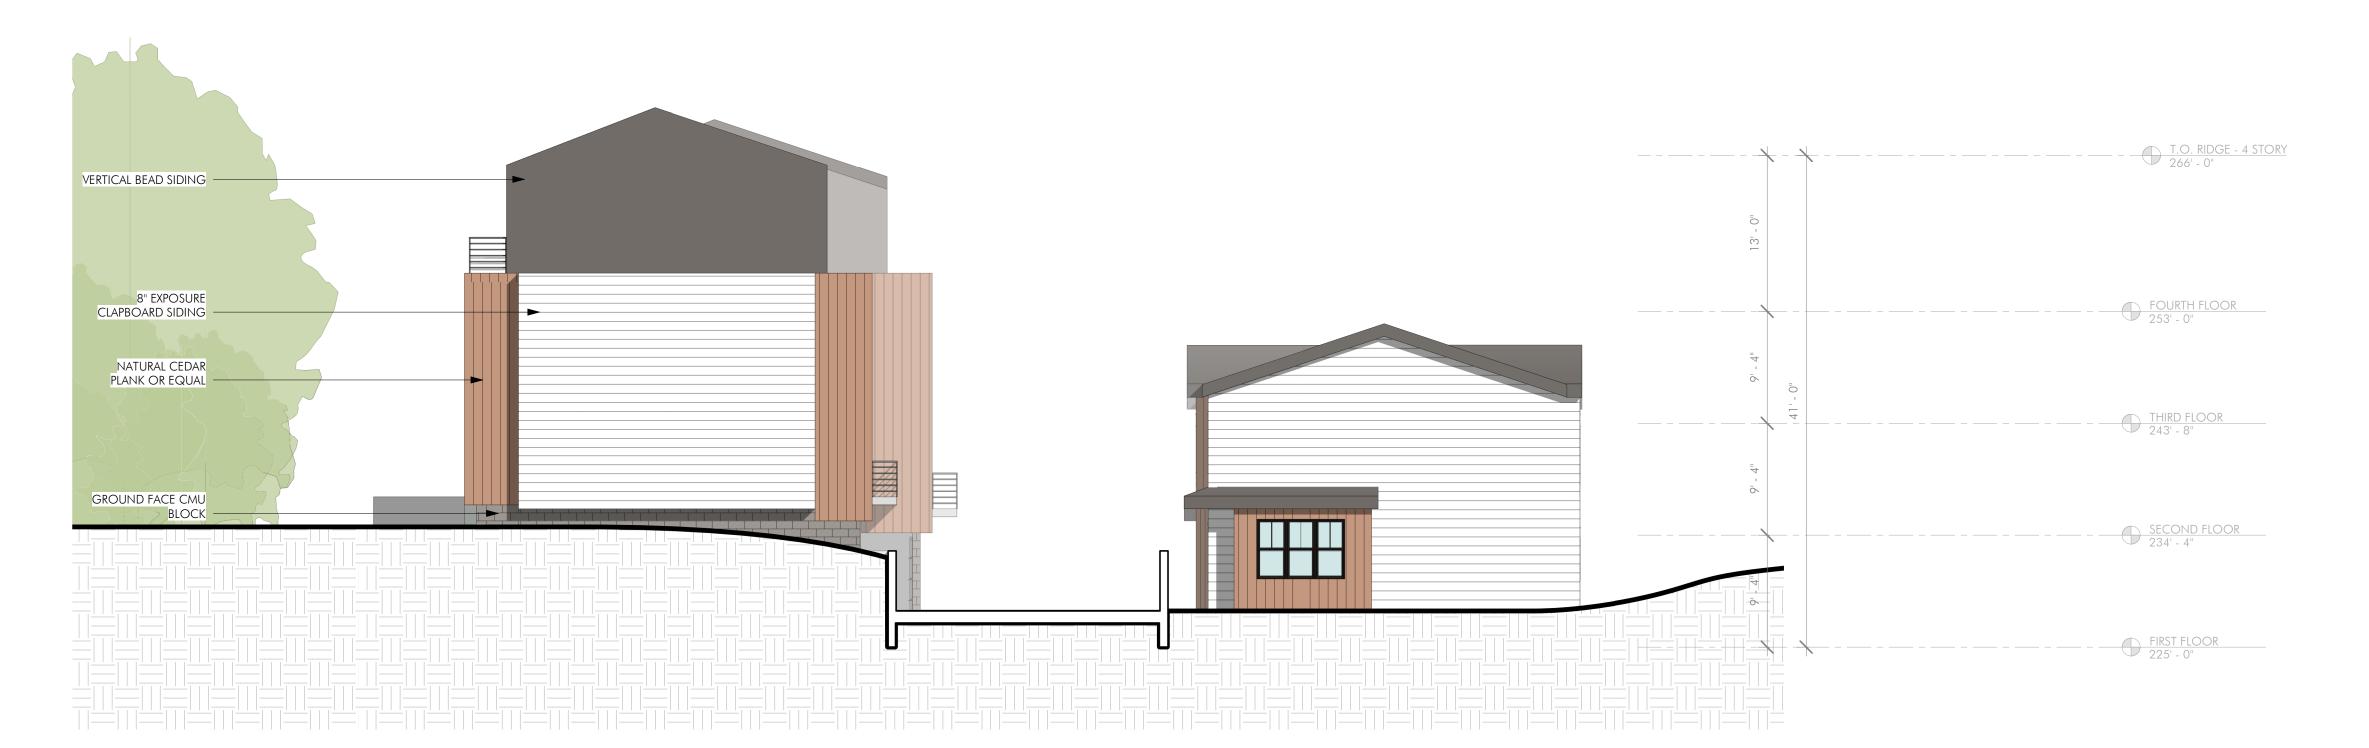



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> OWNER SITE FEASIBILITY

CONSULTANTS

CIRCLE BEATRI BELMONT, MA

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DRAWING INFORMATION ISSUE: PEL SUBMISSION

SCALE: 1/8" = 1'-0" DRAWING TITLE

PROJECT #: 20004

EXTERIOR ELEVATIONS

DRAWING NUMBER

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EMBARC

August 11, 2020

Comprehensive Land Holdings 91 Beatrice Circle Belmont, MA 02186

Architectural Project Narrative

91 Beatrice Circle is a property located along Frontage Road/ Hinckley Way, a Route 2 Concord Turnpike frontage road, in the Belmont Hill neighborhood. This road provides quick vehicular transportation to Boston, and the site is located directly adjacent to five area MBTA bus lines. The immediate abutting land uses are single-family homes that front Hinckley Way, Clifton St, and Beatrice Circle, as well as a wooded buffer strip between the project site and the frontage road.

The proposed design has been modified to improve the transition from the single family neighborhoods to the south of the site, improve circulation and open space, and reduce the project's massing and visual impact on abutting properties. Driving these changes is the conversion of the south row of 3-story townhouses in the original proposal to a collection of four, 2-story single-family detached homes in the revised proposal.

The project's height, massing, and architectural design create a harmonious transition between the Route 2 Corridor to the north and the single-family neighborhoods of Belmont Hill to the south. The collection of single-family detached homes in the revised proposal incorporate traditional architectural elements including pitched roofs, gables, and natural clapboard materials. These elements speak to some of the more traditional aspects of Belmont's existing housing stock. At the same time, the color pallet and design motifs of the rear single family units help introduce and harmonize with the four story townhouses that abut Route 2 and reflect the more dense development of this corridor.


The revisions to the project also serve to pull the rear units further away from abutting properties. Residents of the single family units will enter their homes through the project's central corridor, eliminating the need for walkways along the rear of the site and allowing for more space, vegetation, and screening between the properties along Beatrice Circle. This will help support an expansive and carefully curated landscape plan. Combined with the reduced massing associated with these separate, two-story units, this change helps minimize the project's impact.

The site redesign has also reduced the grade of the entry drive and pulled our surface parking further from the road, allowing for additional visual screening from the frontage road. Traffic and site analyses also indicate that emergency vehicles will be able to effectively access the project.

PROPOSED SITE PLAN

91 BEATRICE CIRCLE BELMONT, MASSACHUSETTS

AUGUST 12, 2020

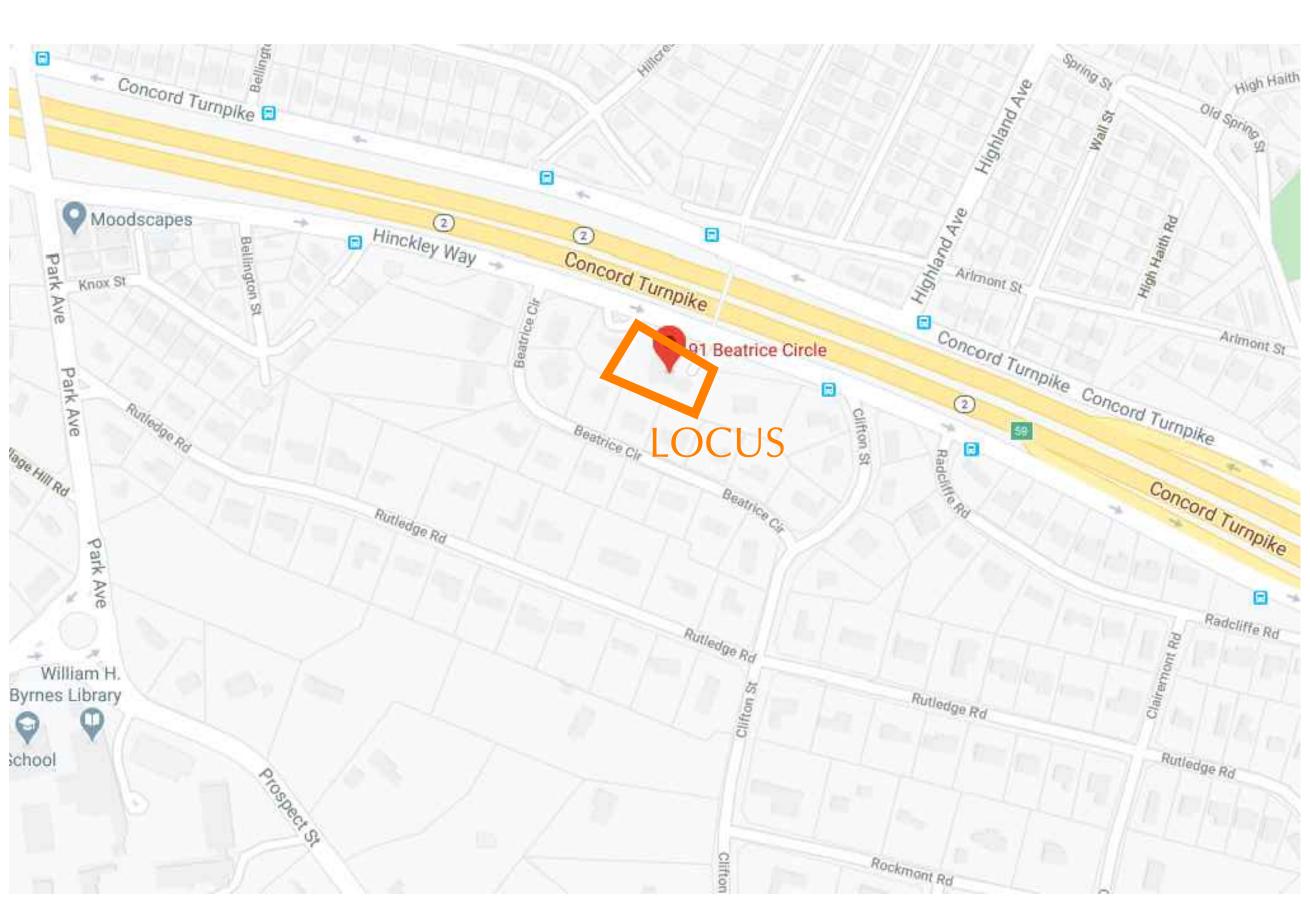

LOCUS AERIAL

IMAGE FROM 2020 GOOGLE MAP DATA

SHEETS

- 1 COVER SHEET
- 2 EXISTING CONDITIONS
- 3 DEMOLITION
- 4 PROPOSED LAYOUT
- 5 PROPOSED GRADING
- 6 PROPOSED UTILITIES
- 7 CONSTRUCTION DETAILS
- 8 CONSTRUCTION DETAILS

APPLICANT

91 BEATRICE CIRCLE LLC c/o REGNANTE STERIO 401 EDGEWATER PL, SUITE 630 WAKEFIELD, MA 01880

LEGAL

REGNANTE STERIO, LLP 401 EDGEWATER PLACE SUITE 630 WAKEFIELD, MA 01880

ARCHITECT

EMBARC STUDIO 60 K STREET BOSTON, MA 02127

TRAFFIC

MDM TRANSPORTATION CONSULTANTS, INC. 20 LORD ROAD SUITE 280 MARLBOROUGH, MA 01752


CIVIL/SURVEY


QUINCY, MA 02169

DECELLE-BURKE-SALA & ASSOCIATES, INC. 1266 FURNACE BROOK PARKWAY DeCelle-Burke-Sala SUITE 401

& Associates, Inc. 66 Furnace Brook Parkway #40



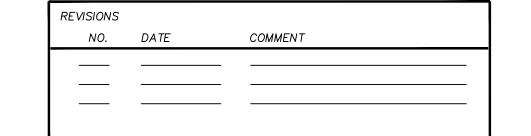

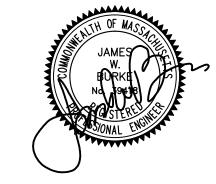

SOIL TEST PIT DATA:


APP	
ROX. MR	
APPROX. MASS GRID	

	TEST PIT1 GRD. EL225.0	. T . G
0"-	GW. EL. NGWO FILL, SANDY LOAM, 10YR3/2 Granular, Very Friable	0"-0
0"—	FILL, SANDY LOAM, 10YR3/4 Massive, Friable	11 —
18"—	Apb, SANDY LOAM, 10YR3/2 Granular, Very Friable	41"—
54"–	Bw, SANDY LOAM, 10YR4/6 Massive, Friable	50"

30IL 1E3	
TEST PIT2 GRD. EL224.7 GW. ELNGWO FILL, SANDY LOAM,	0"-
10YR3/2 Granular, Very Friable FILL, SANDY LOAM, 10YR3/4 Massive, Friable	12"-
Apb, SANDY LOAM, 10YR3/2 Granular, Very Friable	37"-
Bw, SANDY LOAM, 7.5YR4/4 Massive, Friable	77 " -


00.1		• •				
TEST PIT GRD. EL. O" GW. EL. FILL, SANI 10YR3/2 Granular, Friable 11 — FILL, SANI 10YR3/4 Massive, F 41"— Apb, SANI 10YR3/2 Granular, Friable 50"— Bw, SAND 7.5YR4/4 Massive, F	Very DY LOAM, Friable DY LOAM, Very Y LOAM,	(TEST PIT 3 GRD. EL. 229.8 GW. EL. NGWO Ap, SANDY LOAM, 10YR3/3 Granular, Very Friable Bw, SANDY LOAM, 10YR4/6 Massive, Friable C1, FINE LOAMY SAND, 5Y5/2 Massive, Friable Some gravel C2d, FINE LOAMY SAND, 5Y5/2, Massive, Firm Very gravelly	TEST KAME	5/2019	<u>#14227</u>
60" R, Ledge		99"⊥				

CONCORD TURNPIKE

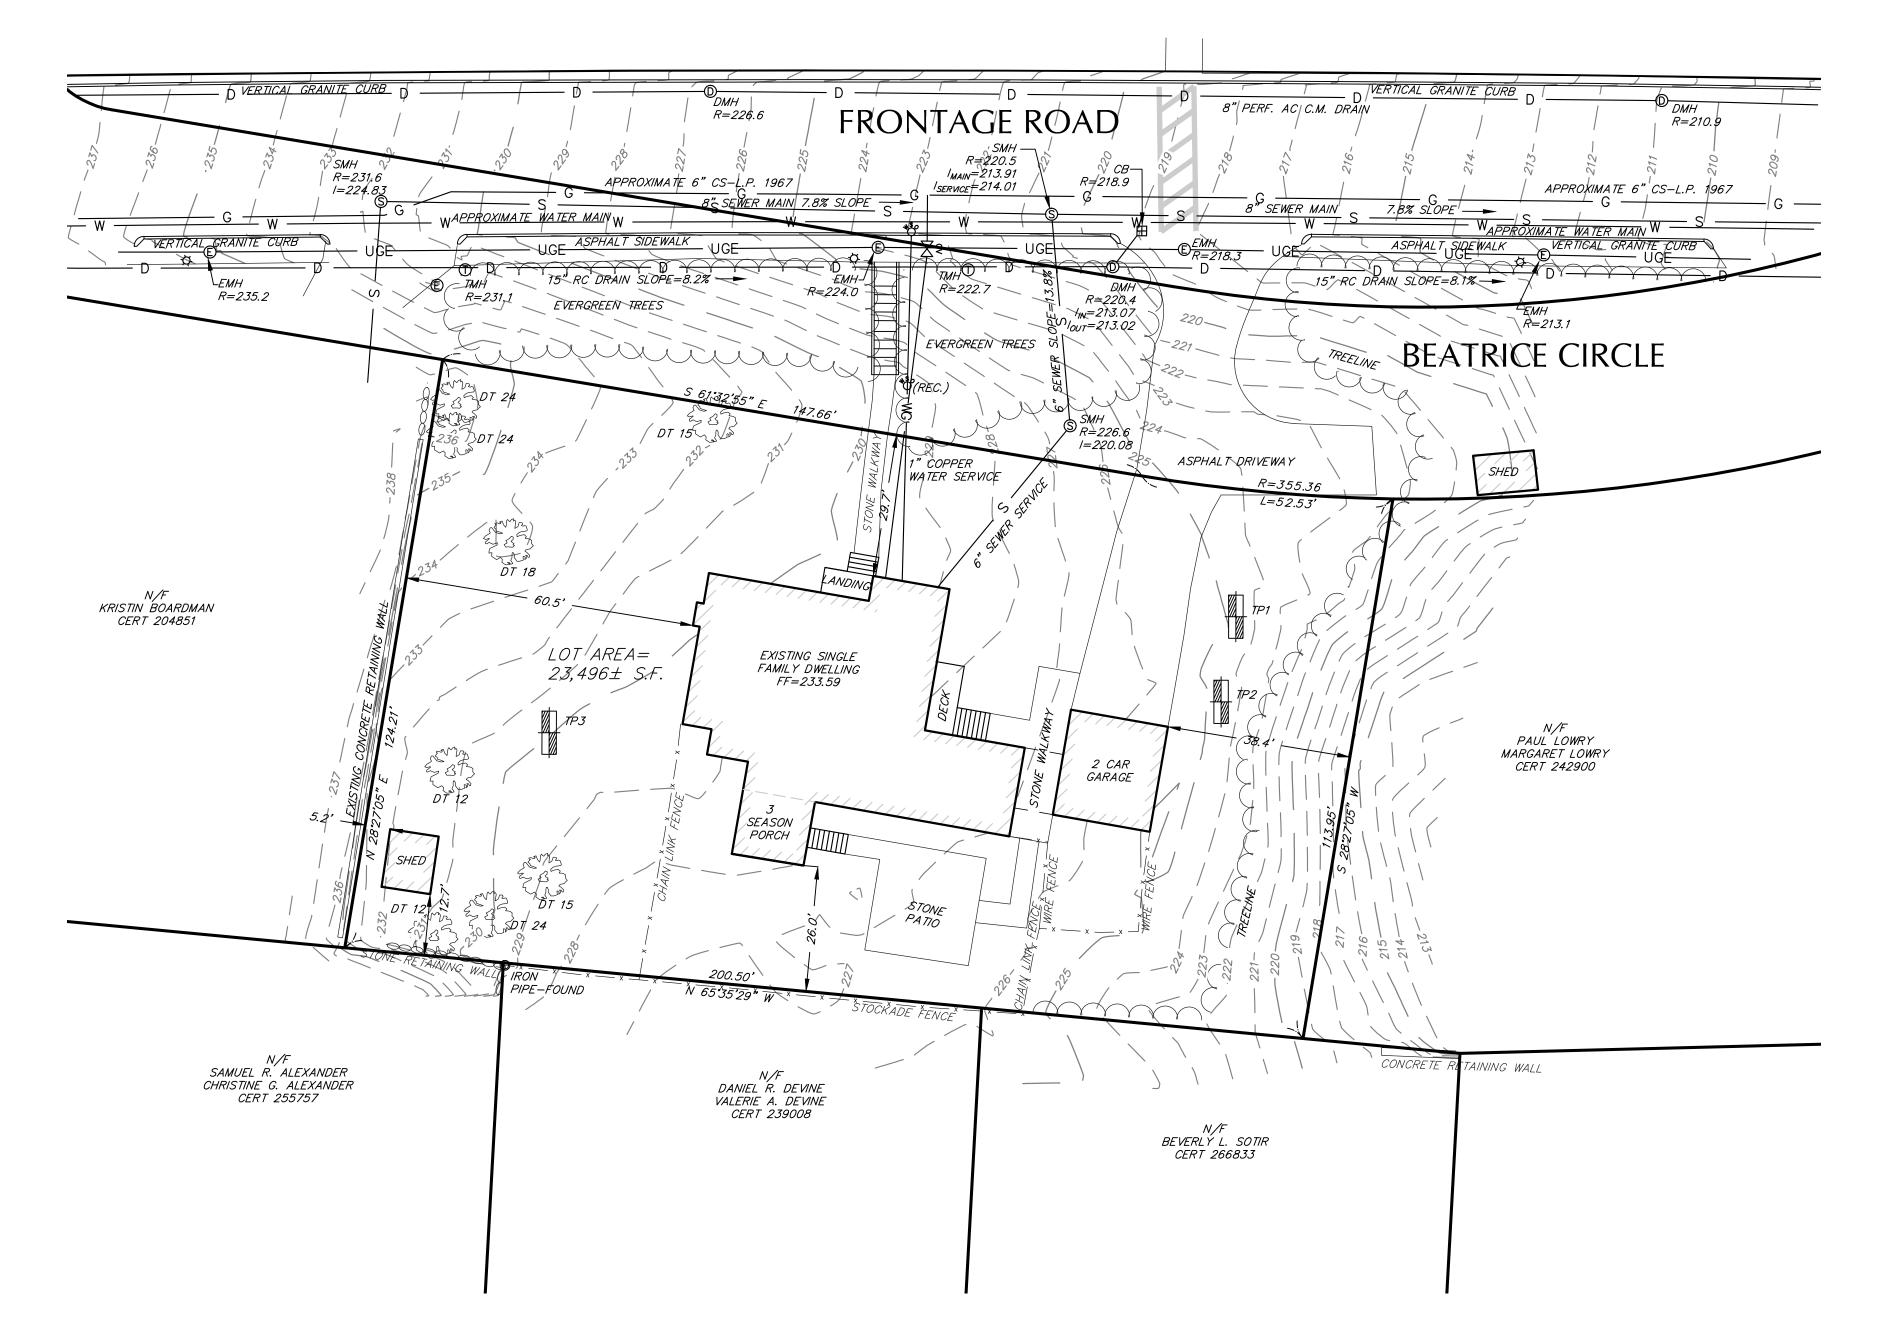



Quincy, MA 02169 617-405-5100(o) 617-405-5101(f) www.decelle-burke-sala.com

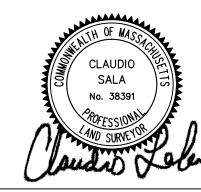

CLAUDIO SALA, PLS

GENERAL NOTES:

1. LOCUS: ASSESSORS MAP 51 BLOCK LOT 36 RECORD OWNER: COMPREHENSIVE LAND HOLDINGS DEED REFERENCE: CERTIFICATE #271959

PLAN REFERENCE: LC PLAN 2367-12

ELEVATIONS REFER TO NAVD-88.

3. EXISTING UTILITIES WHERE SHOWN IN THE DRAWINGS ARE FROM SURFACE OBSERVATION AND RECORD INFORMATION AND SHOULD BE CONSIDERED APPROXIMATE. THE CONTRACTOR SHALL BE RESPONSIBLE FOR PROPERLY LOCATING AND COORDINATING THE PROPOSED CONSTRUCTION ACTIVITY WITH DIG-SAFE AND THE APPLICABLE UTILITY COMPANIES AND MAINTAINING THE EXISTING UTILITY SYSTEM IN SERVICE.

DIG-SAFE SHALL BE NOTIFIED PER THE STATE OF MASSACHUSETTS STATUTE CHAPTER 82, SECTION 409 AT TEL. 1-888-344-7233. THE ENGINEER DOES NOT GUARANTEE THEIR ACCURACY OR THAT ALL UTILITIES AND SUBSURFACE STRUCTURES ARE SHOWN. LOCATIONS AND ELEVATIONS OF UNDERGROUND UTILITIES WERE TAKEN FROM RECORD PLANS. THE CONTRACTOR SHALL VERIFY SIZE, LOCATION, AND INVERTS OF UTILITIES AND STRUCTURES AS REQUIRED PRIOR TO THE START OF CONSTRUCTION.

4. THE LOT SHOWN DOES NOT LIE WITHIN A SPECIAL FLOOD HAZARD ZONE AS DELINEATED ON FIRM 25017C-00416E, DATED JUNE 4, 2010. 5. PARCEL IS ZONED SR-A.

PROJECT TITLE & LOCATION:

PROPOSED SITE PLAN 91 BEATRICE CIRCLE BELMONT, MASS.

EXISTING CONDITIONS

PREPARED FOR:

91 BEATRICE CIRCLE LLC c/o REGNANTE STERIO 401 EDGEWATER PL, SUITE 630 WAKEFIELD, MA 01880

ATE: AUGUST 12, 2020		
REVISED:		
OB NUMBER: 19.085	SHEET 2 OF 8	
20 10 0	20 40	
SCALE: 1"=20'		
JUALL, I -ZU		

<u>LEGEND:</u>

EXISTING: - LOCUS PROPERTY LINE SEWER MANHOLE (SMH) DRAIN MANHOLE (DMH) - CATCH BASIN (CB) STONEWALL - GAS VALVE WATER VALVE WATER SERVICE HYDRANT UTILITY POLE - NOW OR FORMERLY DRAIN PIPE - UNDERGROUND POWER - OVERHEAD WIRES ————— — SEWER MAIN LANDSCAPED AREA SPOT GRADE - × - × - × - - CHAIN LINK FENCE - STOCKADE FENCE TEST PIT HAND HOLES FOR UTILITIES

LIGHT POLE

FIRST FLOOR



DEMOLITION & CONSTRUCTION NOTES:

THE CONTRACTOR SHALL PLACE A 6' HIGH TEMPORARY SAFETY FENCE AROUND THE SITE PRIOR TO THE DEMOLITION ON SITE.

A WATER TRUCK SHALL BE ON-SITE DURING THE DEMOLITION PROCESS TO MINIMIZE FUGITIVE DUST.

A CRUSHED STONE APRON SHALL BE CONSTRUCTED AS SHOWN TO MINIMIZE TRUCK TIRES LEAVING SEDIMENT ON THE ROADWAYS.

ALL DEMOLITION DEBRIS SHALL BE REMOVED FROM THE SITE AND DISPOSED OF IN A LEGAL MANNER.

THE SITE AND THE CRUSHED STONE APRON SHALL BE GRADED TO PREVENT ANY SITE RUNOFF FROM FLOWING OFF SITE.


CONSTRUCTION HOURS SHALL BE FROM 7:00AM TO 5:00PM MONDAY THROUGH FRIDAY, 8:00AM TO 4:00PM ON SATURDAYS. ALL CONSTRUCTION AND DELIVERIES ARE PROHIBITED SUNDAYS UNLESS APPROVED BY THE BUILDING COMMISSIONER.


I FGENID.

	<u>LEGEND:</u>	
EXISTING:		PROPOSED:
	- LOCUS PROPERTY LINE	
	– TREE LINE	
\$	- SEWER MANHOLE (SMH)	S
0	- DRAIN MANHOLE (DMH)	0
\boxplus	- CATCH BASIN (CB)	\blacksquare
	- STONEWALL	au.
GV ⋈	- GAS VALVE	gv ⊠
wv 	- WATER VALVE	₩v ⊠
*80	- WATER SERVICE	*50
X	- HYDRANT	**
O	- UTILITY POLE	Q
N/F	- NOW OR FORMERLY	
D	- DRAIN PIPE	
W	- WATER MAIN	w
	- GAS SERVICE	G
UGE	- UNDERGROUND POWER	UGE
———ОН W———	- OVERHEAD WIRES	ОНW
s	- SEWER MAIN	s
LSA	- LANDSCAPED AREA	LSA
	- GRADE	25
x25.7	- SPOT GRADE	x25.7
— x —— x —— x —	- CHAIN LINK FENCE	
- 	- CHAIN LINK FENCE	
	- TEST PIT	
	- HAND HOLES FOR UTILITIES	
\$	- LIGHT POLE	\$
FF	- FIRST FLOOR	FF
TOF	- TOP OF FOUNDATION	TOF
GF	- GARAGE FLOOR	GF
	- SECOND FLOOR	SF

EROSION CONTROL

CONCORD TURNPIKE

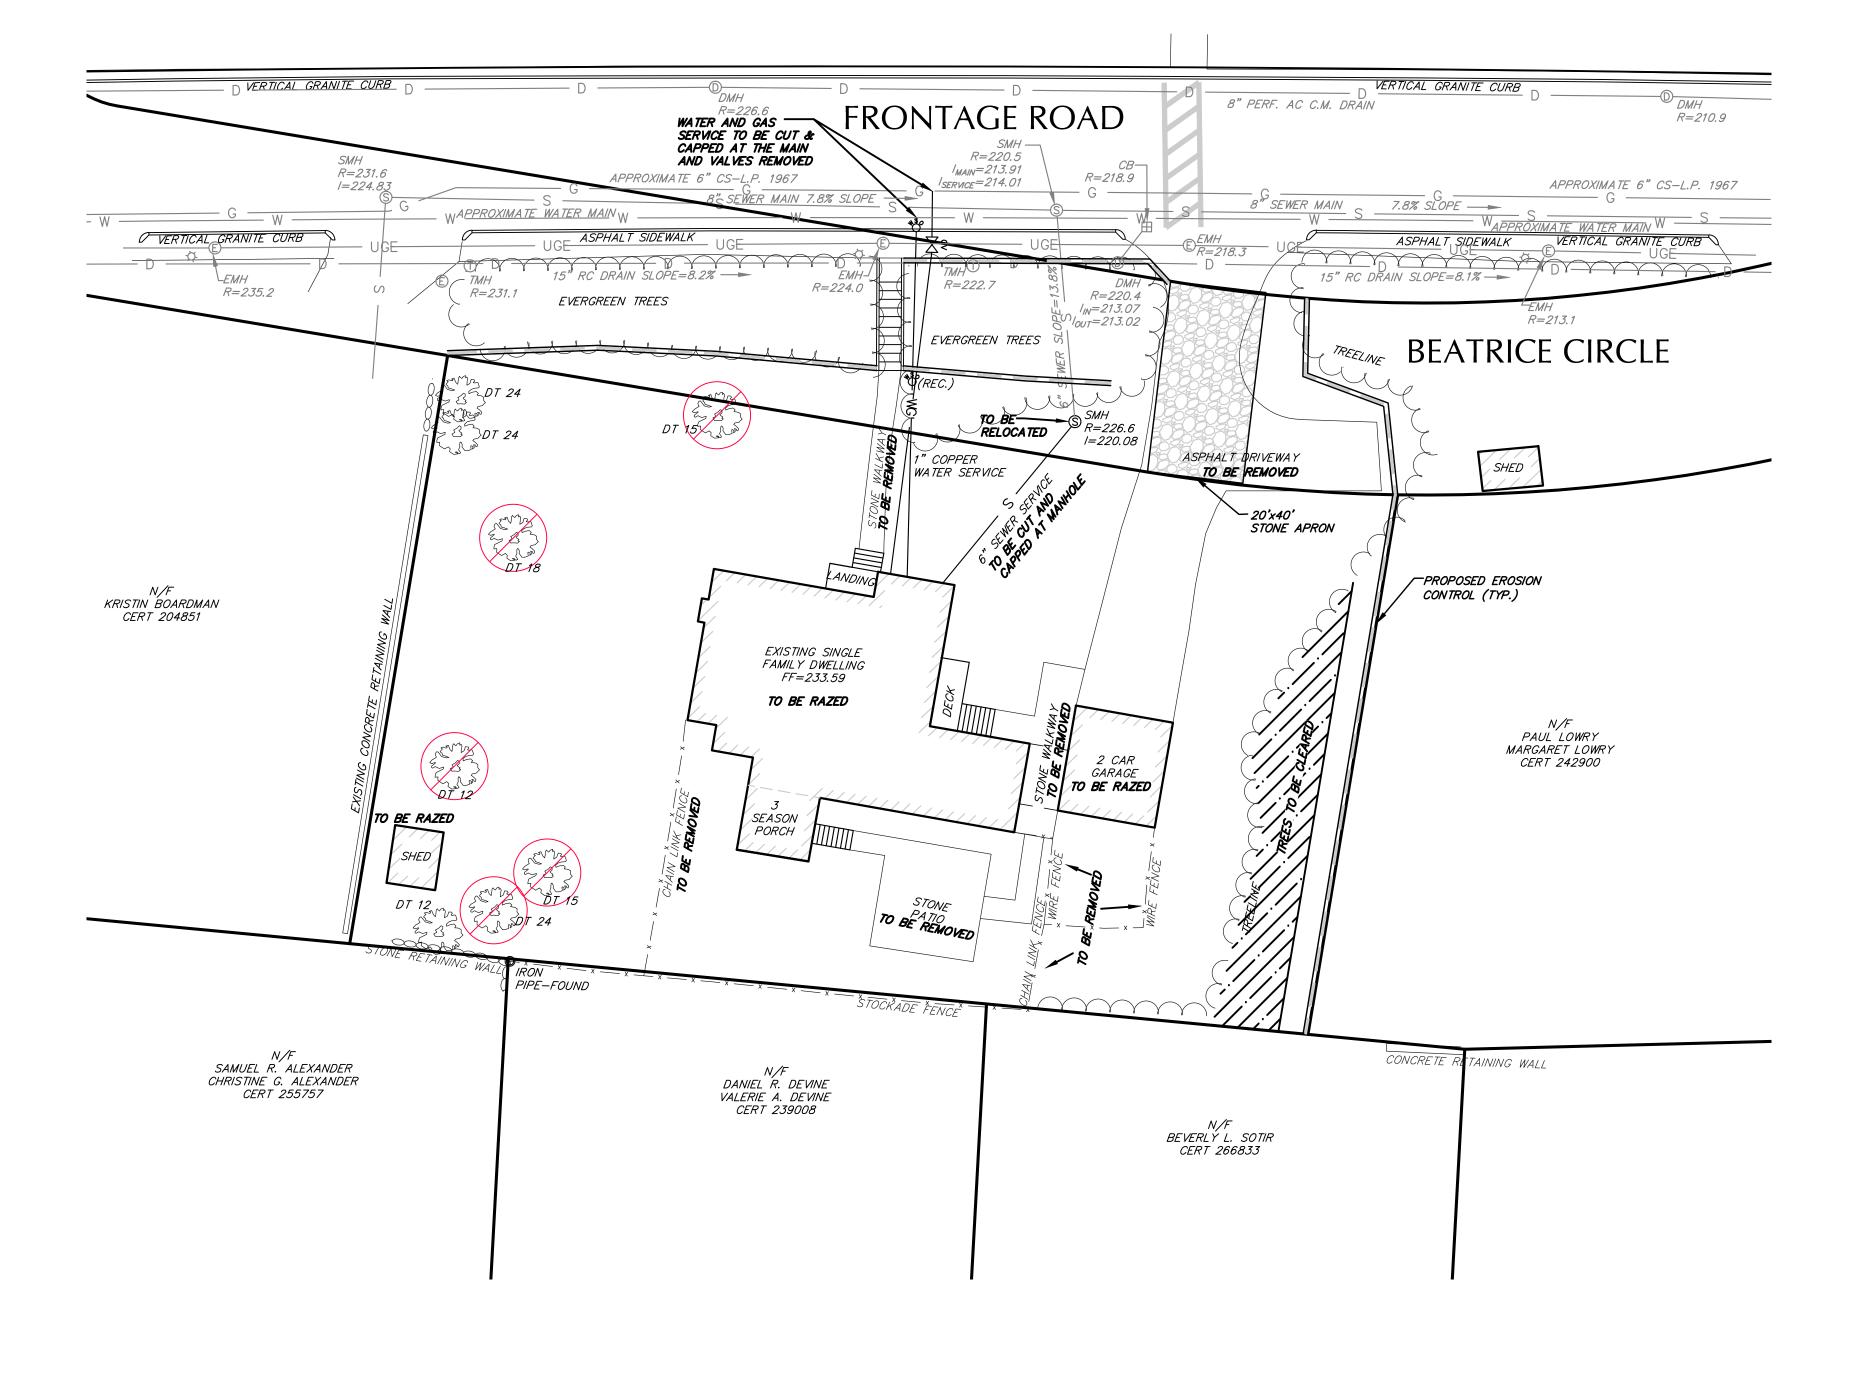

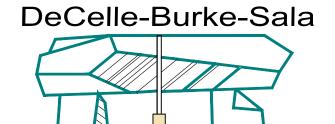

& Associates, Inc.

1266 Furnace Brook Parkway #401 Quincy, MA 02169 617-405-5100(o) 617-405-5101(f)

www.decellè-burke-sala.com`



JAMES W BURKE, P.E.

GENERAL NOTES:

1. LOCUS: ASSESSORS MAP 51 BLOCK LOT 36

RECORD OWNER: COMPREHENSIVE LAND HOLDINGS DEED REFERENCE: CERTIFICATE #271959 PLAN REFERENCE: LC PLAN 2367-12

ELEVATIONS REFER TO NAVD-88.

EXISTING UTILITIES WHERE SHOWN IN THE DRAWINGS ARE FROM SURFACE OBSERVATION AND RECORD INFORMATION AND SHOULD BE CONSIDERED APPROXIMATE. THE CONTRACTOR SHALL BE RESPONSIBLE FOR PROPERLY LOCATING AND COORDINATING THE PROPOSED CONSTRUCTION ACTIVITY WITH DIG-SAFE AND THE APPLICABLE UTILITY COMPANIES AND MAINTAINING THE EXISTING UTILITY SYSTEM IN SERVICE.

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PARCEL IS ZONED SR-A.

PROJECT TITLE & LOCATION:


PROPOSED SITE PLAN 91 BEATRICE CIRCLE BELMONT, MASS.

DEMOLITION

PREPARED FOR:

91 BEATRICE CIRCLE LLC c/o REGNANTE STERIO 401 EDGEWATER PL, SUITE 630 WAKEFIELD, MA 01880

ATE: AUGUST 12, 2020		
EVISED:		
OB NUMBER: 19.085	SHEET 3 OF	8
20 10 0	20	40
SCALE: 1"=20'		
SCALE. 1 -20		

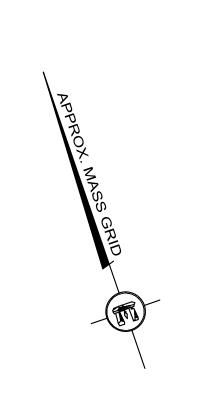


CONCORD TURNPIKE

<u>DIMENSIONAL REQUIREMENTS</u>		<u>EXISTING</u>	<u>PROPOS</u>
MINIMUM LOT AREA (SQ.FT.)	25,000	23,496	23,496
MINIMUM FRONTAGE (FT.)	125	200	200
MAX. BUILDING HEIGHT (FT.)	36		
MIN. SETBACKS (FT.)			
FRONT	30	29.7'	8.4'
SIDE	15	38.4'	12.2'
REAR	40	26.0'	11.0'
MAXIMUM LOT COVERAGE	20%	14.5%	33.0%
MINIMUM OPEN SPACE	50%	81.4%	34.3%


I FGEND:

	<u>LEGEND:</u>	
EXISTING:		PROPOSED:
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. ~ .	– TREE LINE	
<u>\$</u>	- SEWER MANHOLE (SMH)	S
0	- DRAIN MANHOLE (DMH)	©
\blacksquare	- CATCH BASIN (CB)	\blacksquare
	- STONEWALL	
©V GV	- GAS VALVE	ĕv
wv 	- WATER VALVE	w∨ ⊠
*\$0	- WATER SERVICE	*
₩.	- HYDRANT	\bowtie
D	- UTILITY POLE	Q
N/F	- NOW OR FORMERLY	
D	- DRAIN PIPE	D
	- WATER MAIN	w
	- GAS SERVICE	
UGE	- UNDERGROUND POWER	UGE
OHW	- OVERHEAD WIRES	ОНW
s	- SEWER MAIN	s
LSA	- LANDSCAPED AREA	LSA
	- GRADE	25
x25.7	- SPOT GRADE	x25.7
— x — x — x — x —	- CHAIN LINK FENCE	
	- CHAIN LINK FENCE	
	- TEST PIT	
	- HAND HOLES FOR UTILITIES	
\$	- LIGHT POLE	\$
FF	- FIRST FLOOR	FF
TOF	- TOP OF FOUNDATION	TOF
GF	- GARAGE FLOOR	GF
	- SECOND FLOOR	SF

EROSION CONTROL

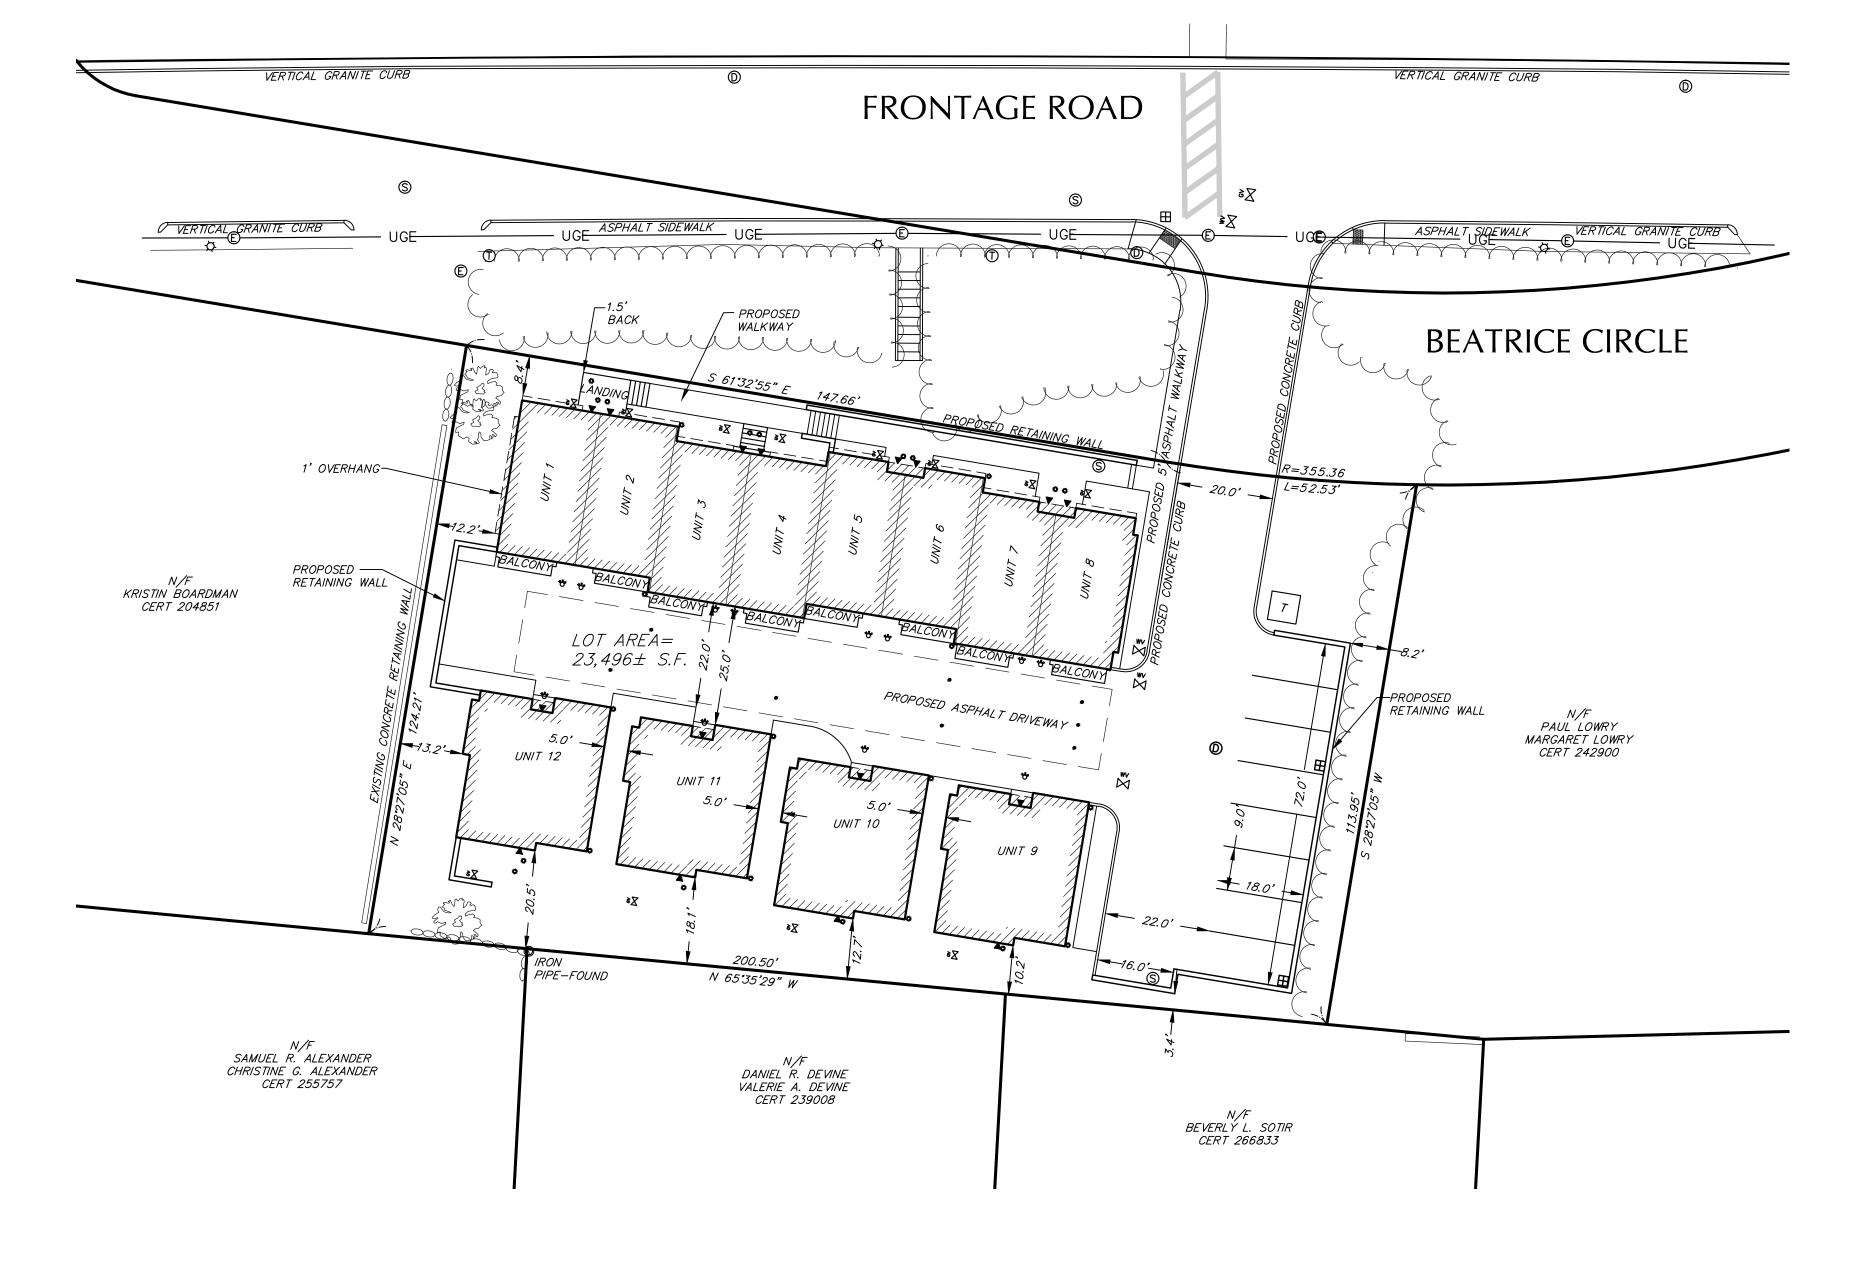



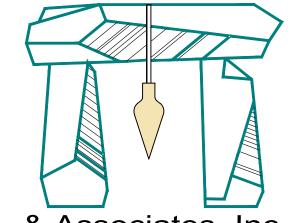

& Associates, Inc.

1266 Furnace Brook Parkway #401 Quincy, MA 02169 617-405-5100(o) 617-405-5101(f) www.decelle-burke-sala.com



JAMES W BURKE, P.E.

GENERAL NOTES:

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5. PARCEL IS ZONED SR-A.

6. FOR PROPOSED BUILDING DIMENSIONS SEE ARCHITECTS PLAN TITLED "91 BEATRICE CIRCLE, BELMONT, MA, PEL SUBMISSION" DATED AUGUST 11, 2020 BY EMBARC.

PROJECT TITLE & LOCATION:

PROPOSED SITE PLAN 91 BEATRICE CIRCLE BELMONT, MASS.

PLAN TITL

PROPOSED LAYOUT

PREPARED FOR:

91 BEATRICE CIRCLE LLC c/o REGNANTE STERIO 401 EDGEWATER PL, SUITE 630 WAKEFIELD, MA 01880


DATE: AUGUST 12, 2020

JOB NUMBER: 19.085 SHEET 4 OF 8

20 10 0

CONCORD TURNPIKE VERTICAL GRANITE CURB FRONTAGE ROAD UGE ASPHALT SIDEWALK UGE ASPHALT SIDEWALK VERTICAL GRANITE CURB UGE BEATRICE CIRCLE N/F KRISTIN BOARDMAN CERT 204851 <u>LEGEND:</u> EXISTING: PROPOSED: - LOCUS PROPERTY LINE PROPOSED RETAINING WALL N/F PAUL LOWRY MARGARET LOWRY CERT 242900 - SEWER MANHOLE (SMH) DRAIN MANHOLE (DMH) | R=224.5 CATCH BASIN (CB) - STONEWALL - GAS VALVE TW=225.0 BW=MATCH EXISTING GRADE WATER VALVE UNIT 9 WATER SERVICE HYDRANT UTILITY POLE NOW OR FORMERLY V R=2. DRAIN PIPE ____ — WATER MAIN _____ – GAS SERVICE N/F SAMUEL R. ALEXANDER CHRISTINE G. ALEXANDER CERT 255757 -UGE----- - UNDERGROUND POWER DANIEL R. DEVINE VALERIE A. DEVINE CERT 239008 _______ - SEWER MAIN N/F BEVERLY L. SOTIR CERT 266833 LANDSCAPED AREA SPOT GRADE x25.7 - x - x - x - - CHAIN LINK FENCE - CHAIN LINK FENCE - TEST PIT HAND HOLES FOR UTILITIES LIGHT POLE FIRST FLOOR TOP OF FOUNDATION GARAGE FLOOR SECOND FLOOR EROSION CONTROL



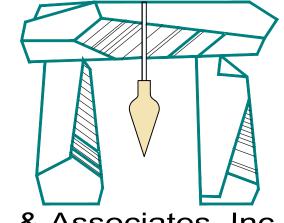

& Associates, Inc.

1266 Furnace Brook Parkway #401 Quincy, MA 02169 617-405-5100(o) 617-405-5101(f) www.decelle-burke-sala.com



JAMES W BURKE, P.E.

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5. PARCEL IS ZONED SR-A.

PROJECT TITLE & LOCATION:

PROPOSED SITE PLAN 91 BEATRICE CIRCLE BELMONT, MASS.

AN TITLE:

PROPOSED GRADING


PREPARED FOR:

91 BEATRICE CIRCLE LLC c/o REGNANTE STERIO 401 EDGEWATER PL, SUITE 630 WAKEFIELD, MA 01880

DATE:	AUGUST 12, 2020	
REVISE	ED:	

JOB NUMBER	R: 19.0	85	SHEET	5	OF	8	
20	10	0	20			40	

SCALE: 1"=20

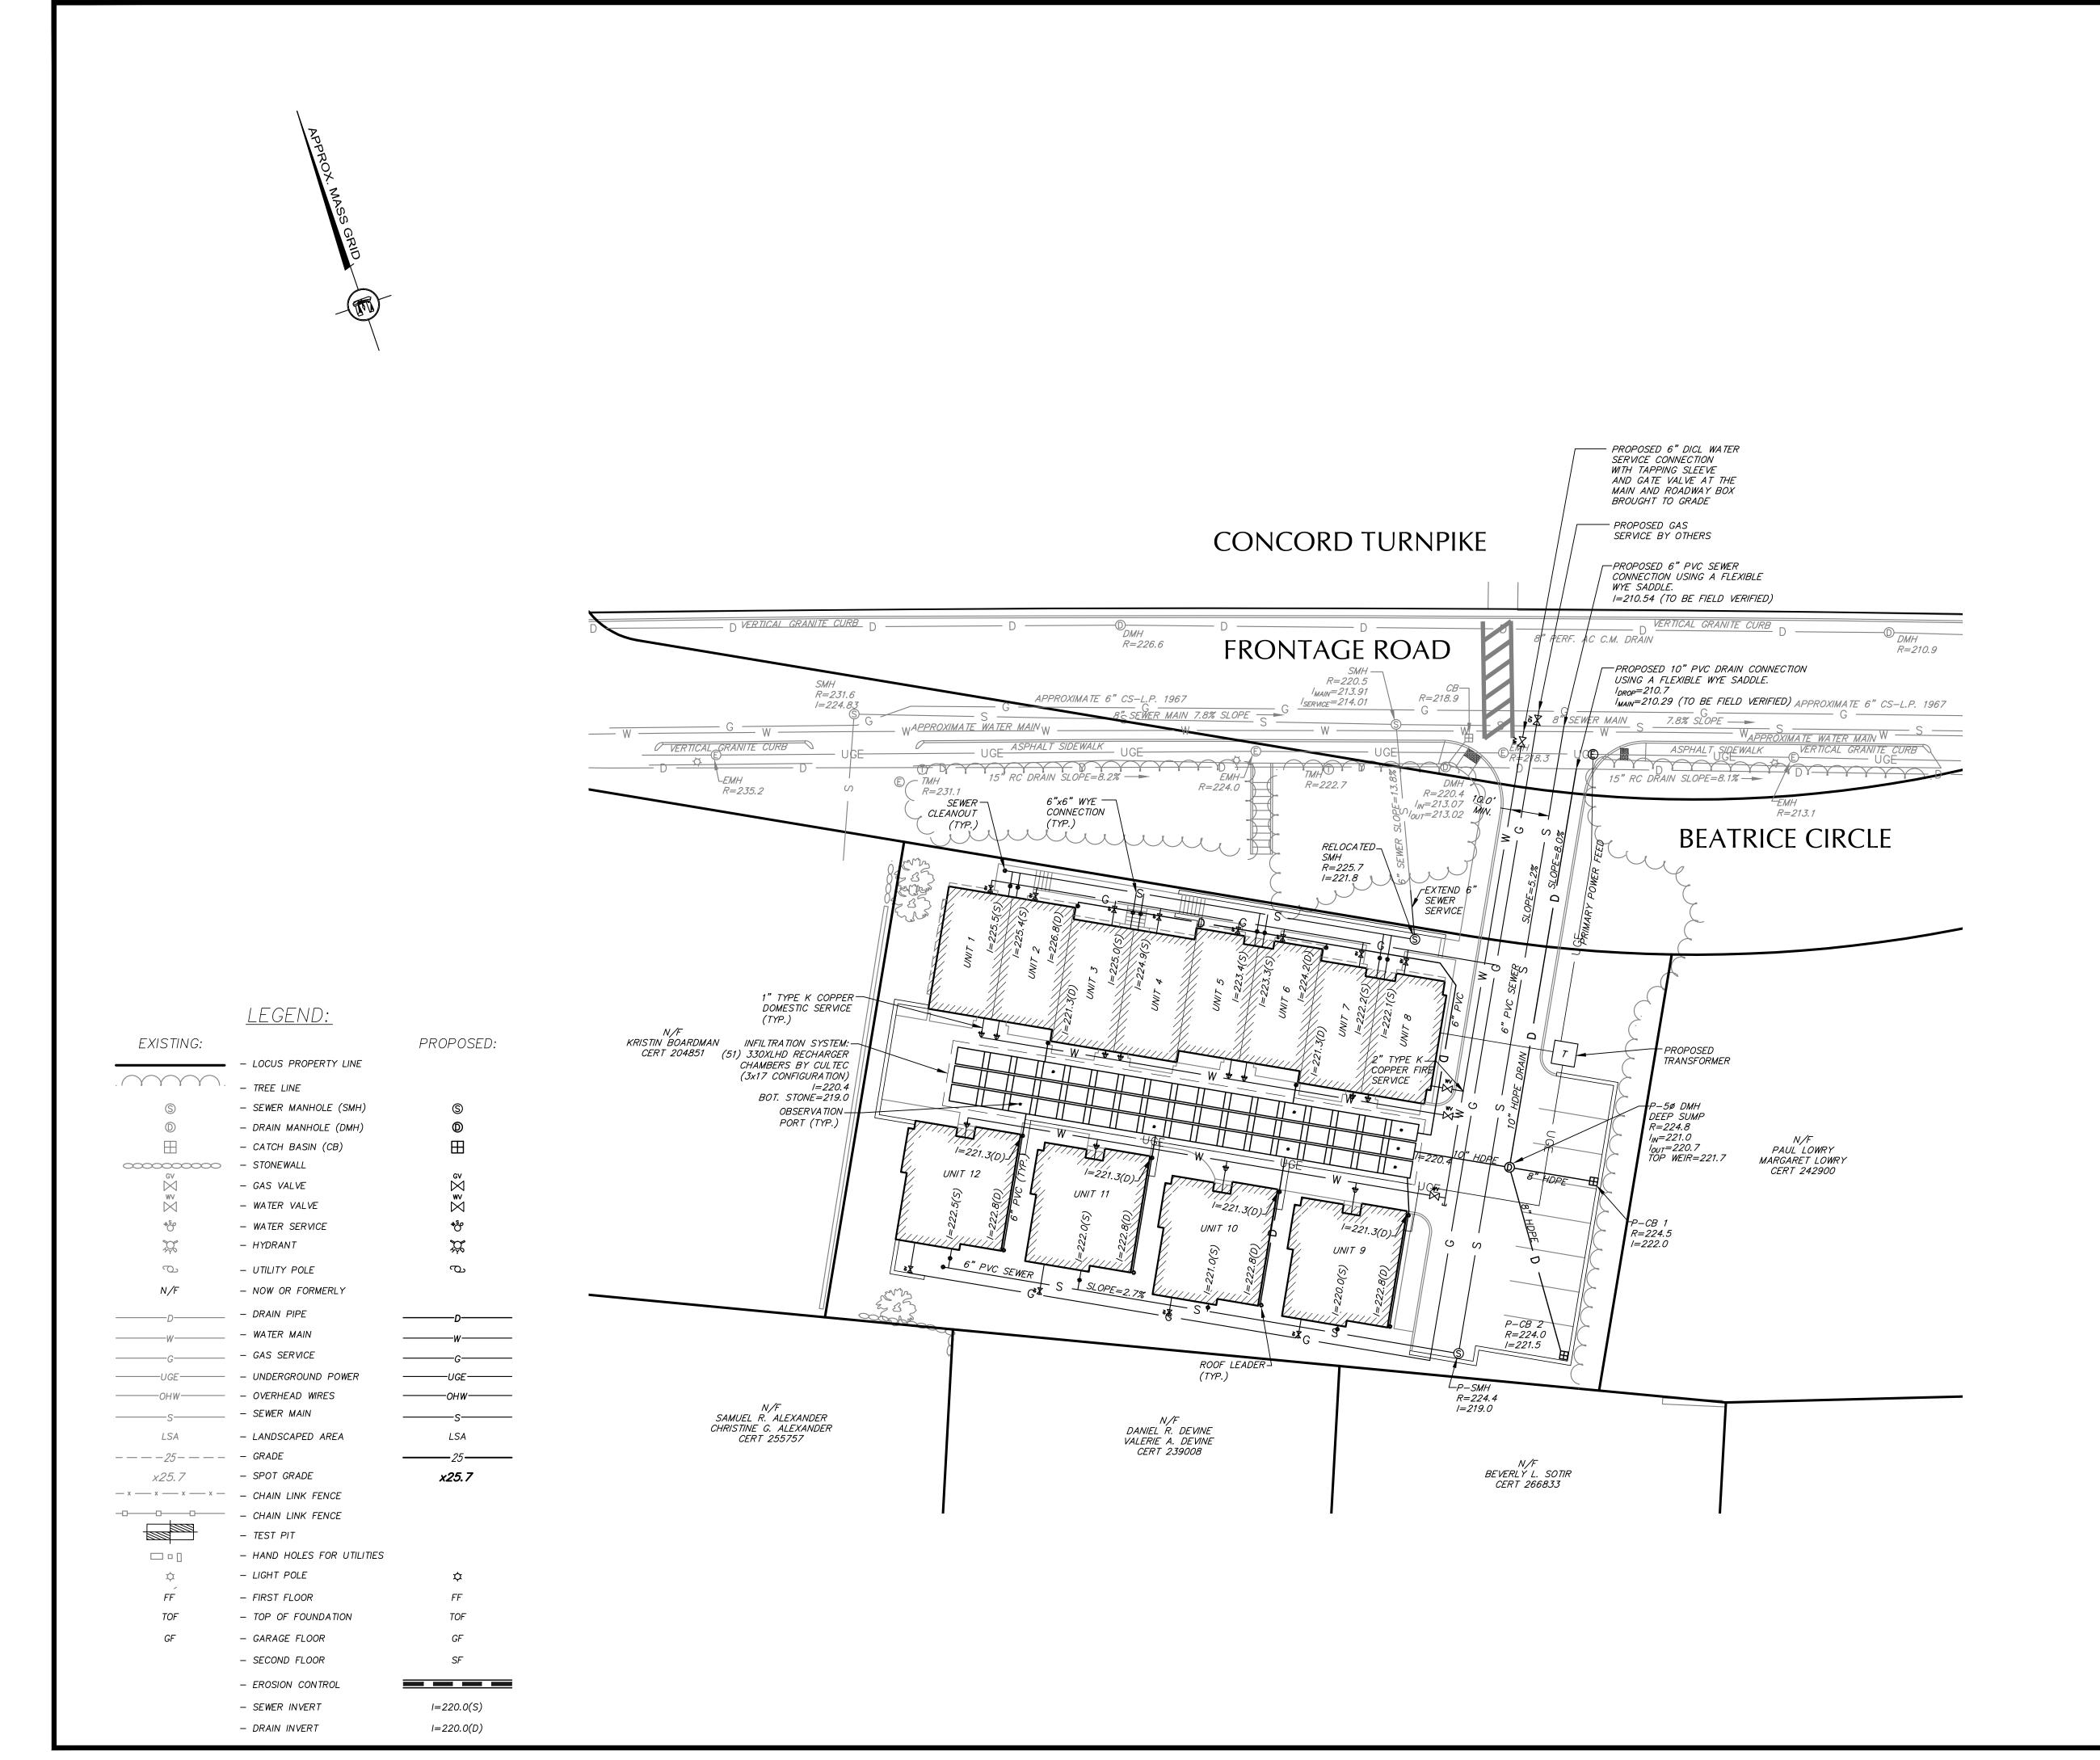





JAMES W BURKE, P.E.

GENERAL NOTES:

1. LOCUS: ASSESSORS MAP 51 BLOCK LOT 36

RECORD OWNER: COMPREHENSIVE LAND HOLDINGS
DEED REFERENCE: CERTIFICATE #271959

PLAN REFERENCE: LC PLAN 2367-12

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PROJECT TITLE & LOCATION:

PROPOSED SITE PLAN 91 BEATRICE CIRCLE BELMONT, MASS.


PLAN TITLE:

PROPOSED UTILITIES

PREPARED FOR:

91 BEATRICE CIRCLE LLC c/o REGNANTE STERIO 401 EDGEWATER PL, SUITE 630 WAKEFIELD, MA 01880

ATE: AUGUST 12, 2020	
EVISED:	
OB NUMBER: 19.085	SHEET 6 OF 8
20 10 0	20 40
SCALE: 1"=20'	
30ALL. 1 -20	

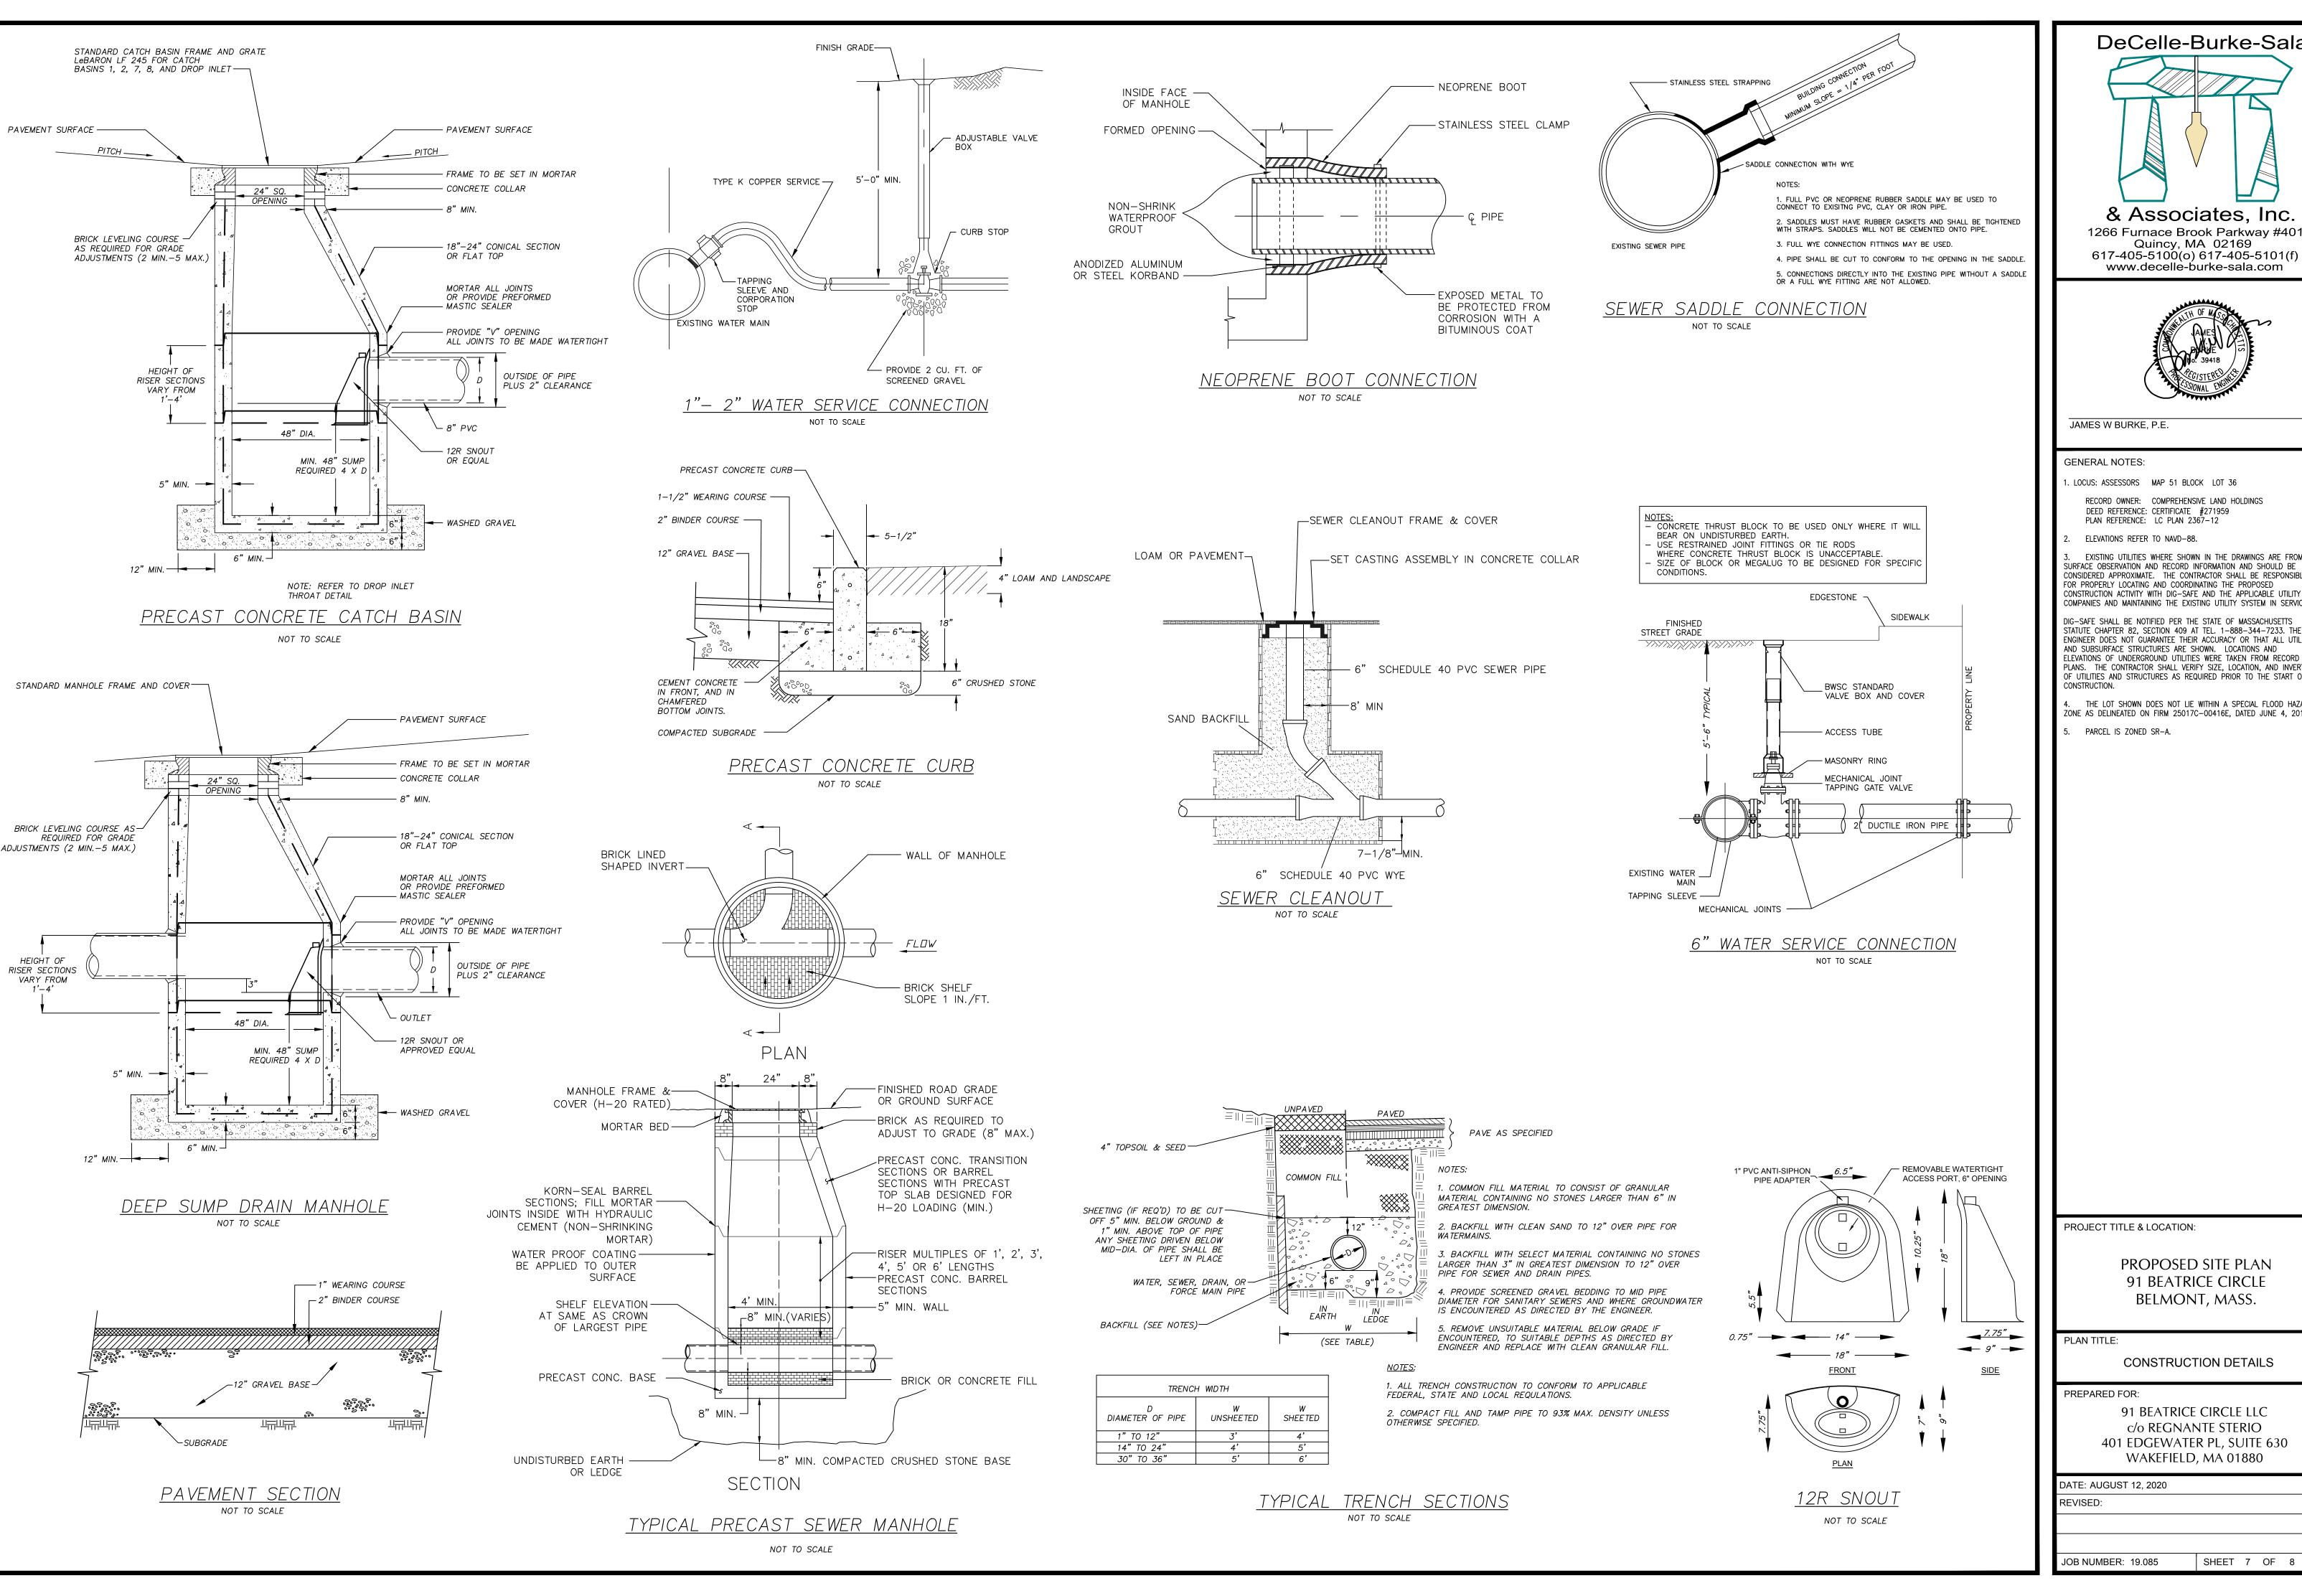



Quincy, MA 02169

www.decelle-burke-sala.com



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1. LOCUS: ASSESSORS MAP 51 BLOCK LOT 36 RECORD OWNER: COMPREHENSIVE LAND HOLDINGS DEED REFERENCE: CERTIFICATE #271959 PLAN REFERENCE: LC PLAN 2367-12

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PROJECT TITLE & LOCATION:

PROPOSED SITE PLAN 91 BEATRICE CIRCLE BELMONT, MASS.

PLAN TITLE:


CONSTRUCTION DETAILS

PREPARED FOR:

91 BEATRICE CIRCLE LLC c/o REGNANTE STERIO 401 EDGEWATER PL, SUITE 630 WAKEFIELD, MA 01880

DATE: AUGUST 12, 2020 REVISED:

JOB NUMBER: 19.085 SHEET 7 OF 8

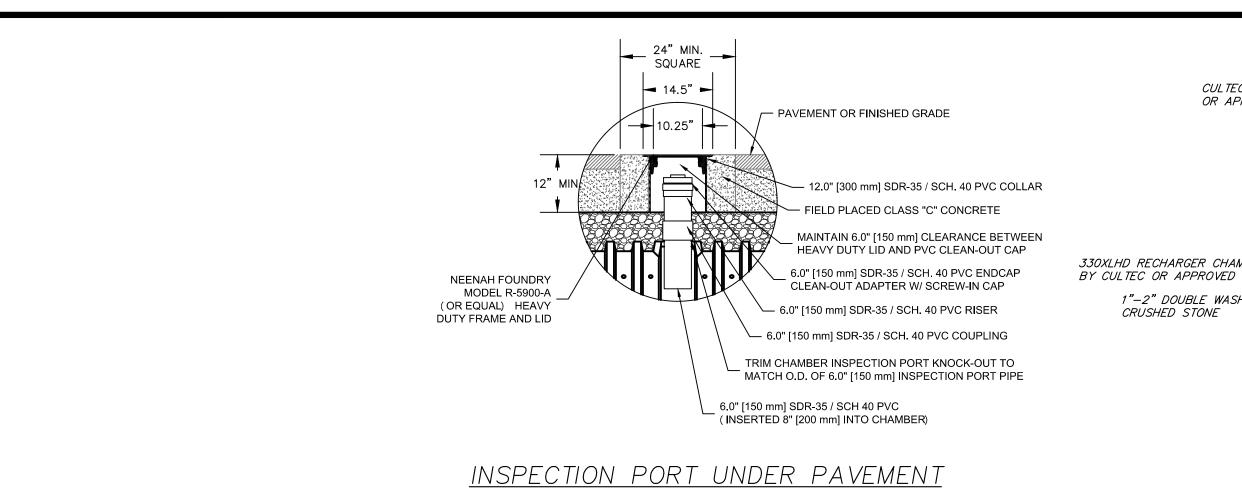

— PAVEMENT SURFACE

CONCRETE COLLAR

OR FLAT TOP

MORTAR ALL JOINTS

- PROVIDE "V" OPENING

ALL JOINTS TO BE MADE WATERTIGHT

OUTSIDE OF PIPE

PLUS 2" CLEARANCE

- MASTIC SEALER

- 10" HDPE OUTLET

APPROVED EQUAL

<8" HDPE INLET


— 10R SNOUT OR

₩ASHED GRAVEL


OR PROVIDE PREFORMED

FRAME TO BE SET IN MORTAR

- 18"-24" CONICAL SECTION

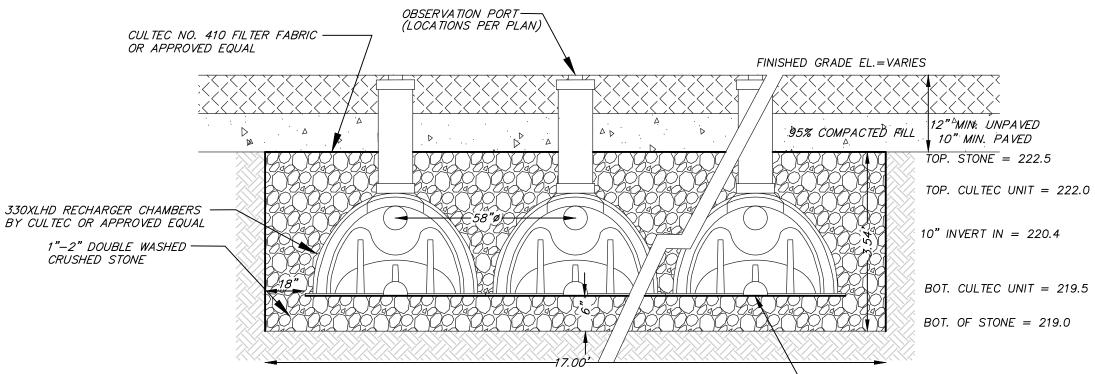


- CULTEC NO. 66 WOVEN GEOTEXTILE (FOR SCOUR PROTECTION) TO BE PLACED BENEATH ALL INLET/OUTLET PIPES

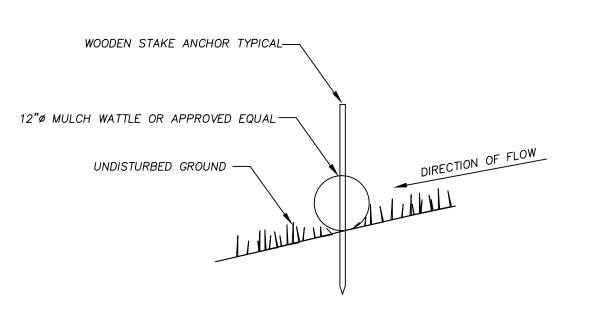

MULCH WATTLE OR EQUIVALANT NOT TO SCALE

CULTEC CHAMBER TYPICAL SECTION

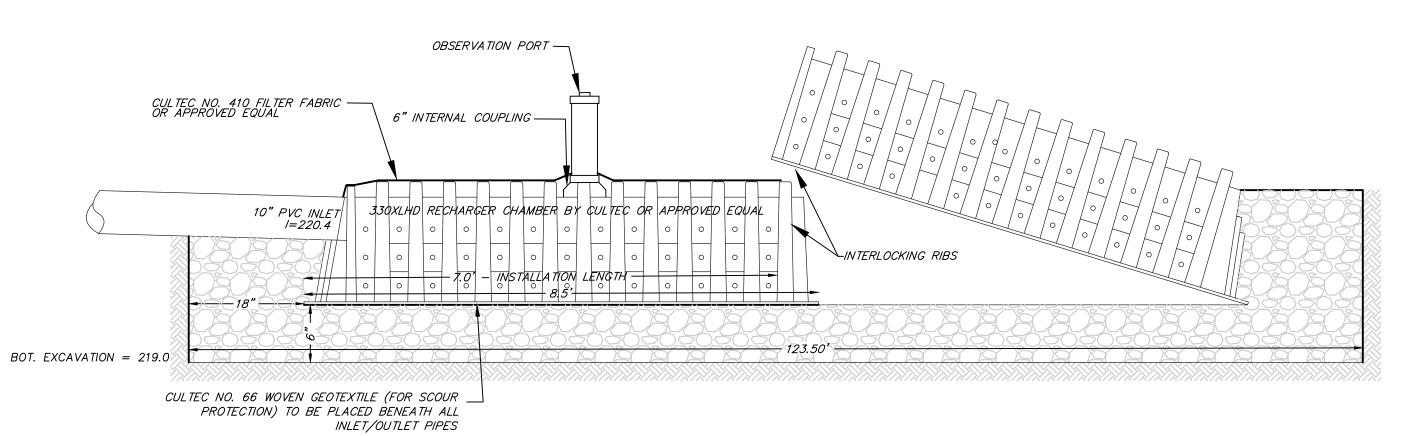

OBSERVATION PORT INSTALLATION NOTES: CONTRACTOR TO CUT 6" HOLE AT TOP OF CHAMBER

IN THE CENTER OF THE UNIT. INSERT A 6" INTERNAL COUPLING INTO INSPECTION PORT OPENING.

USE A 6" SCH.40 PVC PIPE TO BRING INSPECTION PORT TO WITHIN 6" OF FINISHED GRADE. INSTALL A 6" SCH.40 END CAP OR PLUG. BACKFILL IN ACCORDANCE WITH SPECIFICATIONS.

CULTEC CHAMBER INSTALLATION NOTES:

CONTRACTOR TO INSTALL CULTEC CHAMBERS IN ACCORDANCE WITH MANUFACTURERS SPECIFICATIONS. CULTEC NO. 410 FILTER FABRIC OR APPROVED EQUAL TO BE PLACED OVER THE TOP OF THE DRAINAGE SYSTEM PRIOR TO BACKFILL.

CONTACTOR TO REMOVE ALL LOAM, SUBSOIL AND ALL DELETERIOUS MATERIAL FROM EXCAVATION PRIOR TO PLACEMENT OF THE STONE BED.

CRUSHED STONE - (3/4" TO 1-1/2") REMOVE EXISTING PAVEMENT AND REPLACE WITH 6" OF CRUSHED STONE AS DEPICTED. PAVEMENT -UNDISTURBED MATERIAL

- FINISHED GRADE

-LIMIT CHANGES IN BASE ELEVATION

-STEP OFTEN ENOUGH TO MAINTAIN MINIMUM REQUIRED EMBEDMENT

TO 6" PER STEP TO AVOID DIFFERENTIAL SETTLEMENT


20'x40' CRUSHED STONE APRON

- RANDOMLY STAGGER

VERTICAL JOINTS

-BURY ONE ADDITIONAL


FULL UNIT MIN.

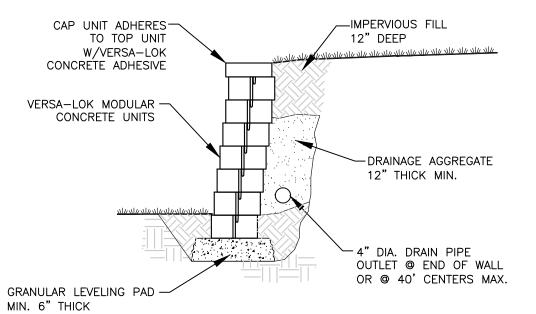


CULTEC CHAMBER TYPICAL PROFILE

NOT TO SCALE

TYPICAL SECTION-UNREINFORCED RETAINING WALL

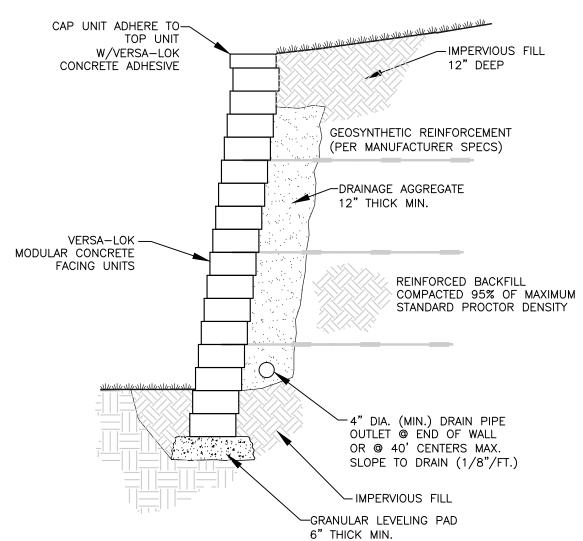

TYPICAL SECTION-REINFORCED RETAINING WAL NOT TO SCALE

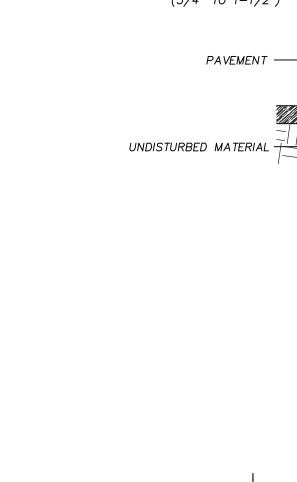

GRANULAR LEVELING -

UNDISTURBED SOIL

PAD 6" THICK

DEEP SUMP DRAIN MANHOLE NOT TO SCALE

CONCRETE WEIR

TOP OF WEIR=221.7

5'ø DMH

60" DIA.

MIN. 48" SUMP

10" HDPE OVERFLOW

I=218.9

STANDARD MANHOLE FRAME AND COVER-

BRICK LEVELING COURSE AS-

ADJUSTMENTS (2 MIN.-5 MAX.)

HEIGHT OF

RISER SECTIONS

VARY FROM

REQUIRED FOR GRADE

6" MIN. —►

12" MIN. ────


10" HDPE OUTLET

ALL OUTLETS TO BE FITTED WITH A 10R SNOUT OR

1 = 220.7

APPROVED EQUIVALENT

TO SYSTEM

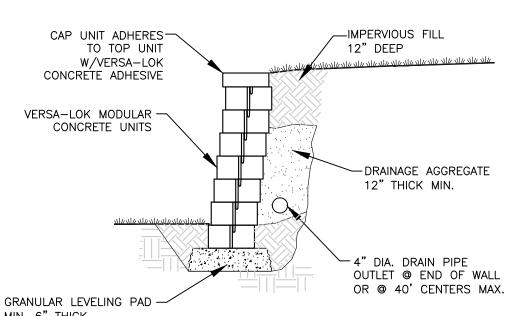

NOT TO SCALE

PLAN TITLE:

PROJECT TITLE & LOCATION:

PREPARED FOR:

91 BEATRICE CIRCLE LLC c/o REGNANTE STERIO 401 EDGEWATER PL, SUITE 630 WAKEFIELD, MA 01880

PROPOSED SITE PLAN

91 BEATRICE CIRCLE

BELMONT, MASS.

CONSTRUCTION DETAILS

DeCelle-Burke-Sala

& Associates, Inc.

1266 Furnace Brook Parkway #401

Quincy, MA 02169

617-405-5100(o) 617-405-5101(f)

www.decelle-burke-sala.com

JAMES W BURKE, P.E.

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ELEVATIONS REFER TO NAVD-88.

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ZONE AS DELINEATED ON FIRM 25017C-00416E, DATED JUNE 4, 2010.

GENERAL NOTES:

CONSTRUCTION.

PARCEL IS ZONED SR-A.

DATE: AUGUST 12, 2020 REVISED:

JOB NUMBER: 19.085 SHEET 8 OF 8

NOT TO SCALE

STEPPING BASE DETAIL