

# CUSHING VILLAGE

BELMONT, MASSACHUSETTS

2D DRAWING SET CURRENT AS OF 11 JULY 2013

FINAL REVIEW SET

(SP-REV #4

## PROJECT TEAM

#### **OWNER**

#### SMITH LEGACY PARTNERS LLC 6 LITTLEFIELD ROAD

ACTON, MA, 01720

#### **LEGAL COUNSEL**

FLETCHER TILTON, P.C. 370 MAIN ST WORCESTER, MA, 01680

#### **ARCHITECT**

### PETER QUINN ARCHITECTS LLC 1904 MASSACHUSETTS AVE CAMBRIDGE, MA, 02140

#### **CONSULTING ARCHITECT**

#### LINE COMPANY ARCHITECTS, INC 760 MAIN ST WALTHAM, MA, 02451

#### **CIVIL ENGINEER**

## ALLEN & MAJOR ASSOCIATES INC 250 COMMERCIAL ST, SUITE 1001 MANCHESTER, NH, 03101

#### LANDSCAPE ARCHITECT

BLAIR HINES DESIGN ASSOCIATES 318 HARVARD ST, SUITE 25 BROOKLINE, MA, 02446

#### Blair Hines Design Associates LANDSCAPE ARCHITECTS

# OCUS MAP



# LIST OF DRAWINGS ARE MARKED REV- #4

## COVER SHEET / DRAWING LIST

## ZONING COMPLIANCE

- FAR
- **BUILDING HEIGHT & DIMENSIONAL TABLE**
- SETBACKS & BUILDING STEPPING 4TH LEVEL ANALYSIS

## EXISTING CONDITIONS PLOT PLAN

TOPOGRAPHIC PLAN

### CIVIL ENGINEERING

**ABBREVIATION & NOTES** LAYOUT & MATERIALS C-3 **GRADING & DRAINAGE** C-4 UTILITY WB50 TRUCK MOVEMENT LADDER TRUCK MOVEMENT C-6 **EROSION CONTROL** D-1 **DETAILS** D-2 **DETAILS D-**3 **DETAILS** 

### LANDSCAPE

**DETAILS** 

D-4

LAYOUT & MATERIALS PLAN
LAYOUT & MATERIALS PLAN
LAYOUT & MATERIALS PLAN
PLANTING PLAN
PLANTING PLAN
PLANTING PLAN
DETAILS
DETAILS
DETAILS
DETAILS
LIGHTING LEVEL CALCULATION
LIGHTING GRAPHICS AND FIXTURES

## ARCHITECTURAL

A1.0	UNDERGROUND PARKING PLAN
A1.1	SITE PLAN / BUILDING PLAN AT GRADE
A1.2	SECOND LEVEL PLAN / HYLAND STREET LEVEL
A1.3	THIRD LEVEL PLAN /HYLAND FIRST LEVEL
A1.4	FOURTH LEVEL PLAN / HYLAND SECOND LEVEL (ROOF PLAN WINSLOW)
A1.5	HYLAND THIRD LEVEL (ROOF PLAN POMONA)
A1.6	ROOF PLAN HYLAND
A2.1	THE WINSLOW: BUILDING 1 ELEVATIONS
A2.2	THE WINSLOW: BUILDING 1 ELEVATIONS
A2.3	THE POMONA: BUILDING 2 ELEVATIONS
A2.4	THE POMONA: BUILDING 2 ELEVATIONS
A2.5	THE HYLAND: BUILDING 3 ELEVATIONS
A2.6	THE HYLAND: BUILDING 3 ELEVATIONS
A3.1	SITE SECTIONS
A3.2	SITE SECTIONS















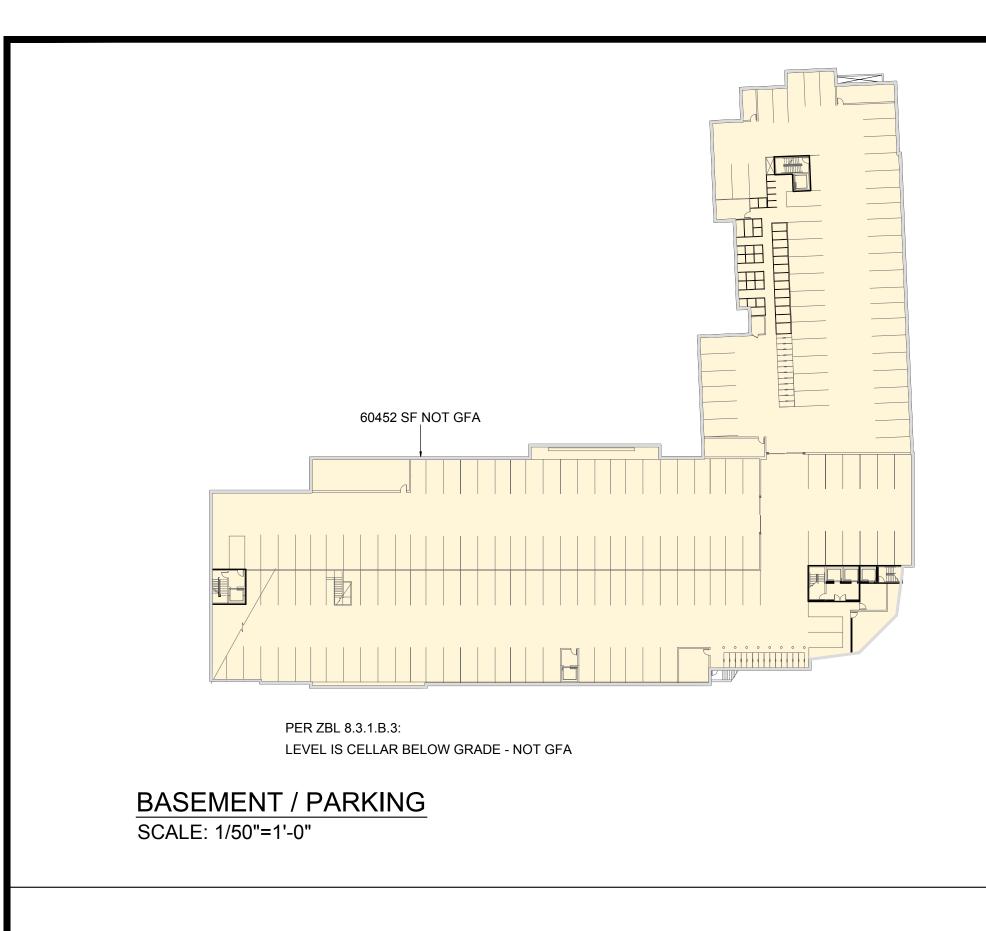

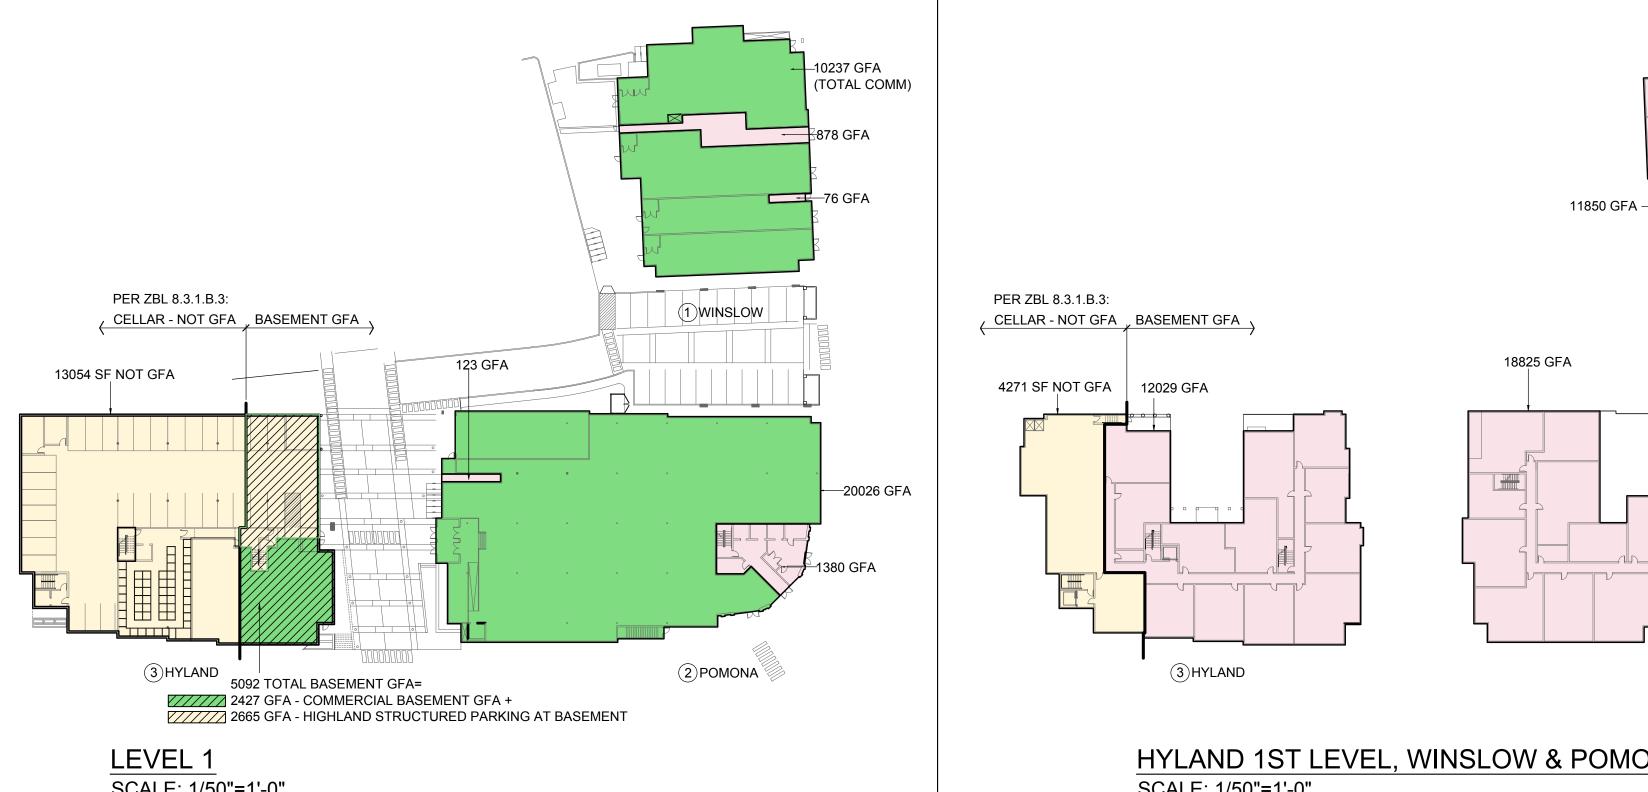

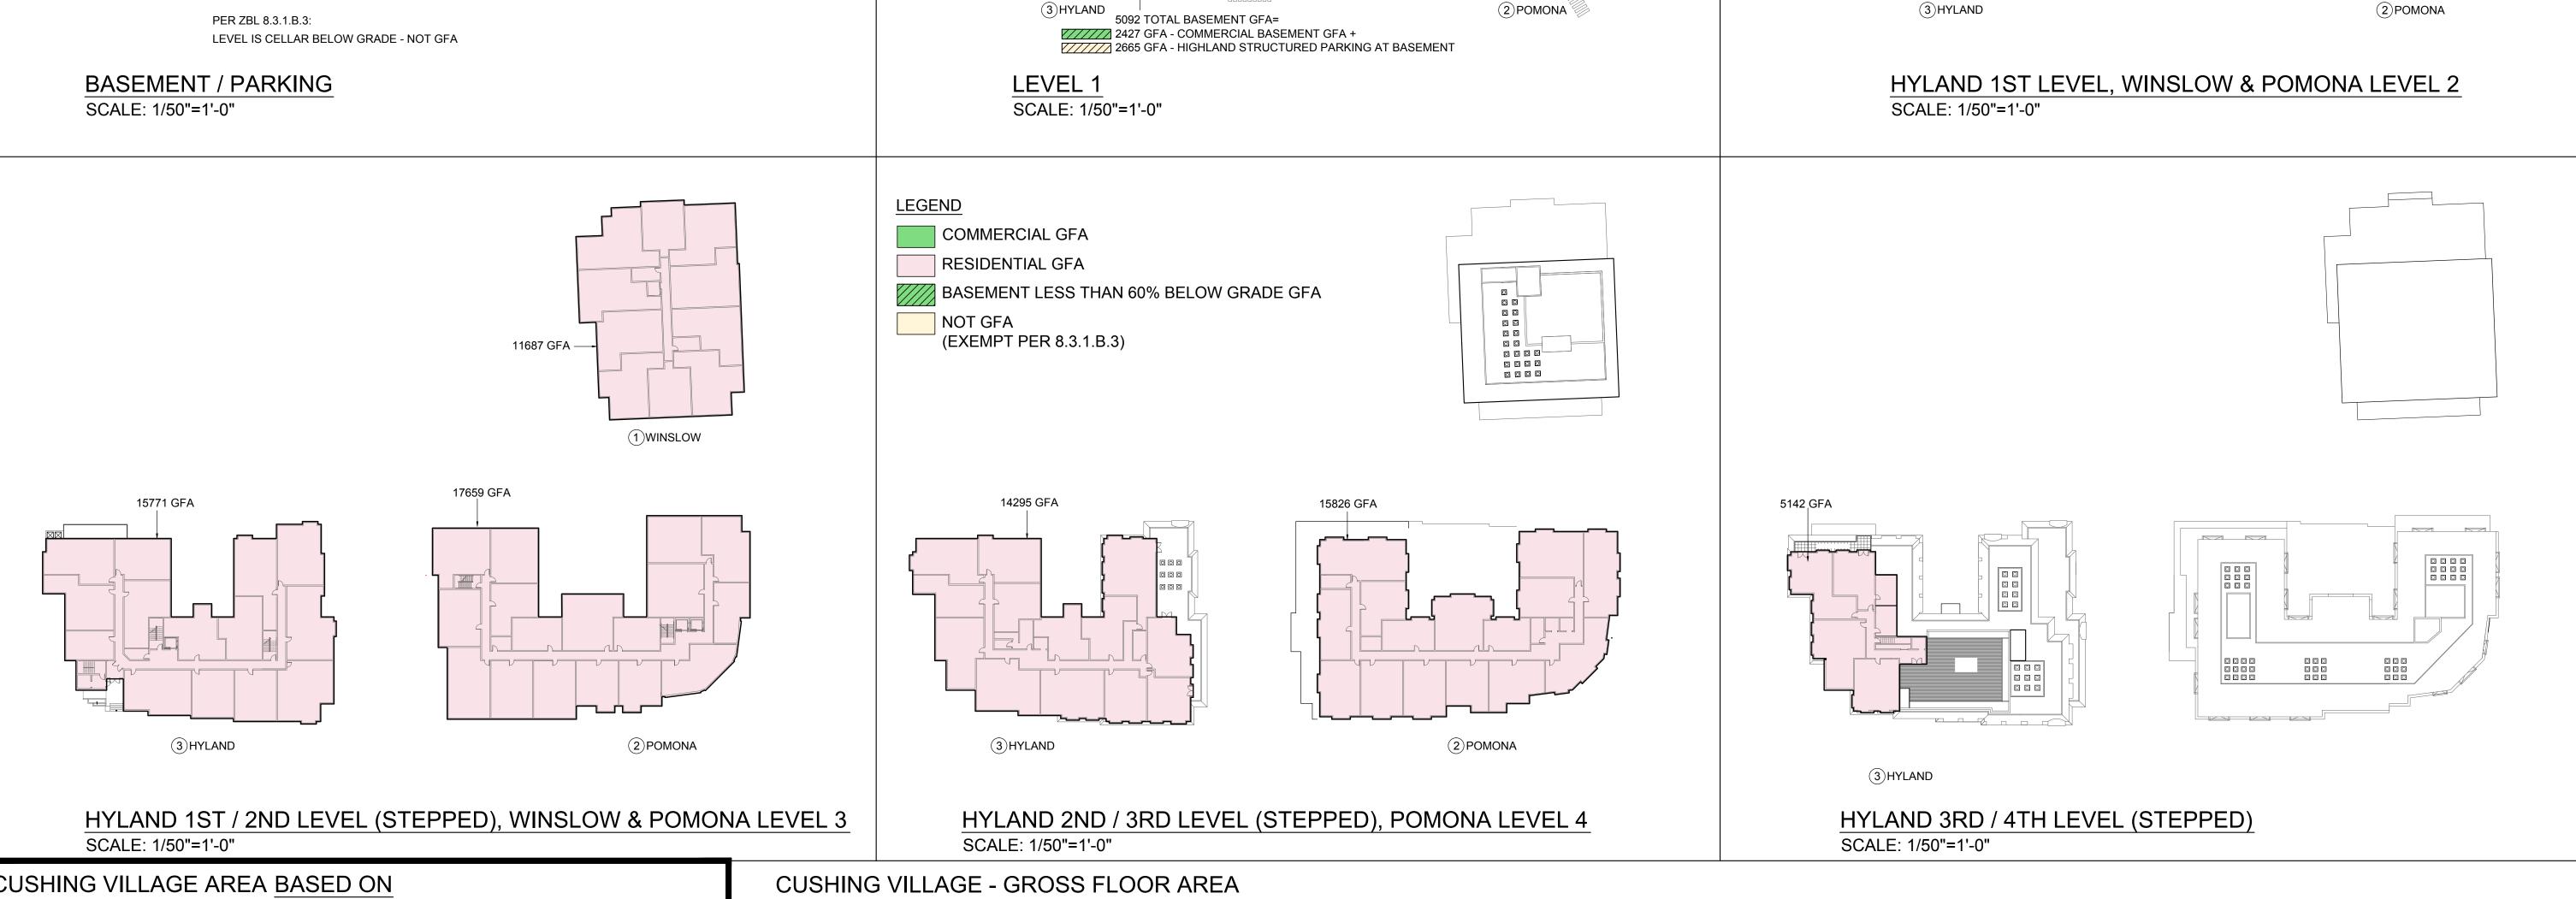

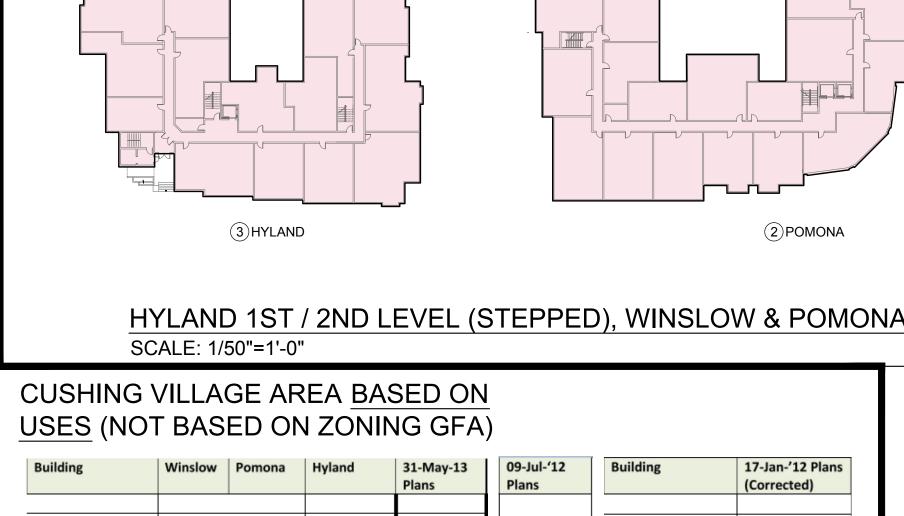

Building	Winslow	Pomona	Hyland	31-May-13 Plans	09-Jul-'12 Plans	Building	17-Jan-'12 Plans (Corrected)
	1	'					
LEVEL 1	11,191	21,529	3,808	36,528	36,099	LEVEL 1	34,743
commercial	10,237	20,026	3,808	34,071	34,280	commercial	33,333
residential	954	1,503	0	2,457	1,819	residential	1,410
LEVEL 2/HYLAND 1	11,850	1 <b>8,82</b> 5	16,300	46,975	45,848	LEVEL 2/HYLAND 1	46,327
Commercial	0	0	4,271	4,271	3,820	commercial	3,642
residential	11,850	18,825	12,029	42,704	42,028	residential	42,685
LEVEL 3/HYLAND 2	11,687	17,659	15,771	45,117	44,964	LEVEL 3/HYLAND 2	45,666
LEVEL 4/HYLAND 3	0	15,826	14,295	30,121	34,823	LEVEL 4/HYLAND 3	42,332
HYLAND LEVEL 3/4	0	0	5,142	5,142	8,352	HYLAND LEVEL 3/4	9,927
TOTAL SF	34,728	73,839	55,316	163,883	170,086	HYLAND LEVEL 4	5,030
commercial	10,237	20,026	8,079	38,342			-
residential	24,491	53,813			38,100 131.986	TOTAL SF	184,025
						commercial	36,975
						residential	147,050

## TABULATION (PER ZONING BYLAW)

COMMERCIAL GFA (EXCLU	JDES NON-	GFA)			RESIDENTIAL GFA (EXCLU	DES NON-G	FA)		
	BUILDING-1 WINSLOW	BUILDING-2 POMONA	BUILDING-3 HYLAND	LEVEL TOTALS		BUILDING-1 WINSLOW	BUILDING-2 POMONA	BUILDING-3 HYLAND	LEVEL TOTALS
BASEMENT / PARKING	0	0	0	0	BASEMENT / PARKING	0	0	0	0
LEVEL 1	10,237	20,026	2,427	32,690	LEVEL 1	954	1,503	0	2,457
HYLAND 1ST LEVEL, LEVEL 2	0	0	0	0	HYLAND 1ST LEVEL, LEVEL 2	11,850	18,825	12,029	42,704
HYLAND 1ST / 2ND LEVEL, WINSLOW & POMONA LEVEL 3	0	0	0	0	HYLAND 1ST / 2ND LEVEL, WINSLOW & POMONA LEVEL 3	11,687	17,659	15,771	45,117
HYLAND 2ND / 3RD LEVEL, WINSLOW & POMONA LEVEL 4	0	0	0	0	HYLAND 2ND / 3RD LEVEL, WINSLOW & POMONA LEVEL 4	0	15,826	14,295	30,121
HYLAND 3RD / 4TH LEVEL	0	0	0	0	HYLAND 3RD / 4TH LEVEL	0	0	5,142	5,142
BUILDING TOTALS (COMMERCIAL)	10,237	20,026	2,427	32,690	BUILDING TOTALS (RESIDENTIAL)	24,491	53,813	47,237	125,541

HIGHLAND STRUCTURED PARKIN	G AT BASEME	NT <60% BELC	OW GRADE GF	A	CELLAR >60% BELOW GRADE NOT GFA	
	BUILDING - 1 WINSLOW	BUILDING - 2 POMONA	BUILDING - 3 HYLAND	LEVEL TOTALS		LEVEL TOTALS
ALL LEVELS	0	0	2,665	2,665	ALL LEVELS	77,777

GRAND TOTAL GFA (EXCLUDES NON-GFA)

	BUILDING-1 WINSLOW	BUILDING-2 POMONA	BUILDING-3 HYLAND	LEV TOTA
COMMERCIAL	10,237	20,026	2,427	32,6
RESIDENTIAL	24,491	53,813	47,237	125,5
HIGHLAND STRUCTURED PARKING AT BASEMENT <60% BELOW GRADE GFA	0	0	2,665	2,6
BUILDING TOTALS	34,728	73,839	52,329	160,8

FAR CALCU	LAT	ION		
GFA		LOT AEA		FAR
160,896	/	86,073 (LOT AREA INCLUDING HORNE RD)	=	1.87
160,896	/	79,702 (LOT AREA EXCLUDING HORNE RD)	=	2.02
	•			

**PLANNING** 

PETER QUINN ARCHITECTS LLC 1904 MASS AVE, 2ND FLOOR CAMBRIDGE, MA 02140

PH 617-354-3989 FAX 617-868-0280

**COMMUNITY DESIGN** 

(1)WINSLOW



CONSULTANT



CONSULTANT

**CUSHING VILLAGE CUSHING SQUARE** BELMONT, MA

PREPARED FOR



6 LITTLEFIELD ROAD ACTON, MA 01720

DRAWING TITLE

ZONING COMPLIANCE: FAR

SCALE AS NOTED

REVISION	DATE
SP REVS- 4	11 JULY 2013
SPSR REV 3	31 MAY 2013

SPSR REV 2 05 MAR 2013 REVIEWED BY CY/MY

#### ZONING COMPLIANCE TABLE

For Compliance in the CSOD and underlying Zoning, as applicable	By-Law Allowed / Required	Proposed Conditions	Comment
Lot Area (Min SF)	15,000 for SPSR	86,073	Complies - Includes Horne Rd Lot Area and Municipal Parking Lot
Total Gross Floor Area (SF)		163,931	Complies
FAR (Max Ratio)	3.0 by SP	1.90	Complies w/SP per 8.3.1.1 See Sheet Z-1
Front Setback (Min ft)	0'	0'	Complies
Side Setback (Min ft)	0' and 20ft abutting Res	0' and 20ft abutting Res	Complies
Rear Setback (Min ft)	20ft	20ft	Complies
Building Height (max ft/stories)	48' and 4 STY by SP per 8.4	Building 1 = +/- 36'-0" and 3 STY Building 2 = +/- 48'-0" and 4 STY	All Comply w/SP per 8.4 See Sheet Z-2
		Building 3 = +/- 44'-11" and 3 STY	
No. Of Dwelling Units	NA	+/-115	Complies w/SP
No. Of Parking Spaces	Per Calculation	174	Complies See Parking Compliance
No. of Bicycle Spaces	Per Calculation	Up to 175	Complies See Bicycle Storage Compliance

#### PARKING COMPLIANCE

## THE ESTIMATED PARKING REQUIREMENT BASED ON PROJECTED USES AND PROPOSED REDUCTION

Use	Rate	Unit	Spaces			
Residential	dential 1 per unit 115 uni					
Restaurant (incl Starbucks)	taurant (incl 1 per 4 seats 198 seats					
Commercial (all ground floor)	54					
Total Parking Requ Replacement	ired exclusive of Mu	nicipal	219			
Parking Provided (s	ee Table)	225				
Less required Muni replacement	(175)					
Parking provided e						
D = d + t = D = +	44					
Reduction Request	Reduction as a percent of required					

#### PARKING SPACES PROVIDED

Area	Standard Size (9'-0" X 18'0")	Compact (8'-0" X 16'0" MIN)	HC Spaces Per MABC dim's	Total
On-Grade	10	11		22
Structured – Commercial *	34	18	$\begin{pmatrix} 3 \end{pmatrix}$	54
Structured – Municipal *	34	14	2	50
Structured – Residential	63	32	5	99
Total	141	75 (33% of total)	9**	225

\* The designation of municipal and commercial spaces is subject to a future management agreement between the Applicant and the Town. Therefore, the final ratio of standard vs. compact is only estimated at this point. However, their respective totals are accurate.

\*\* The MAABC requires between 7 and 9 HC accessible parking spaces, depending on distribution.

#### **BICYCLE STORAGE COMPLIANCE**

Bicycle Storage <u>Required</u> For Compliance in the CSOD	Required	Calculation	Required Count
Residential – See Residential Unit	One space per unit {	115 units X 1.0	115
Tabulation		~~~~~	
<b>Commercial</b> – See Commercial Area Tabulation	2 spaces per commercial establishment, assume 7	7 retail X 2	14
Total Bicycle Storage <u>Req'd</u> (Res+Com)			129
Bicycle Storage <u>Provided</u>			Provided Count
Level B - Lot A (Municipal) - all covered			30
Level B - Lot B (Residential) - all covered			24
Level 1 at-grade - 20 covered			22
Additional Residential Available (Rack System above Assigned Residential Parking Space)			Up to 99
Total Bicycle Storage <u>Available</u>			Up to 175 Complies





2 BUILDING 2 (COMMON STREET ELEVATION)
SCALE: 1/16"=1'-0"



1 BULDING 1 (TRAPELO ROAD ELEVATION)
SCALE: 1/16"=1'-0"

## PETER QUINN ARCHI TECTS

ARCHITECTURE
PLANNING
COMMUNITY DESIGN

PETER QUINN ARCHITECTS LLC 1904 MASS AVE, 2ND FLOOR CAMBRIDGE, MA 02140 PH 617-354-3989 FAX 617-868-0280

SFA/



CONSULTANT



CONSULTANT

PROJECT

CUSHING VILLAGE
CUSHING SQUARE
BELMONT, MA

PREPARED FOR



DRAWING TITLE

ZONING
COMPLIANCE:
BUILDING HT &
DIMENSIONAL
TABLE

SCALE AS NOTED

REVISION DATE

 SP REVS- 4
 11 JULY 2013

 SPSR REV 3D
 8 JUL 2013


 SPSR REV 3A
 7 JUN 2013


SPSR REV 3 31 MAY 2013 SPSR REV 2 05 MAR 2013

DRAWN BY REVIEWED BY
YC/MY PQ

SHEET

7-2

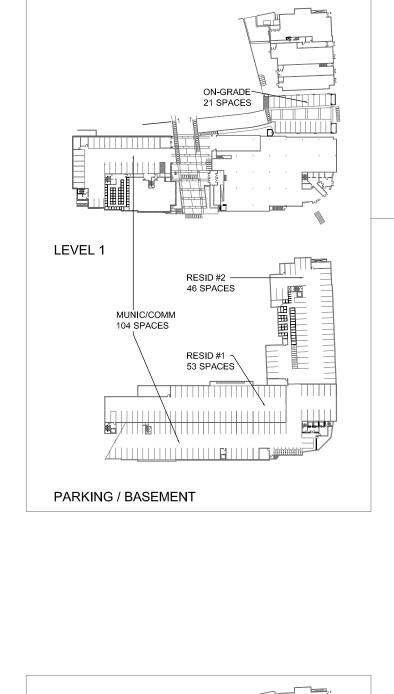

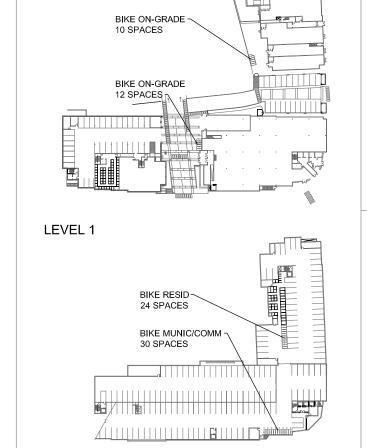

PARKING / BASEMENT

