


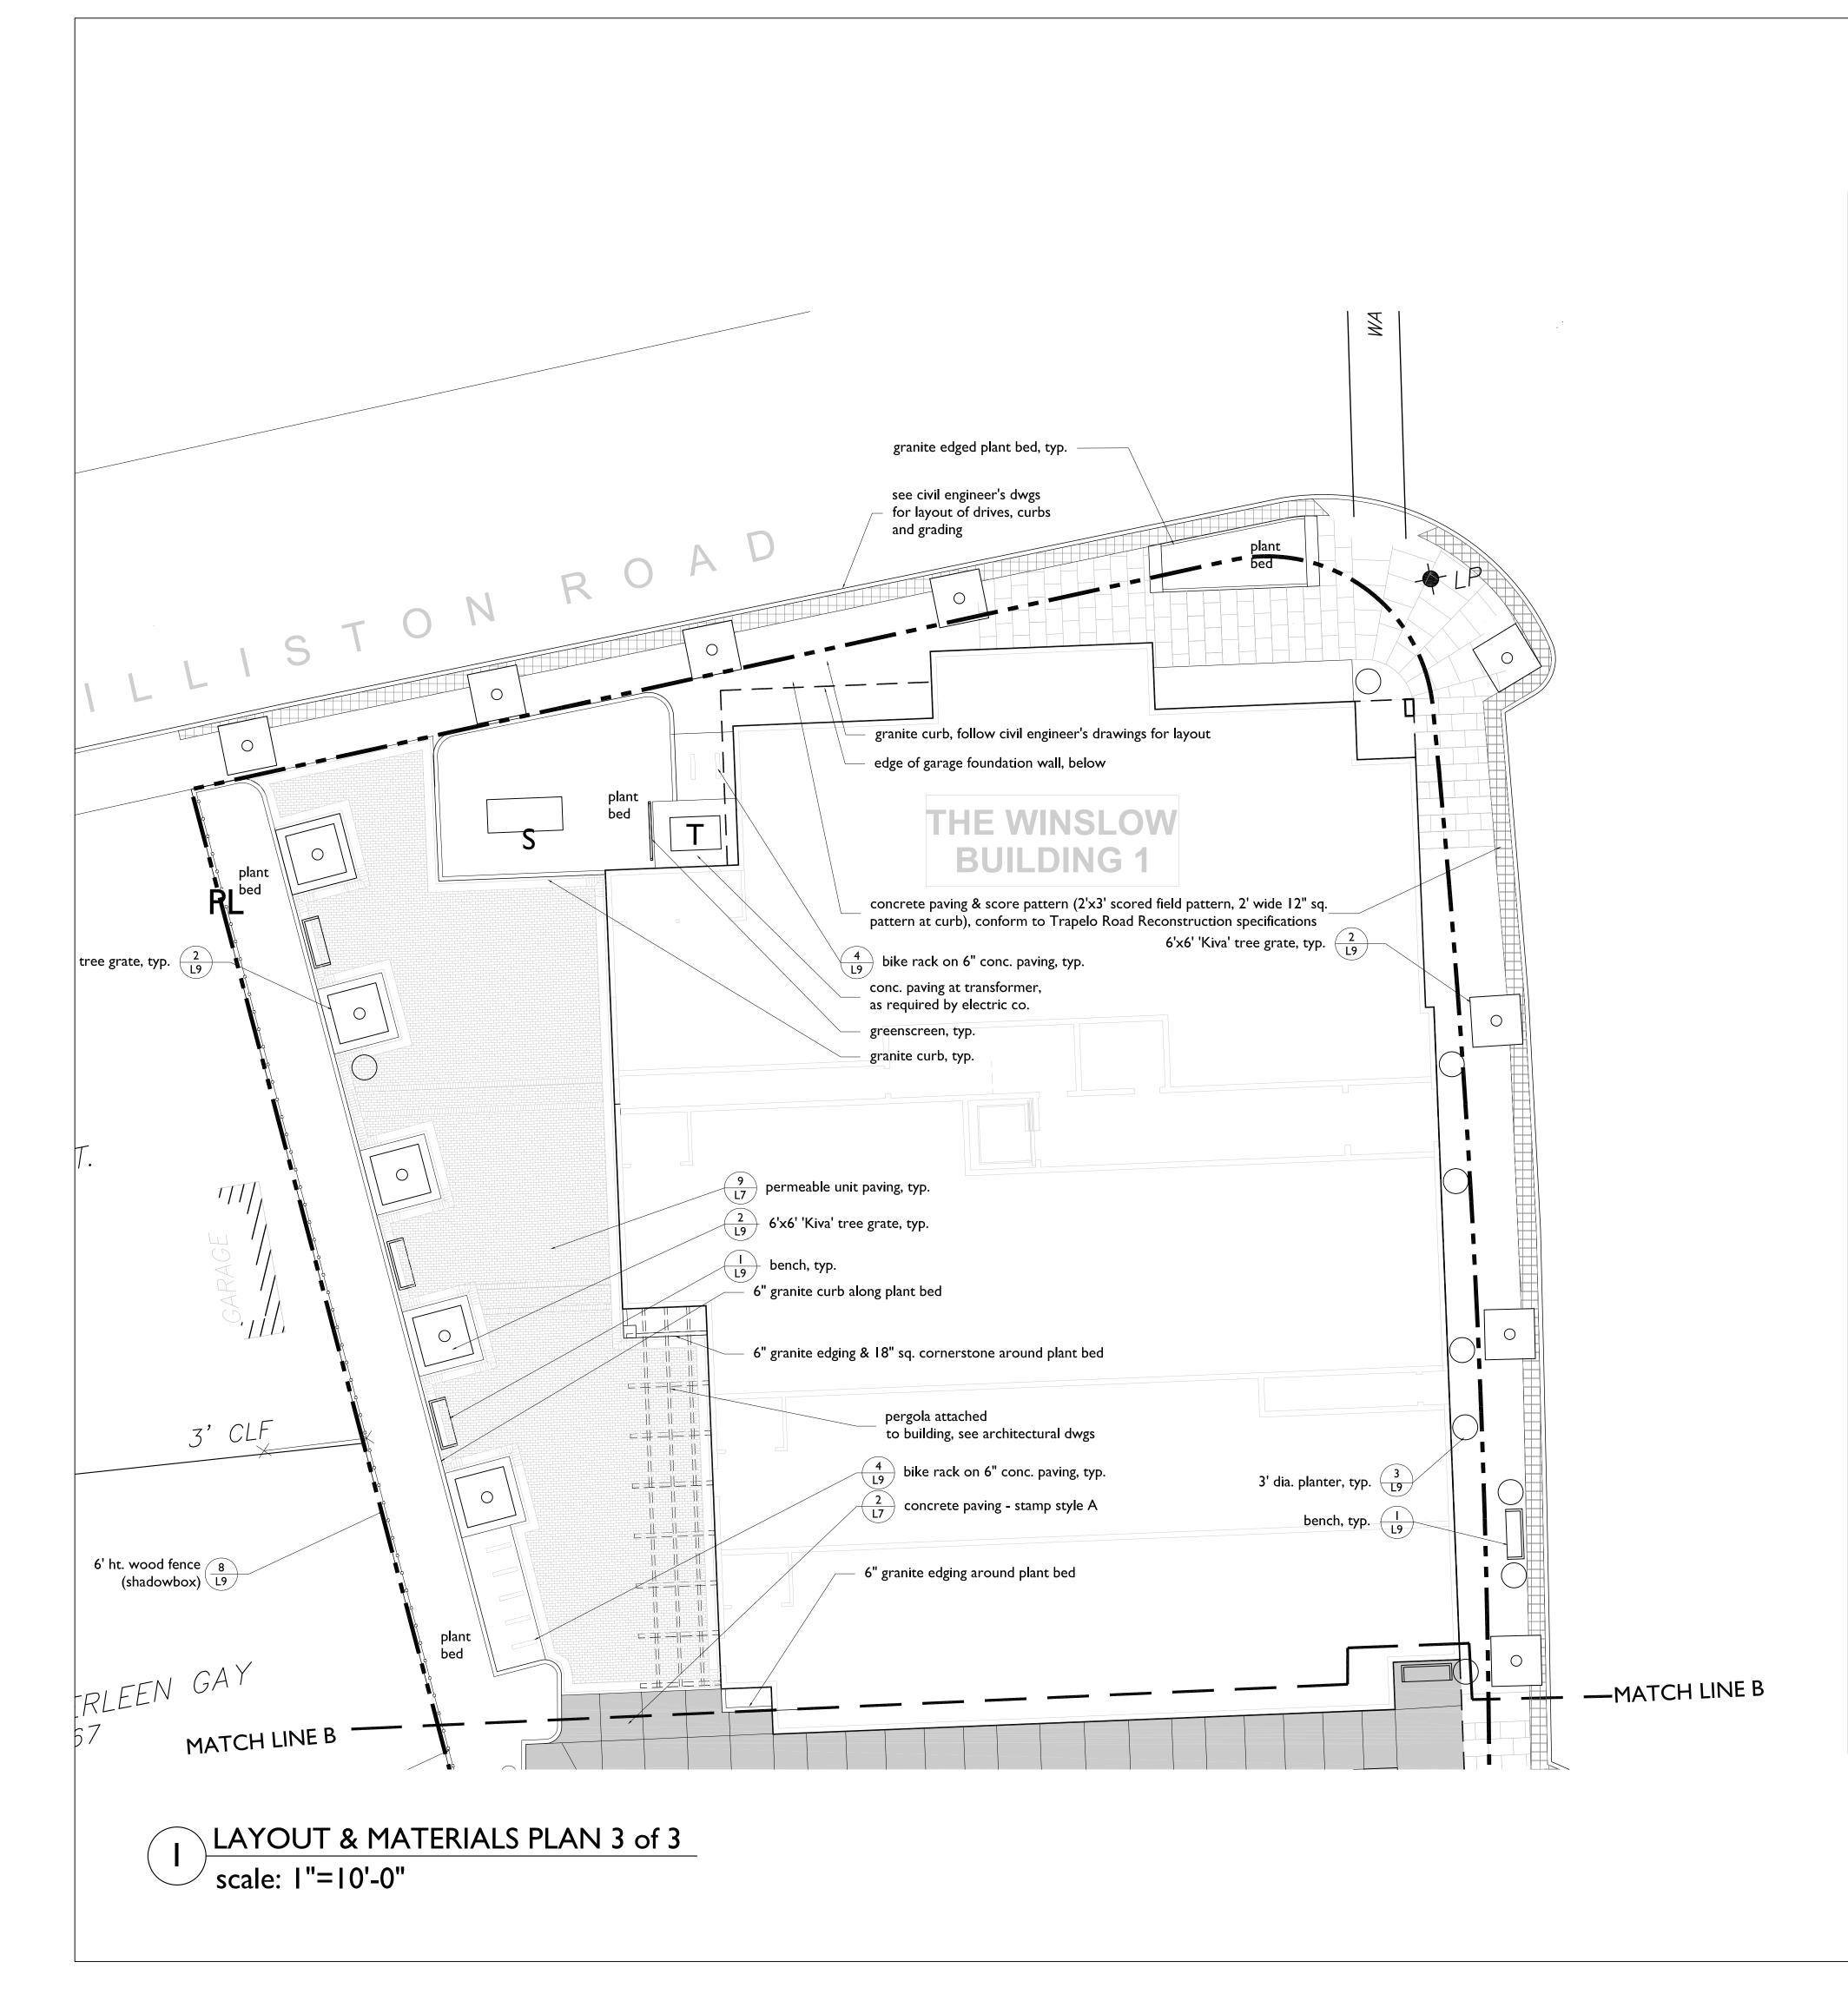

NOTE: Legend, Layout and Material Notes are located on L-3.



LAYOUT AND MATERIALS NOTES

- I. Contractor shall lay out paths, walls and site improvements for review by the Architect prior to proceeding with the work. Make adjustments to layout as directed. Provide proposed grades at all corners and site features as directed.
- 2. All lines are parallel or perpendicular to lines from which they are measured, unless otherwise noted. Dimensions are to face of wall, to face of curb; to edge of pavement; to edge of improvement or as otherwise noted.
- 3. All pedestrian walkways and patios on one level plane: flush condition between all changes in paver/paving styles.

STREETSCAPE NOTES

The proposed design for the streetscape along Tralpelo Road, Williston and Common Streets will follow the design standards for Cushing Square Improvements that are shown on the Mass DOT Trapelo Road reconstruction. This includes:

a. Paving: a 24" colored concrete accent band with 12"x12" score joints and 2'x3' running bond concrete panels perpendicular to the back of sidewalk.

b. Granite highway curbing.

2. Compliant with the Cushing Square Overlay District, the plan shows: 13 benches (1 per 50 l.f. of road frontage). These benches will match the benches that will be provided as part of the Trapelo Road reconstruction. We have been unable to obtain the specified bench from Mass DOT or from the Town of Belmont.

3. 30 Street trees of 3-3. tree species are the species t Mass DOT plans for other are

4. The plan shows six (6) granite edged plant beds within the streetscape, consisting of 6" granite landscape curb abutting 18x18 granite blocks. In addition to tree plantings, these planters include low growing deciduous shrubs and herbaceous plants that will allow for snow storage.

The plan includes twelve (12) 2'x4' & nine (9) 3' diameter fiberglass reinforced planters for seasonal displays, accenting building entrances and passages.

In addition the the current lighting standards, the buildings will have scones and downlights to provide safe and welcoming passage along the public streets.

INTERIOR LANDSCAPE AVAILABLE TO THE PUBLIC NOTES

Pedestrian Pavements:

Pedestrian walks will consist of a colored textured concrete in a running bond brick pattern. This pavement extends from Trapelo Road along the arcades of the Winslow and Pomona buildings to connect with the oneway drive to Horne Road Plaza. It extends along both sides of the Horne Road plaza distinguising pedestrian passage from vehicular pavements. The pedestrian crossings across the vehicular drive will be marked and be fully ADA compliant.

2. The Winslow Plaza will be paved with a running bond brick with banding.

Vehicular Pavements:

Vehicular pavement within the Horne Road Plaza and within the parking spaces between the Winslow and Pomona buildings will consist of patterns of colored textured concrete framed with colored concrete.

4. The vehicular pavement in the one way drive to the Horne Road Plaza will be concrete.

5" caliper.	The street
hat are sho	own on the
eas of Cus	hing Square.

Site Amentities

I. Three (3) benches will be located within the Winslow Plaza. In addition, a concrete seatwall below a pergola structure will be located at the entrance to the Horne Road Plaza.

Fiberglass reinforced planters will be located at the entrances to commercial spaces throughout the pedestrian zones of the interior of the site.

In addition to building lighting, sixteen (16) bollard lights are proposed to mark the edges of the pedestrian zones and to provide additional lighting.

There are thirteen (13) bicycle racks for twenty-six (26) bikes provided in three areas: Horne Road Plaza, and two at Winslow Plaza. As requested by the Town of Belmont additional bicycle racks can be located in the street as directed by the Town of Belmont DPW.

IRRIGATION NOTES


- Contractor shall provide a complete irrigation 1. system for the rooftop garden including all planters as described in specifications.
- 2. Contractor shall provide a separate price for irrigation of street tree pits and planter at front entry.


LEGEND


bit./ bit. conc. bldg. **c.i**.p. CL CP conc. eq. ex. ht. jts. max. min. 0.C. PC PL P.O.B. R typ. +_ 3 L9 9 **L8**/ F Ť D


bituminous concrete building cast in place centerline centerpoint concrete equal existing height joints maximum minimum on center point of curvature property line point of beginning radius typical more or less linear dimension detail number sheet number


detail number sheet number hose bib wall-mounted light path light area drain

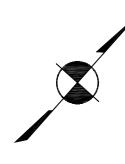

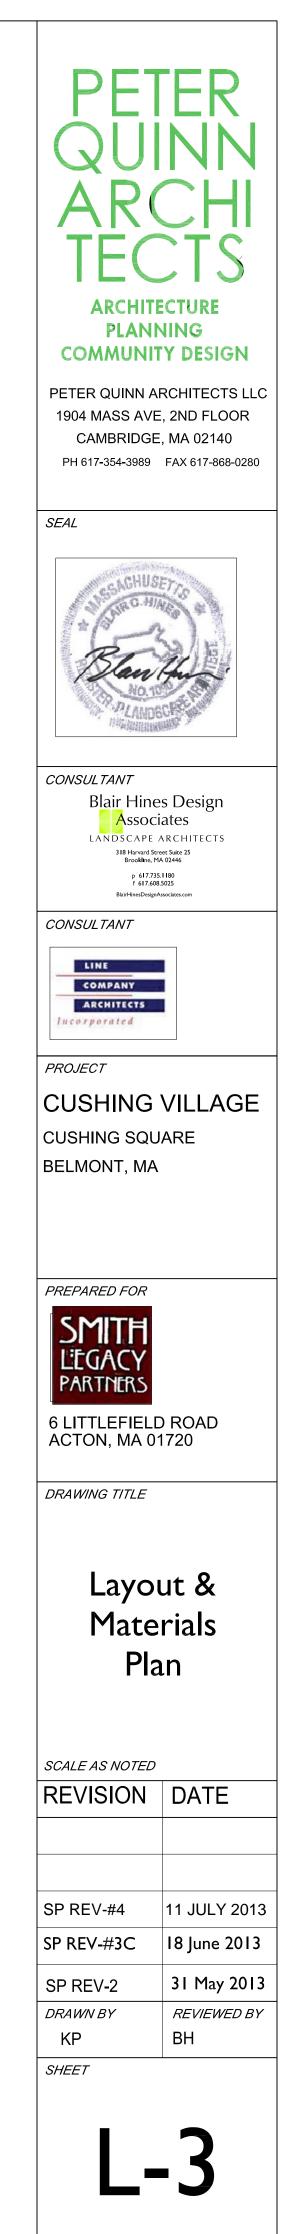


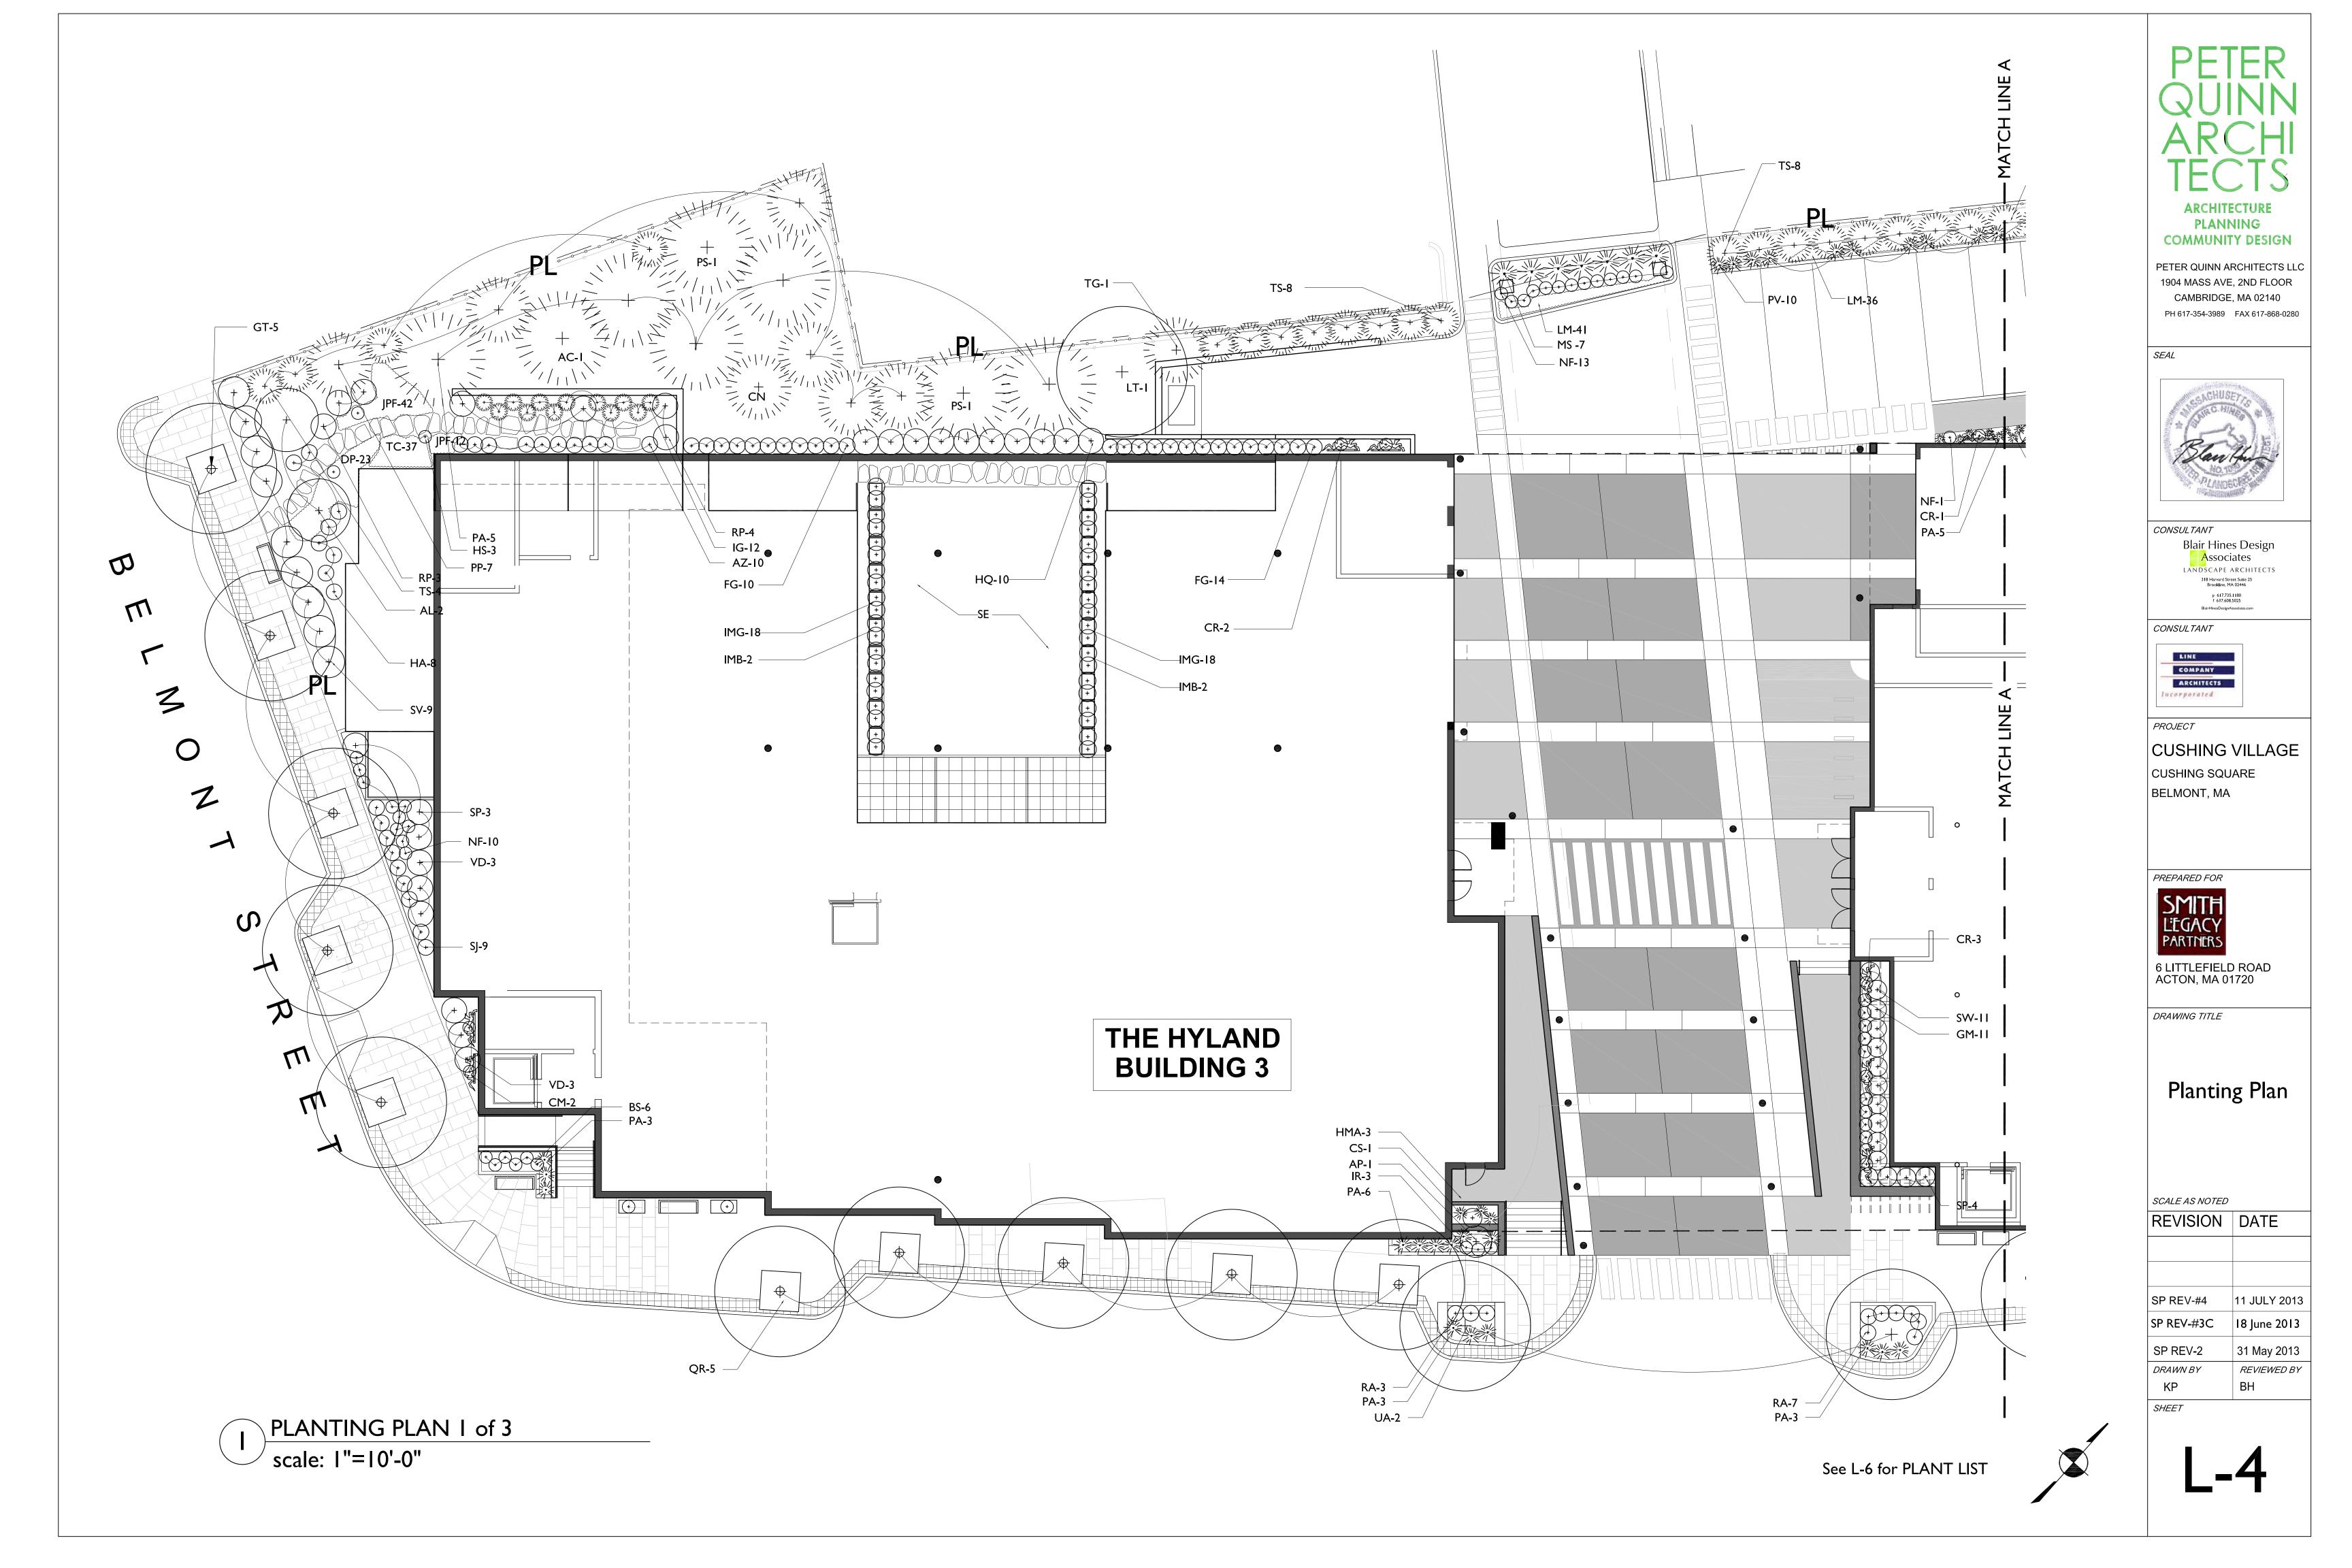

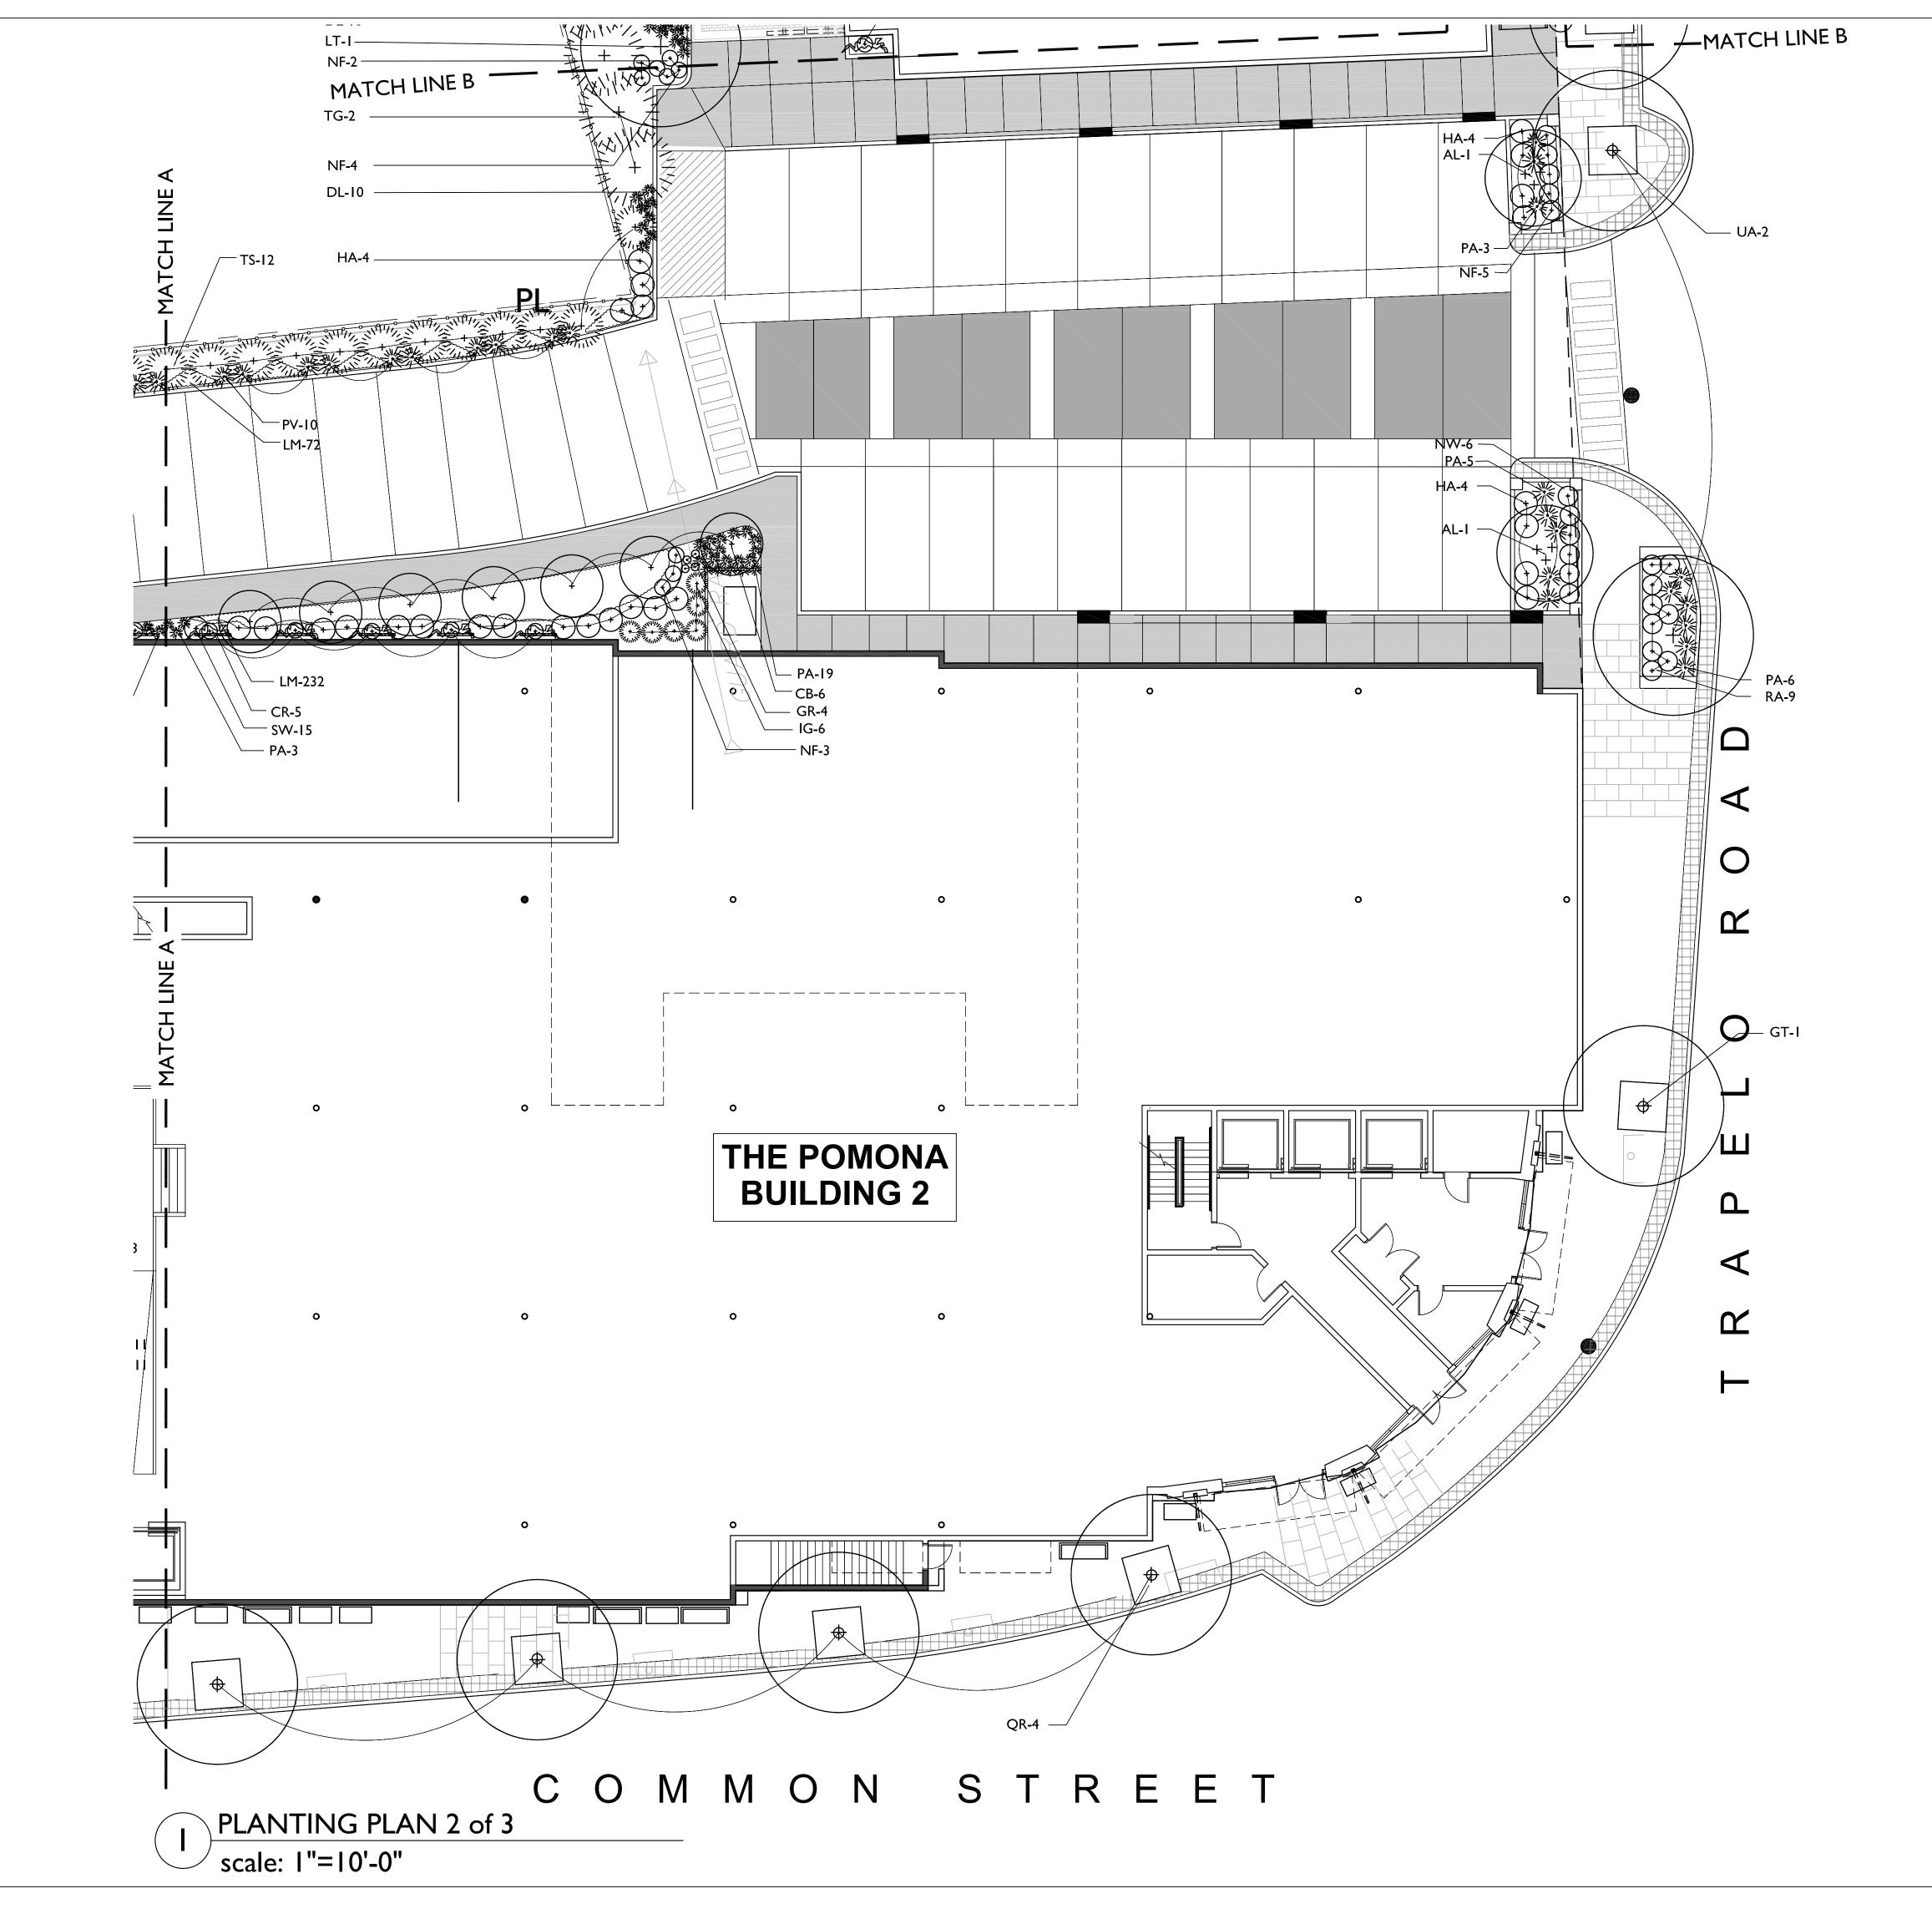

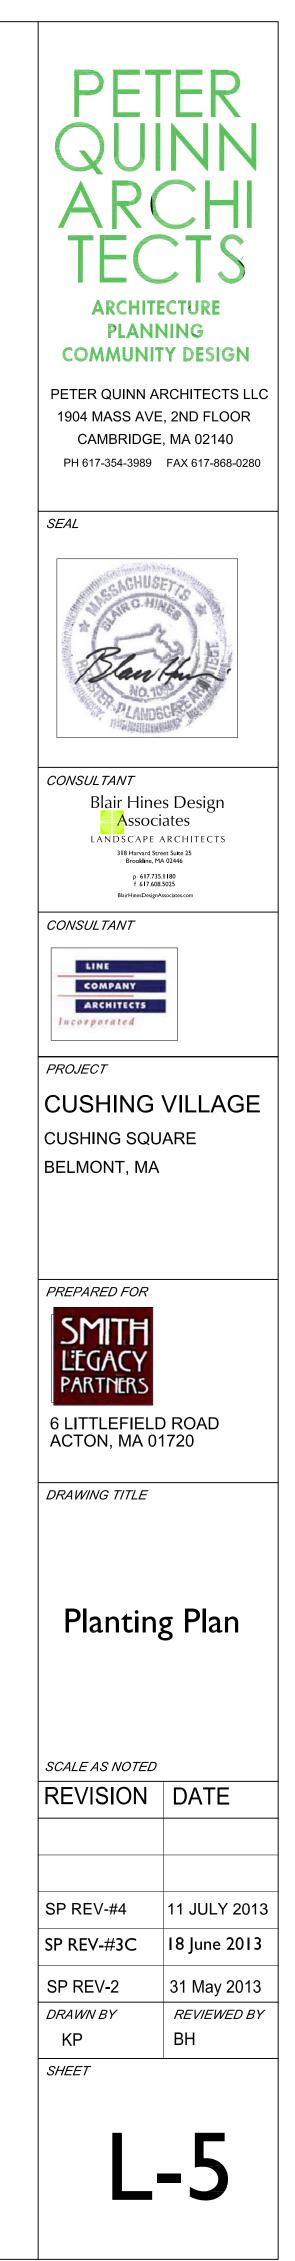

See L-6 for PLANT LIST

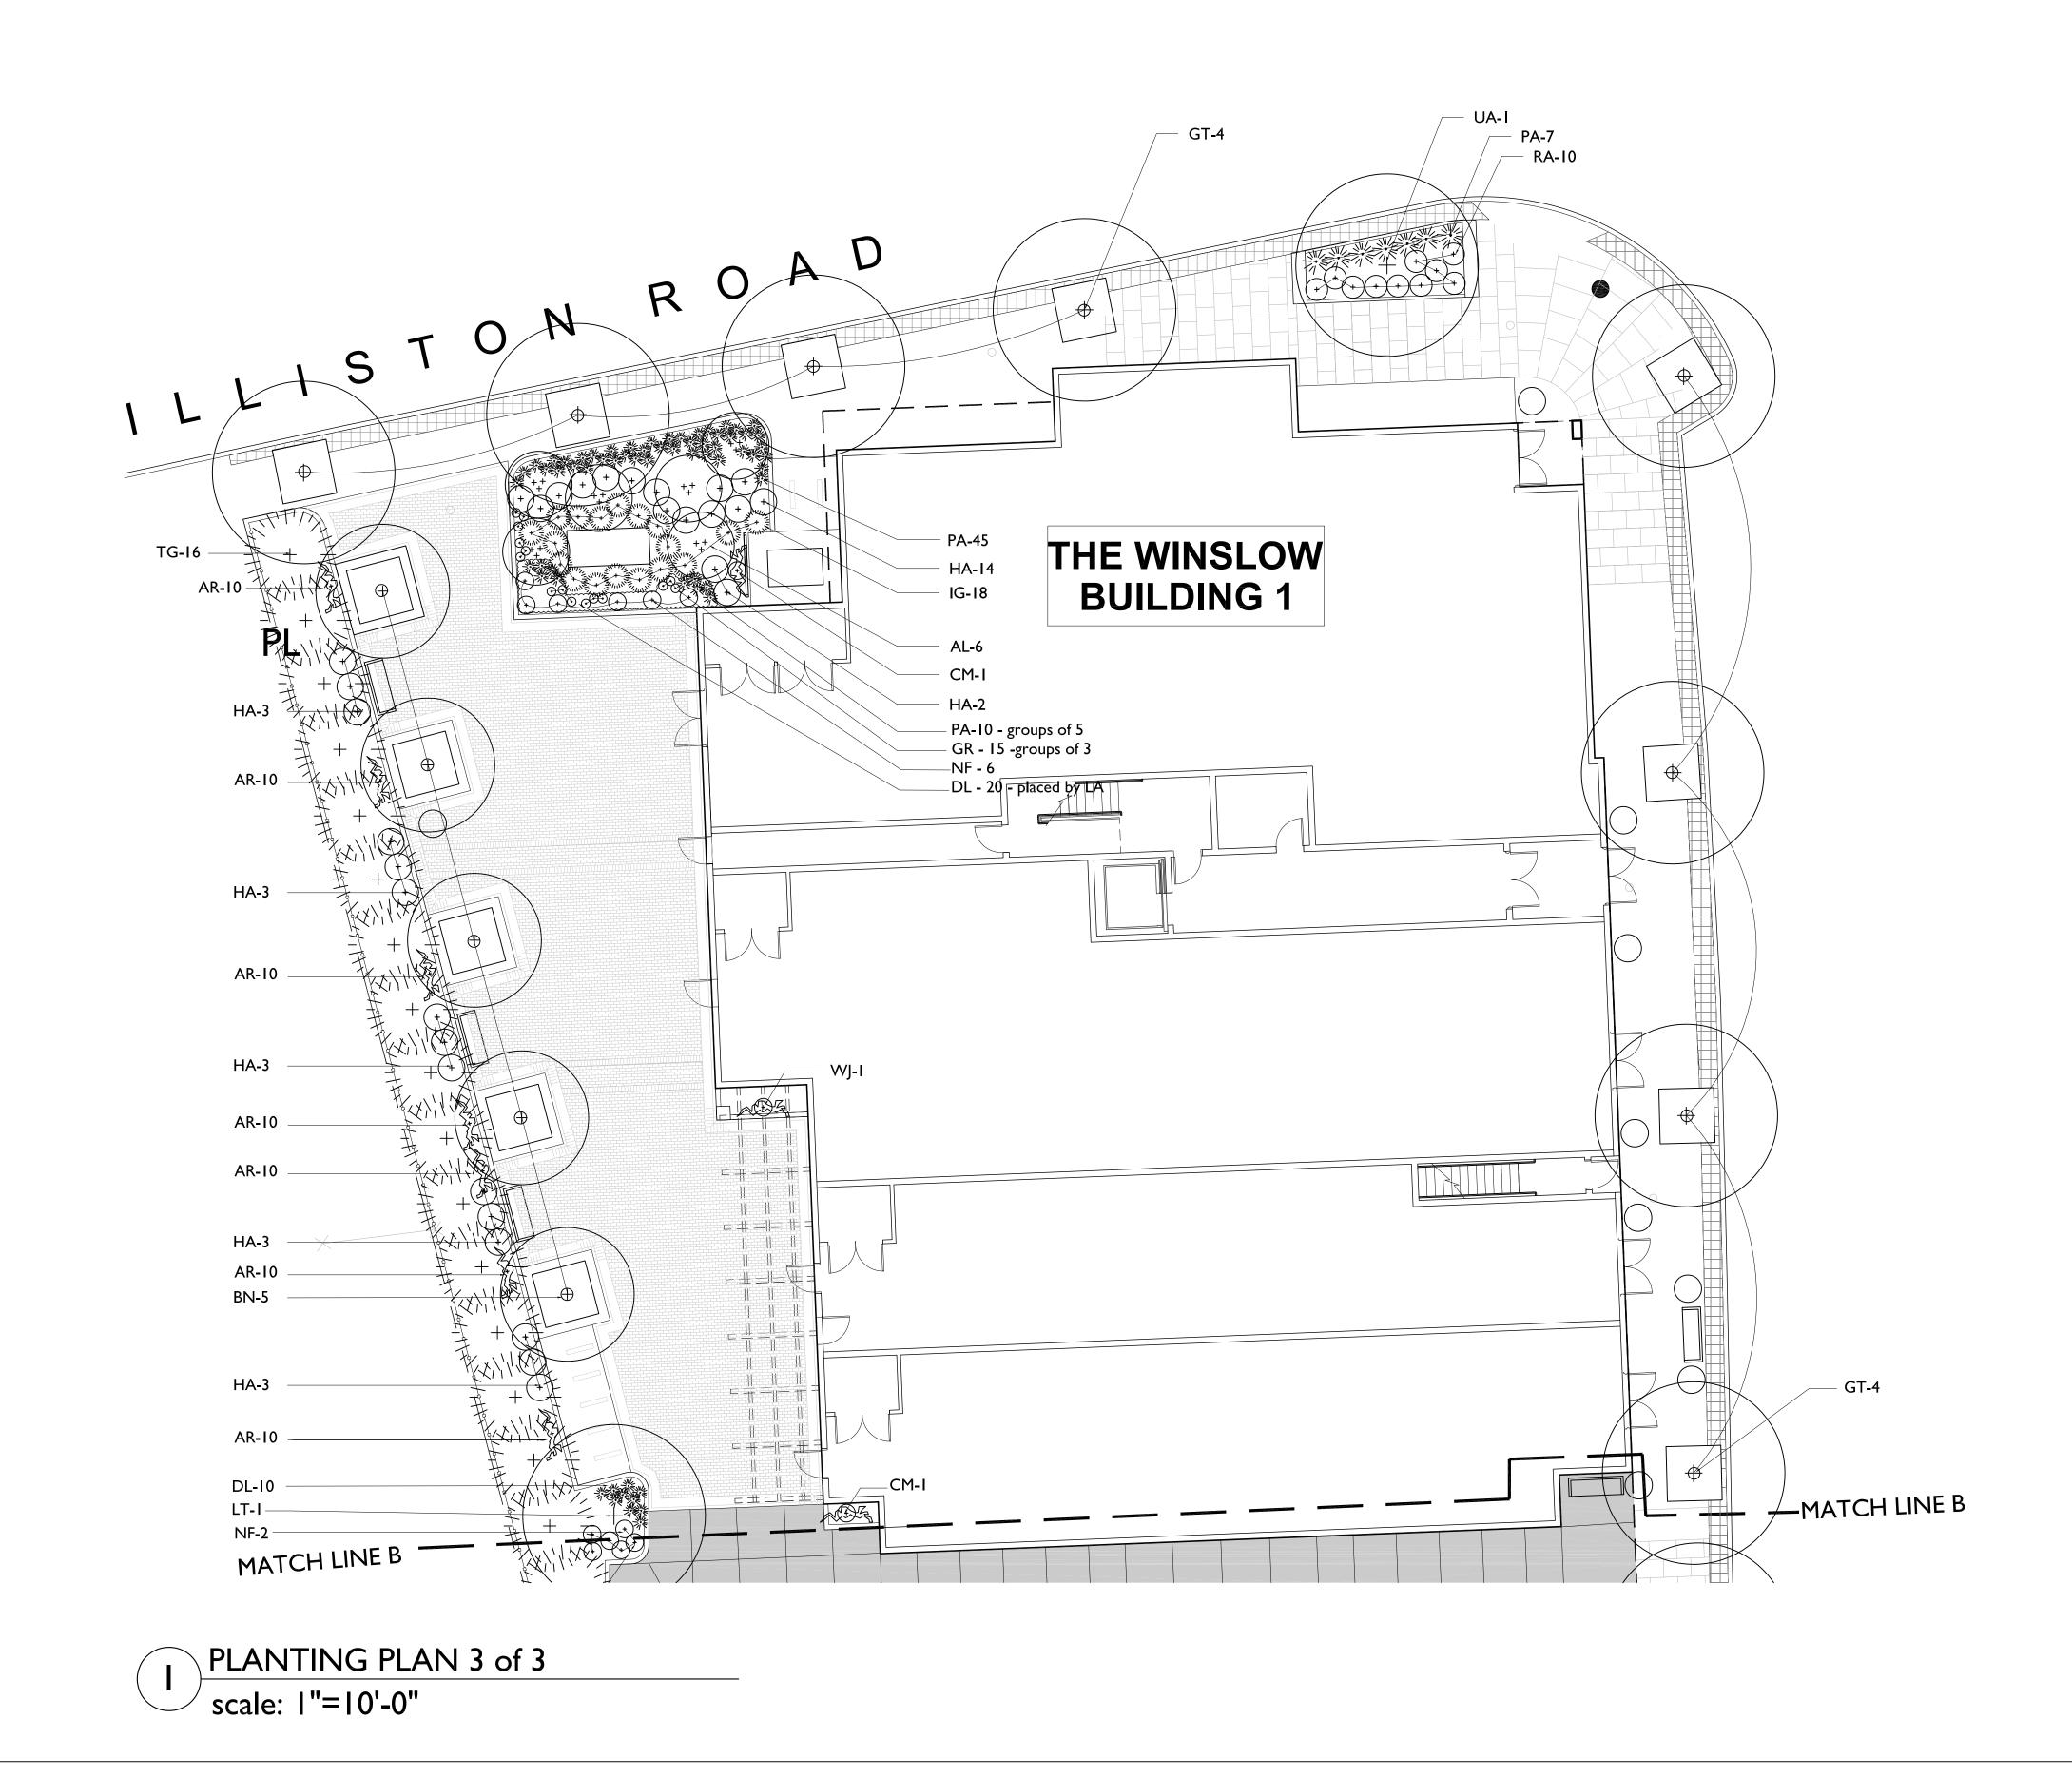



PLANT LIST Key Qty. Bo Trees - I BN 5 CB 6 GT I LT I QR 9 SR UA 5 Trees - I AC I CL CN PA 5 PP PS 2 TG I TG I TS 32 Ornamer AL I AP I Shrubs AK I BS 6 CA CS I CP FG HA 5 HQ I IG 2 IMB 4 IMG 3 IR 3 PM RA RP 7 SJ 9 SP 7 SV 9 SVV 18 VD 6 Vines CM 4 CR I CR ΗP WF Perennia AC AR 70 CF DP EΡ GM GR ΗF HMA 3 ΗP HS JPF LM MS NF PA PΤ PV RG SA SE TC 37 YF


T LIS	т				
	Botanical Name	Common Name	Min. Siz	ze	Notes:
Decid	luous				
5	Betula nigra 'Heritage'	River Birch	4 - 5"	cal.	single stem
5	Carpinus betulus 'Fastigiata'	Hornbeam	l.5-2'		C
4	Gleditsia triacanthos 'Inermis' 'Skyline	e'Thornless Honeylocus	t 4 - 5 "	cal.	
1	Liriodendron tulipifera	Tulip Tree	4 - 5"	cal.	
7	Quercus rubrum	Red Oak	4 - 5"	' cal	
	Syringa reticulata 'Ivory Silk'	Japanese Tree Lilac	2-2.5'	" cal.	
5	Ulmus americana 'Valley Forge'	Am. Elm	4 - 5"	cal.	B&B
Everg	reen				
	Abies concolor	White Fir	6 - 7' h	t.	
	Cupressocyparis leylandii	Leyland Cypress	7 - 8' h	t.	
	Chamaecyparis nootkatensis 'Pendula	a'Alaska Cedar	7 - 8' h	t.	
5	Picea abies	/ 1	7 - 8' h		
7	Picea pungens		6 - 7' h		
2	Pinus strobus		8 -10' h		
9	, I		8 -10' h		
	, ,		7 - 8' h		
32	Thuja occidentalis 'Smaragd'	Arborvitae	7 - 8' h	t. AL	T. Leyland Cypress
	_				
ental ⁻		с · .		ī	• • •
0	Amelanchier leavis	Serviceberry	1.5-2" o		single stem
	Acer palmatum 'Bloodgood"	Red Japanese Maple	l.5-2" o	cal.	
				//2 I.O./	o 411
-	Azalea - Karen	Lavender Evergreen Az		#3 18-: 18" ht.	
5	Buxus sempervirens 'Green Gem'	Boxwood			
1	Clethra alnifolia	Summersweet		2 Gal	
	Cornus sericea	Red-twigged Dogwood		30" ht. ₄o" ∡o	
1 4	Corylus maxima 'Purpurea'	Hazelnut		48"-60' 24"-20'	
24	Fothergilla gardenii	Dwarf Fothergilla		24"-30' 2 Cal	
	Hydrangea arborescens 'Annabelle' Hydrangea quercifolia			2 Gal 3 - 3.5'	
10 28	llex glabra 'Compacta'	Oakleaf Hydrangea Dwarf Inkberry Holly		3 - 3.5 24"-30'	
4	llex meserveae 'Blue Boy'	Blue Boy Holly		24 -30 30-36"	
	llex meserveae 'Blue Girl'	Blue Girl Holly		30-36"	
3	llex verticillata 'Red Sprite'	Winterberry		30-36"	
	Pinus mugo 'Pumilio'	Dwarf Mugo Pine		#5 24-)	
29	Rhus aromatica 'Lo Gro'	Lo Gro Sumac		I Gal	50
- <i>·</i> 7	Rhododendron catawbiense 'Boursau			30-36"	
9		Little Princess Spirea		15"-18'	
	Syringa p. 'Miss Kim'	Miss Kim Lilac		24"-30	
9	Syringa vulgaris	Common Lilac		4-5' ht.	
8	Spiraea bumalda 'Anthony Waterer'				" 2 Gal
6	Viburnum dentatum 'Blue Muffin'	Compact Viburnum		36" ht.	
		•			
4	Clematis maximowicziana	Autumn Clematis		2 Gal.	
	Clematis 'Montana Rubens'	Clematis	•	2 Gal.	
	Campsis radicans	Trumpetcreeper Vine		2 Gal.	
	Hydrangea paniculata	Climbing Hydrangea		2 Gal.	
	Wisteria floribunda	Japanese Wisteria		2 Gal.	
als, G	roundcovers, Ferns				
	Astilbe 'Amethyst'	Plume Flower			
70		Ajuga			
	Echinacea purpurea 'Kims Knee High		#2 pot	S	
23	Dennstaedtia punctilobula	Hay-scented Fern			
	Echinacea purpurea 'Magnus'	Coneflower			
	Geranium macrorrhizum 'Bevan's Van	-			
9	Geranium x 'Rozanne'	Blue Geranium			
	Hemerocallis 'Happy Returns'		#2 pots		
3	Hakonechloa macra 'Aureola'	Japanese Forest Grass	l gal po		
	Heuchera 'Palace Purple'	Red Coralbell	l gal po	ots	15" o.c.
5 - ₄	Hosta sieboldiana 'Elegans'	Large Blue Hosta	1 1 - 1	- 4 -	15"
54	Athyrium niponicum 'picatum'	Japanese Painted Fern	l gal po	ots	15" o.c.
301 7	Liriope muscari 'Royal Purple'	Lily Turf Missenthus			
, 50	Miscanthus sinensis 'Morning Light'	Miscanthus)! -	oto	
50 I I 8	Nepeta faassenii 'Walker's Low'	Catmint	2 gal po		
118	Pennisetum alopecuroides 'Hameln'		#2 pots		
20	Pachysandra terminalis - Green Sheel	n Pacnysandra Shenandoah	4" pots		
-0	Panicum virginicas Rudbeckia goldsturm	Black Eyed Susan		ote	
	Sedum 'Autumn Joy'	Sedum	l gal po	1.3	
	Sedum Matumin Joy Sedum mats	Pre-grown 'sod' of varie	etv of S	adume	for greenroof
37	Tiarella cordifolia 'Running Tapestry'	-	l gal po		
	Yucca filamentosa		#2 pots		
			Pou	-	






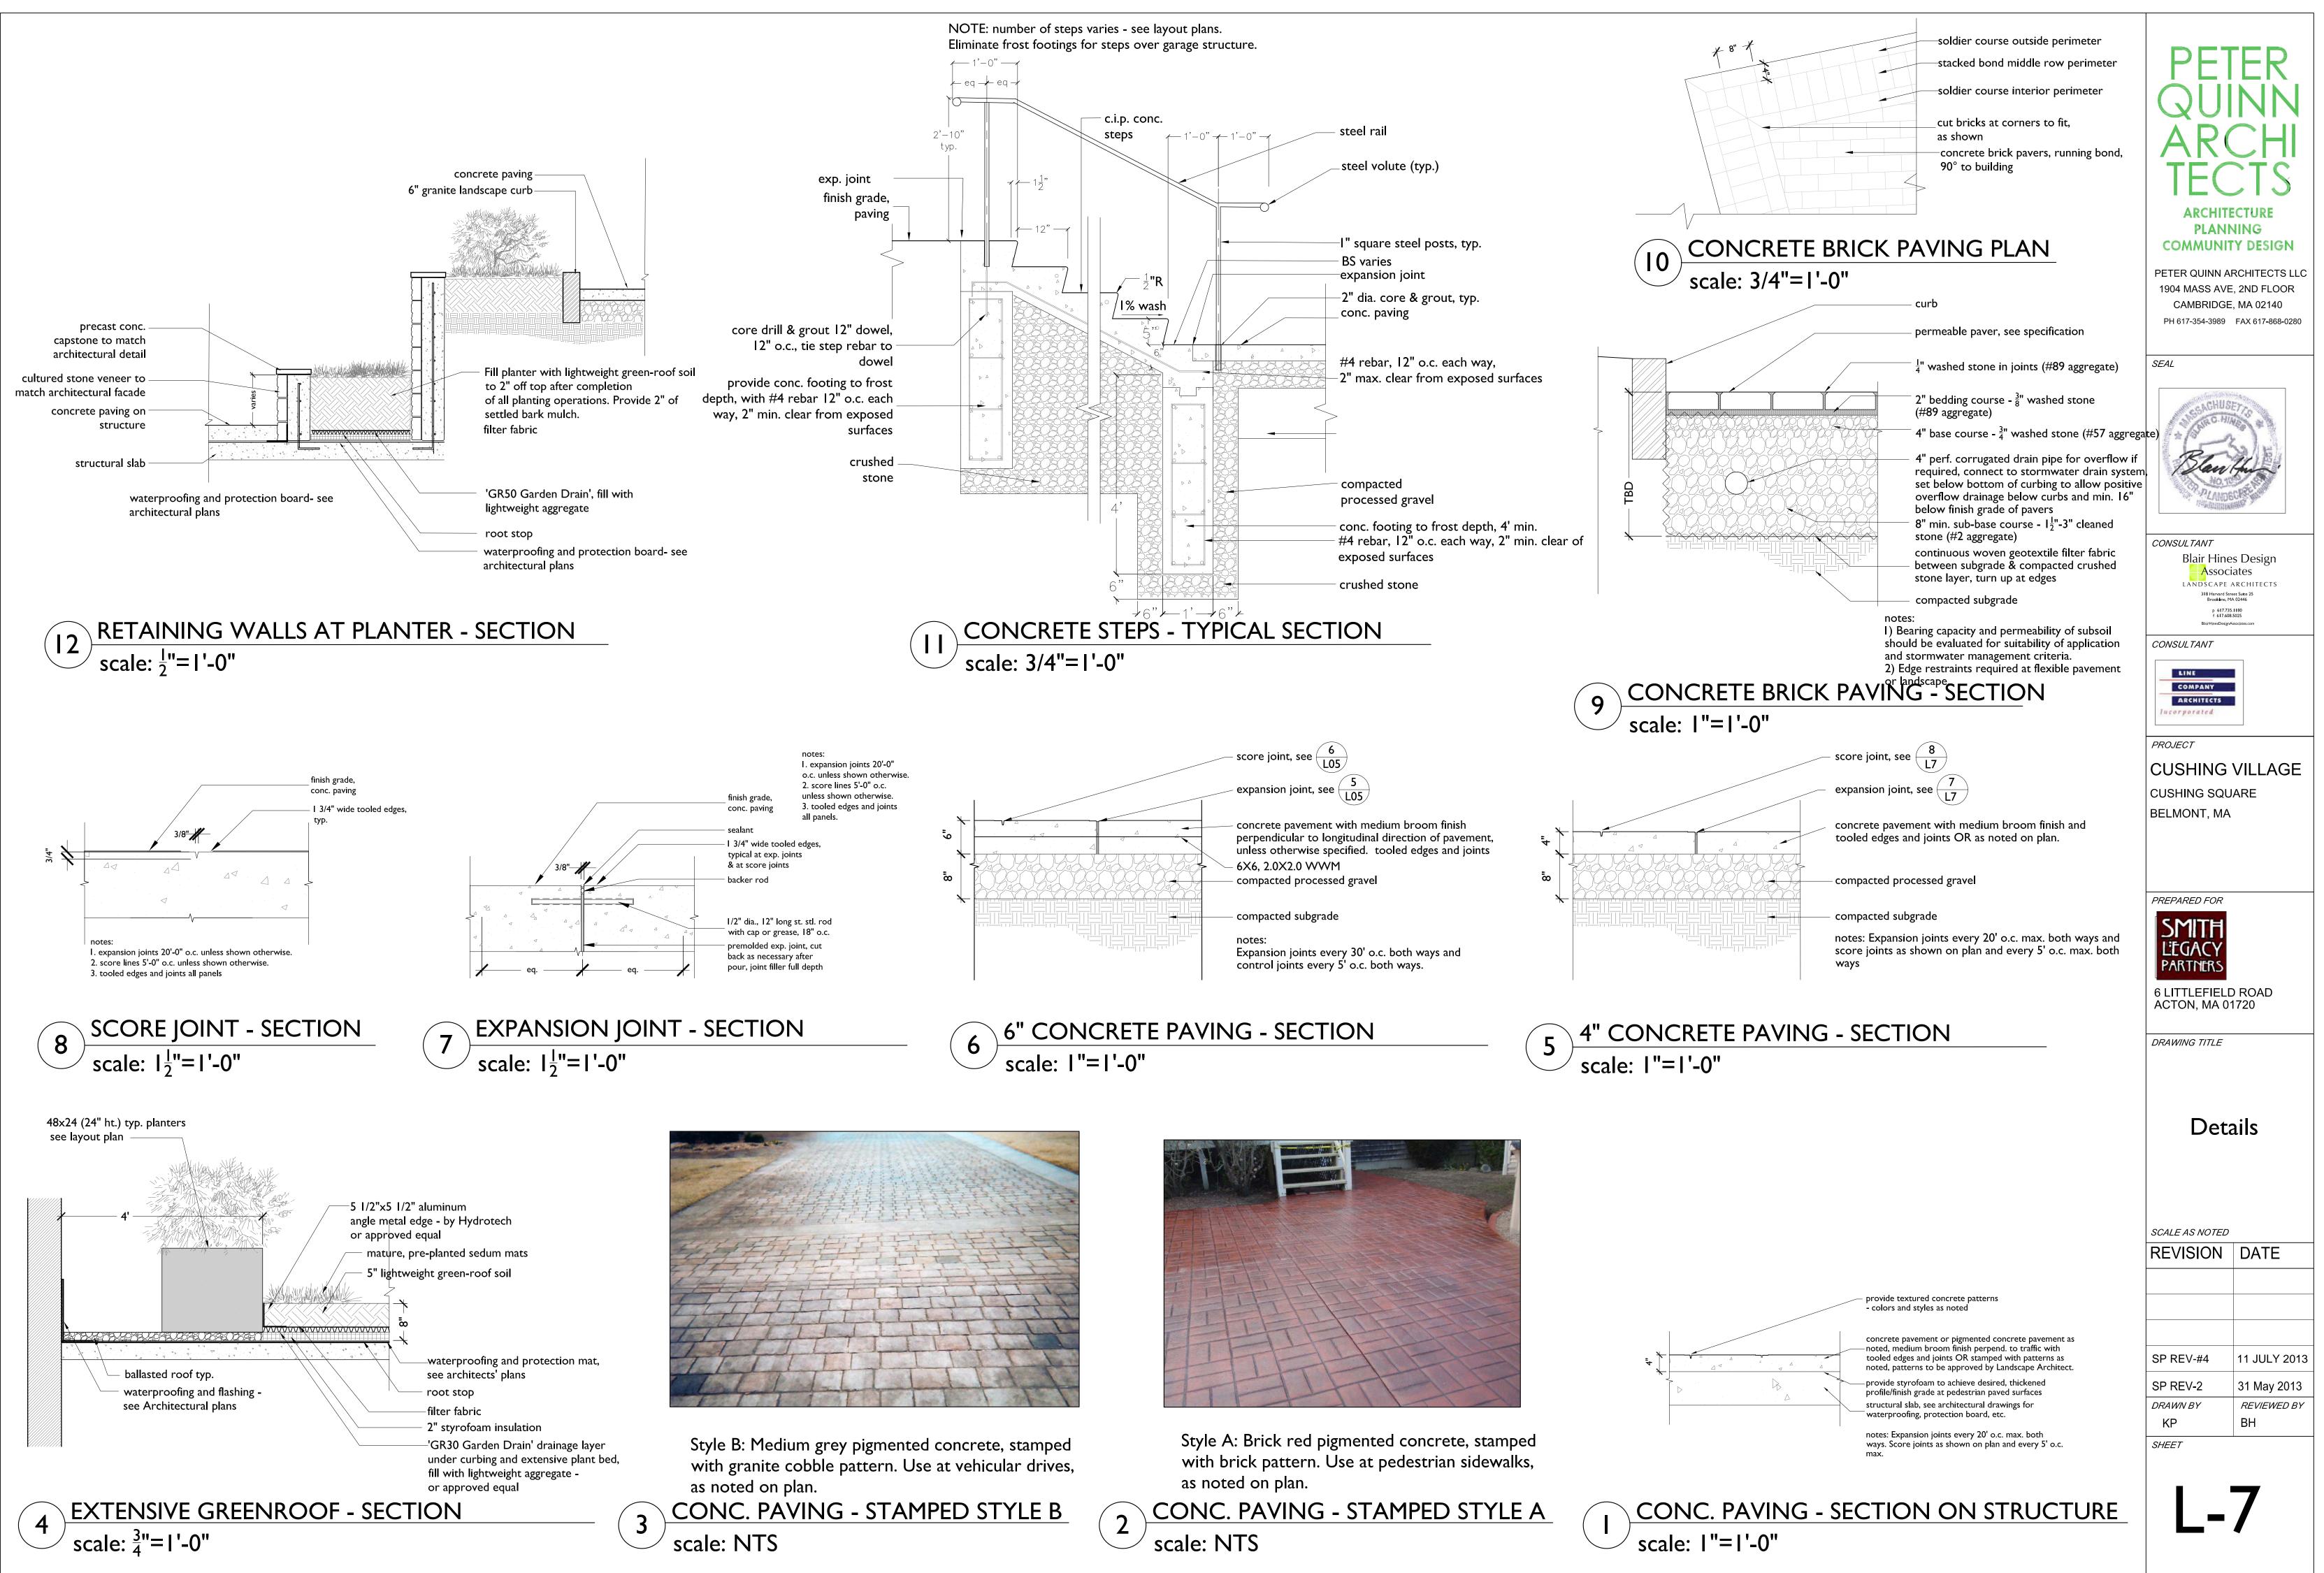


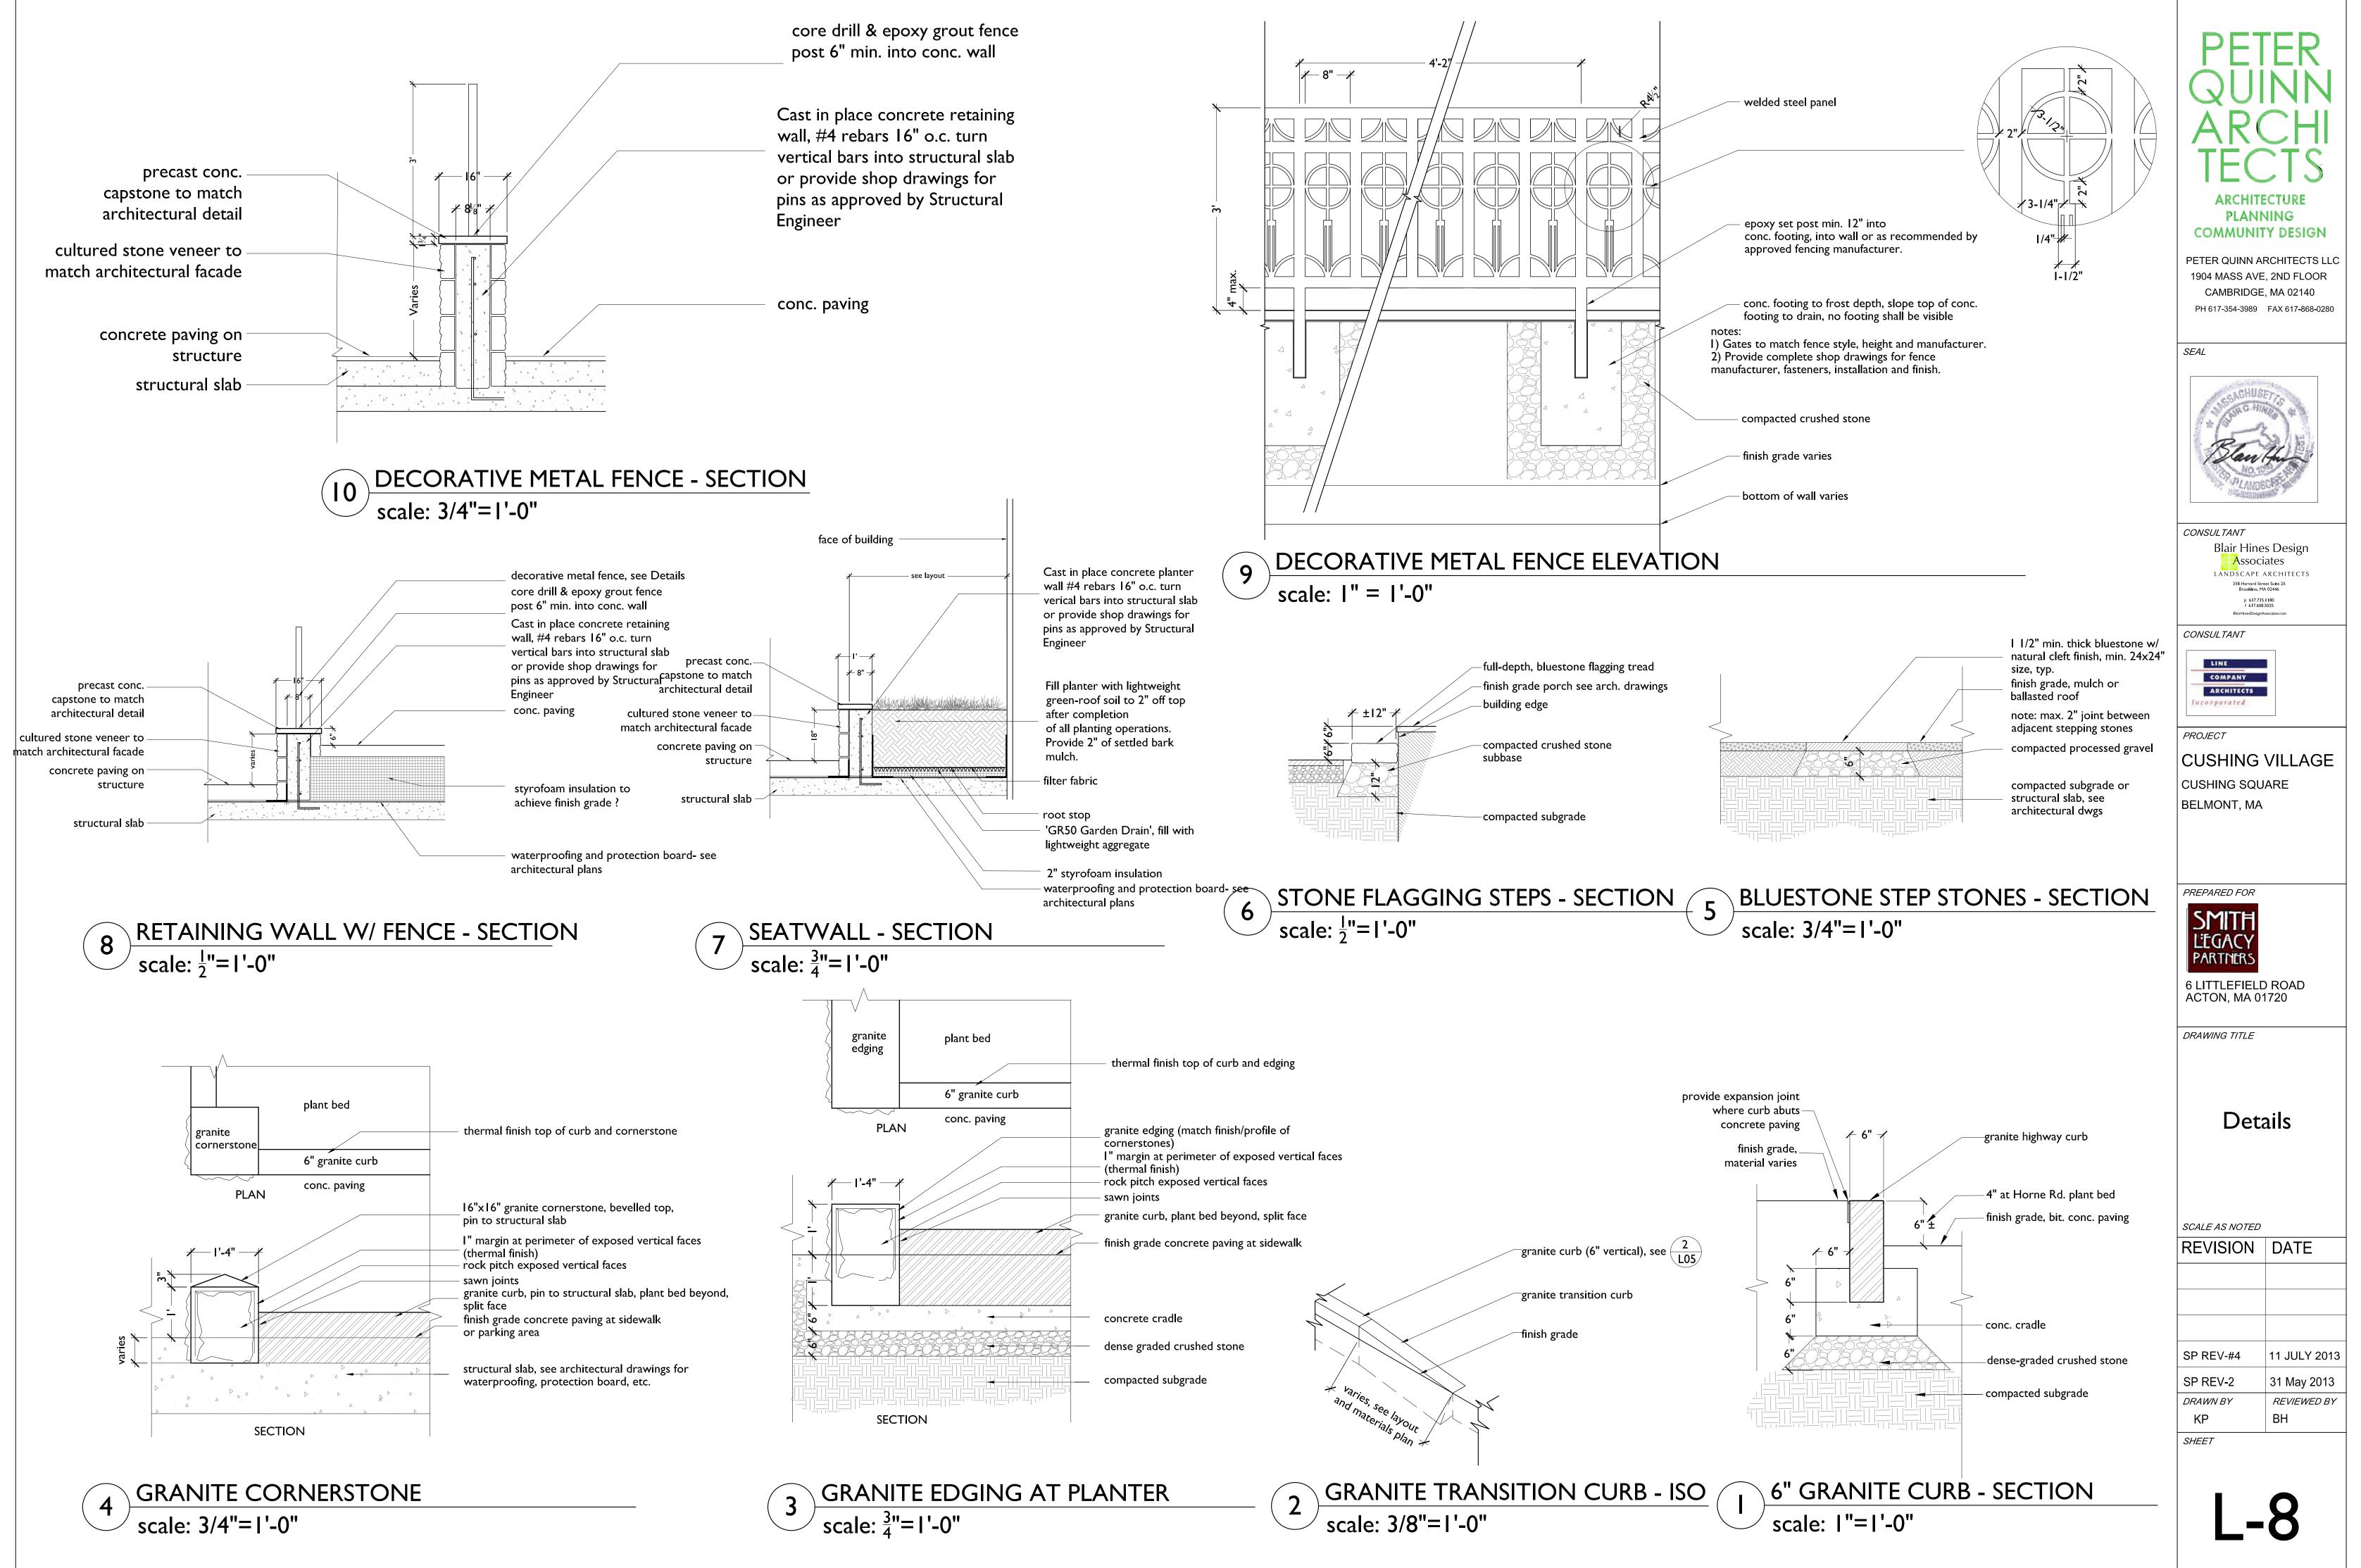

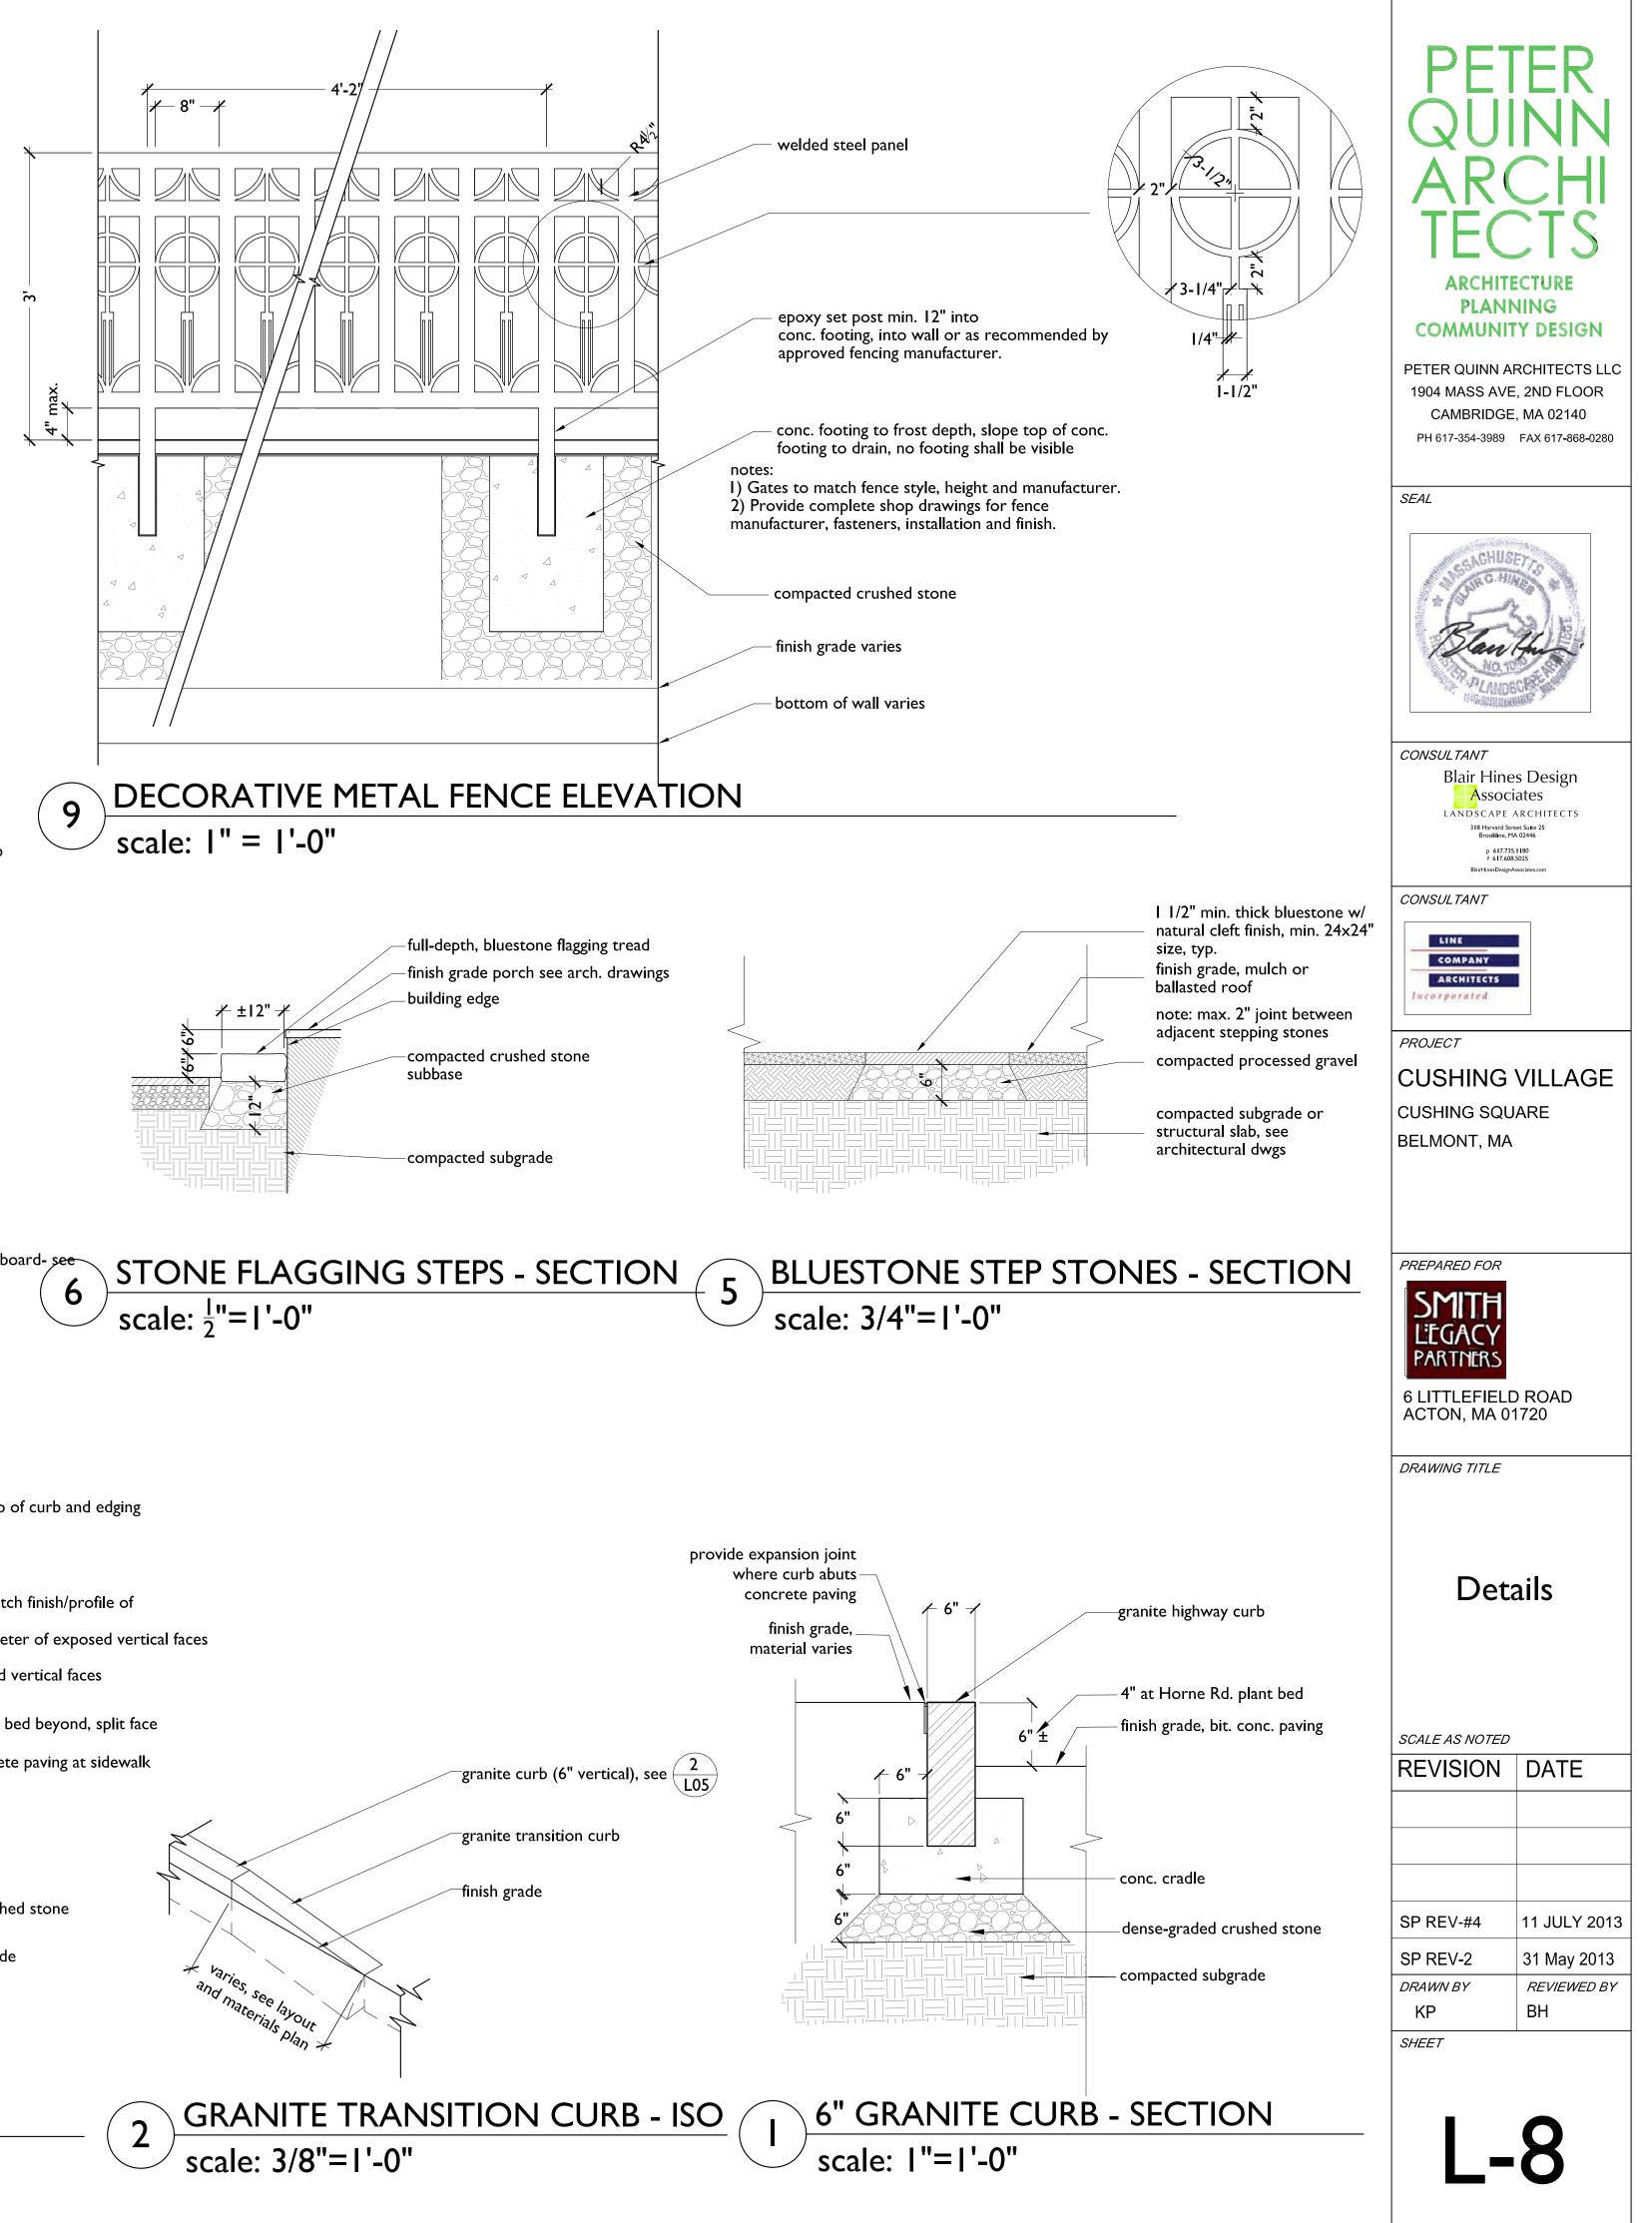


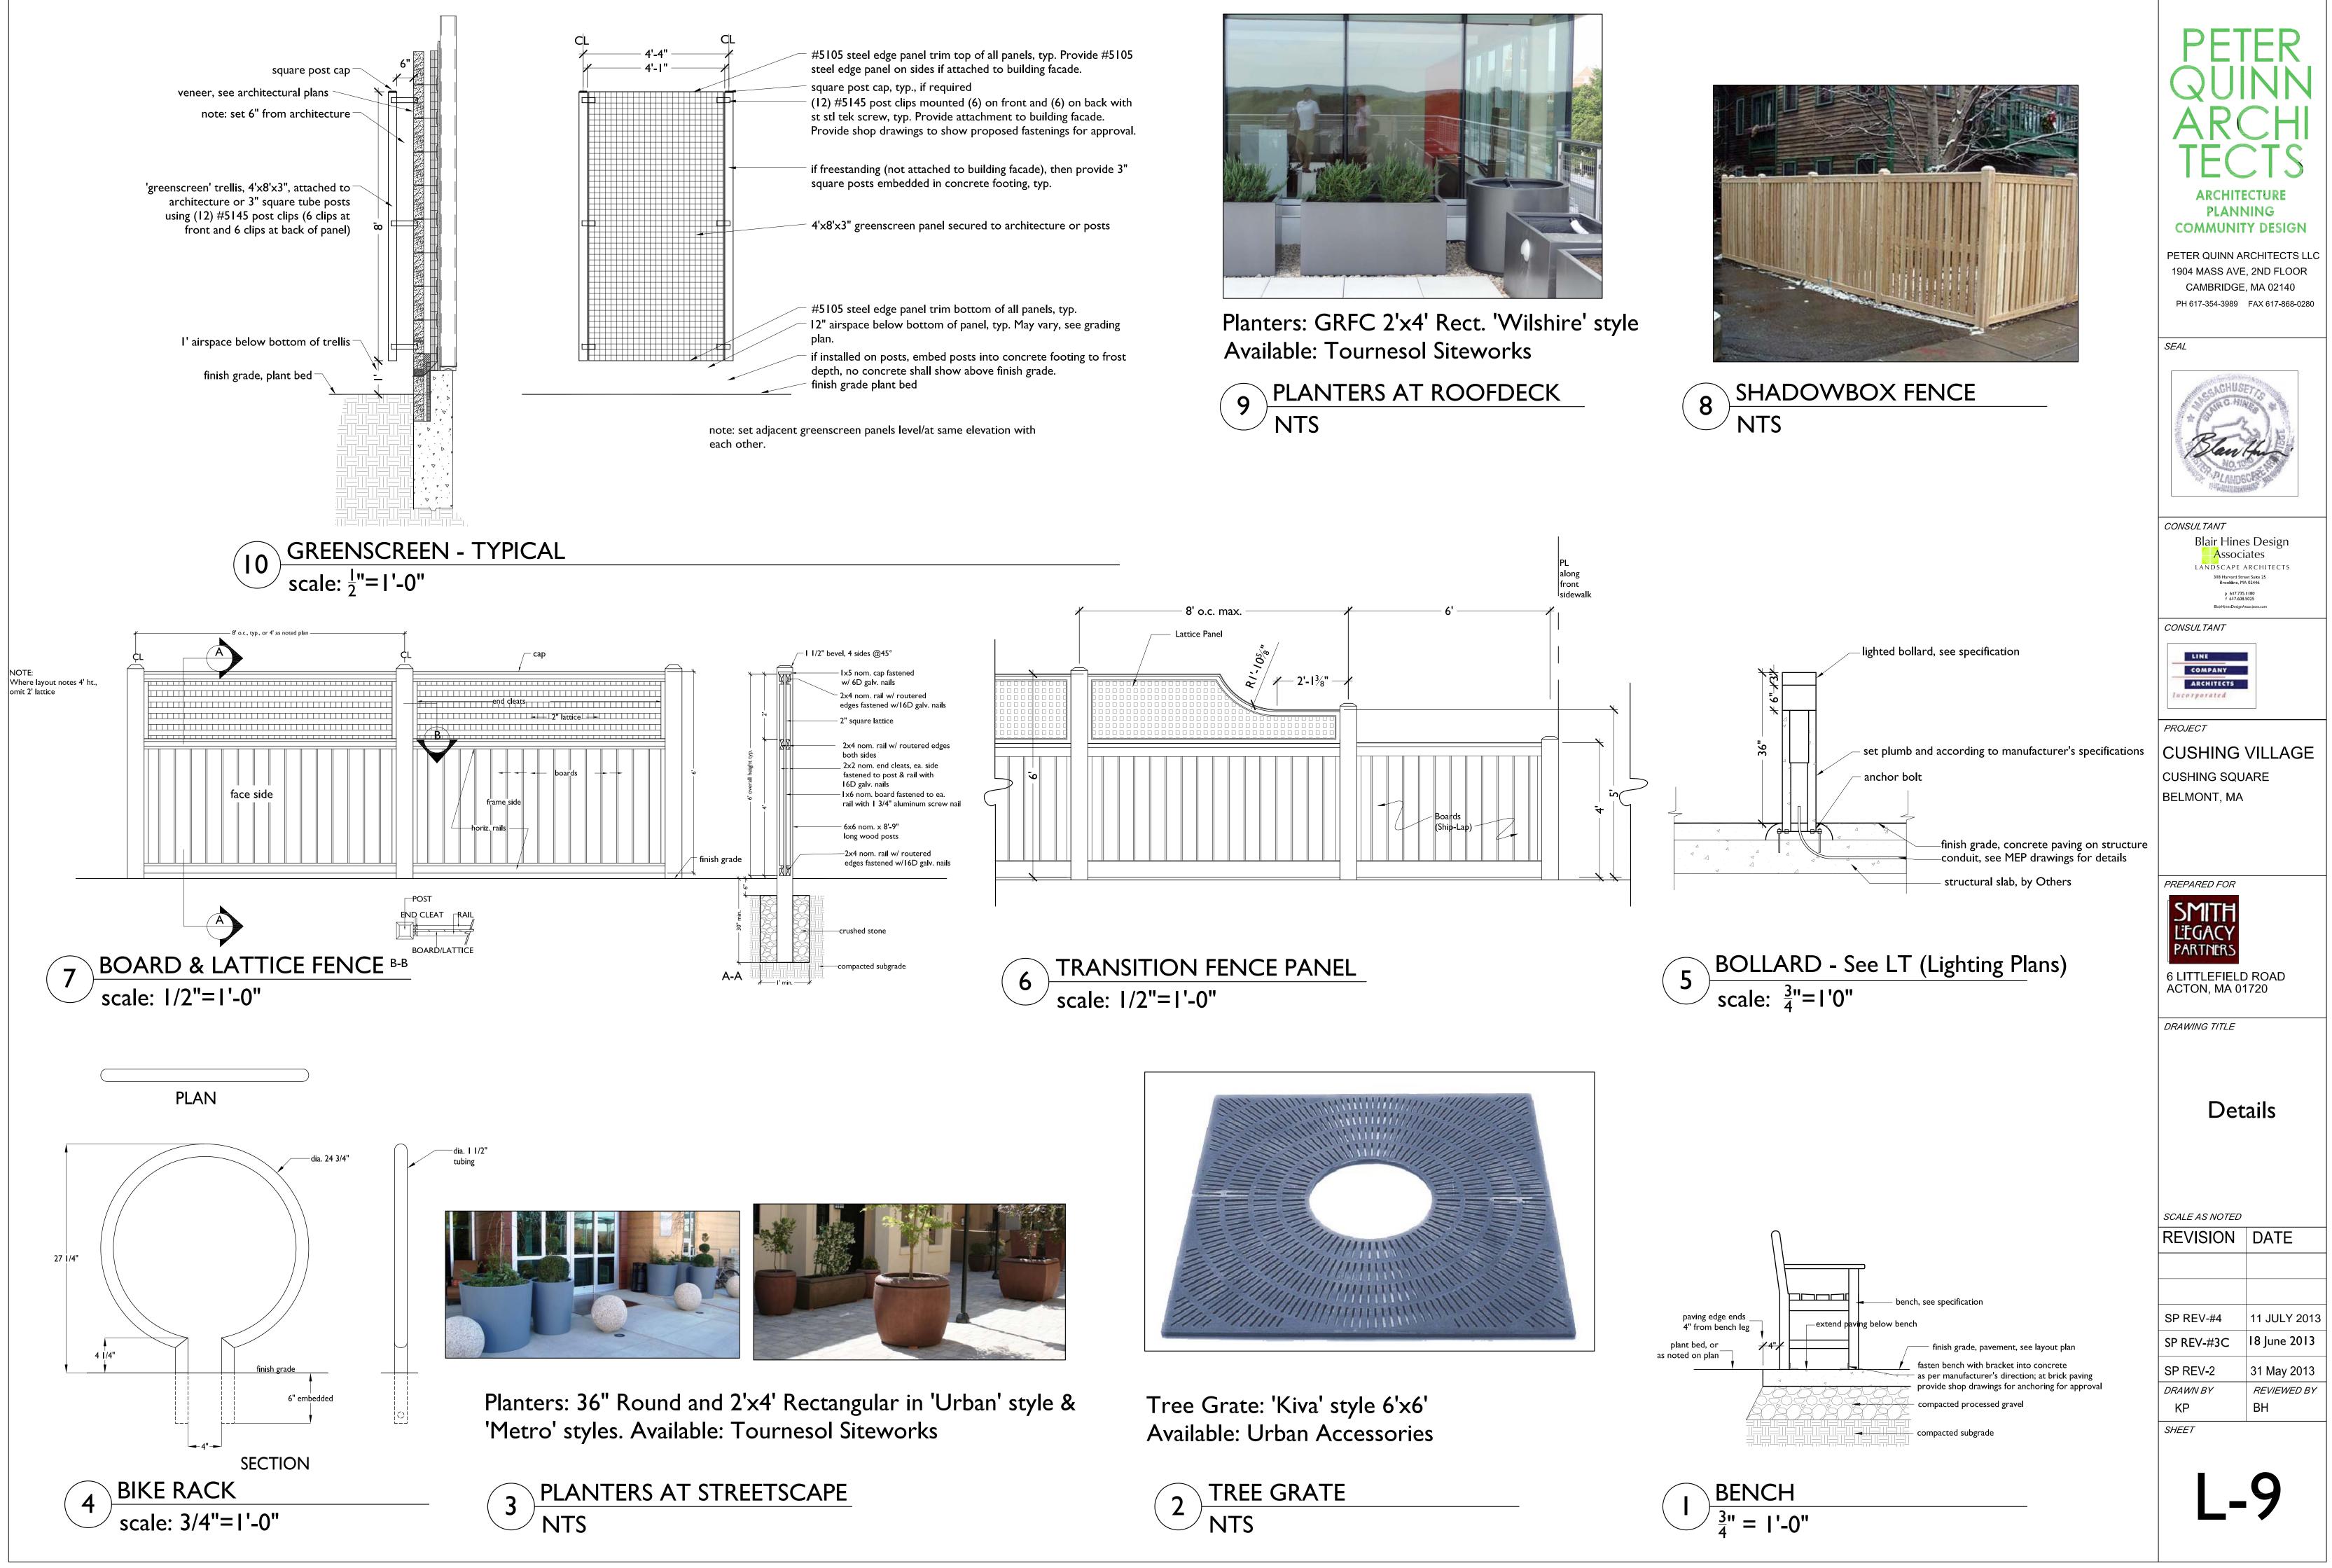




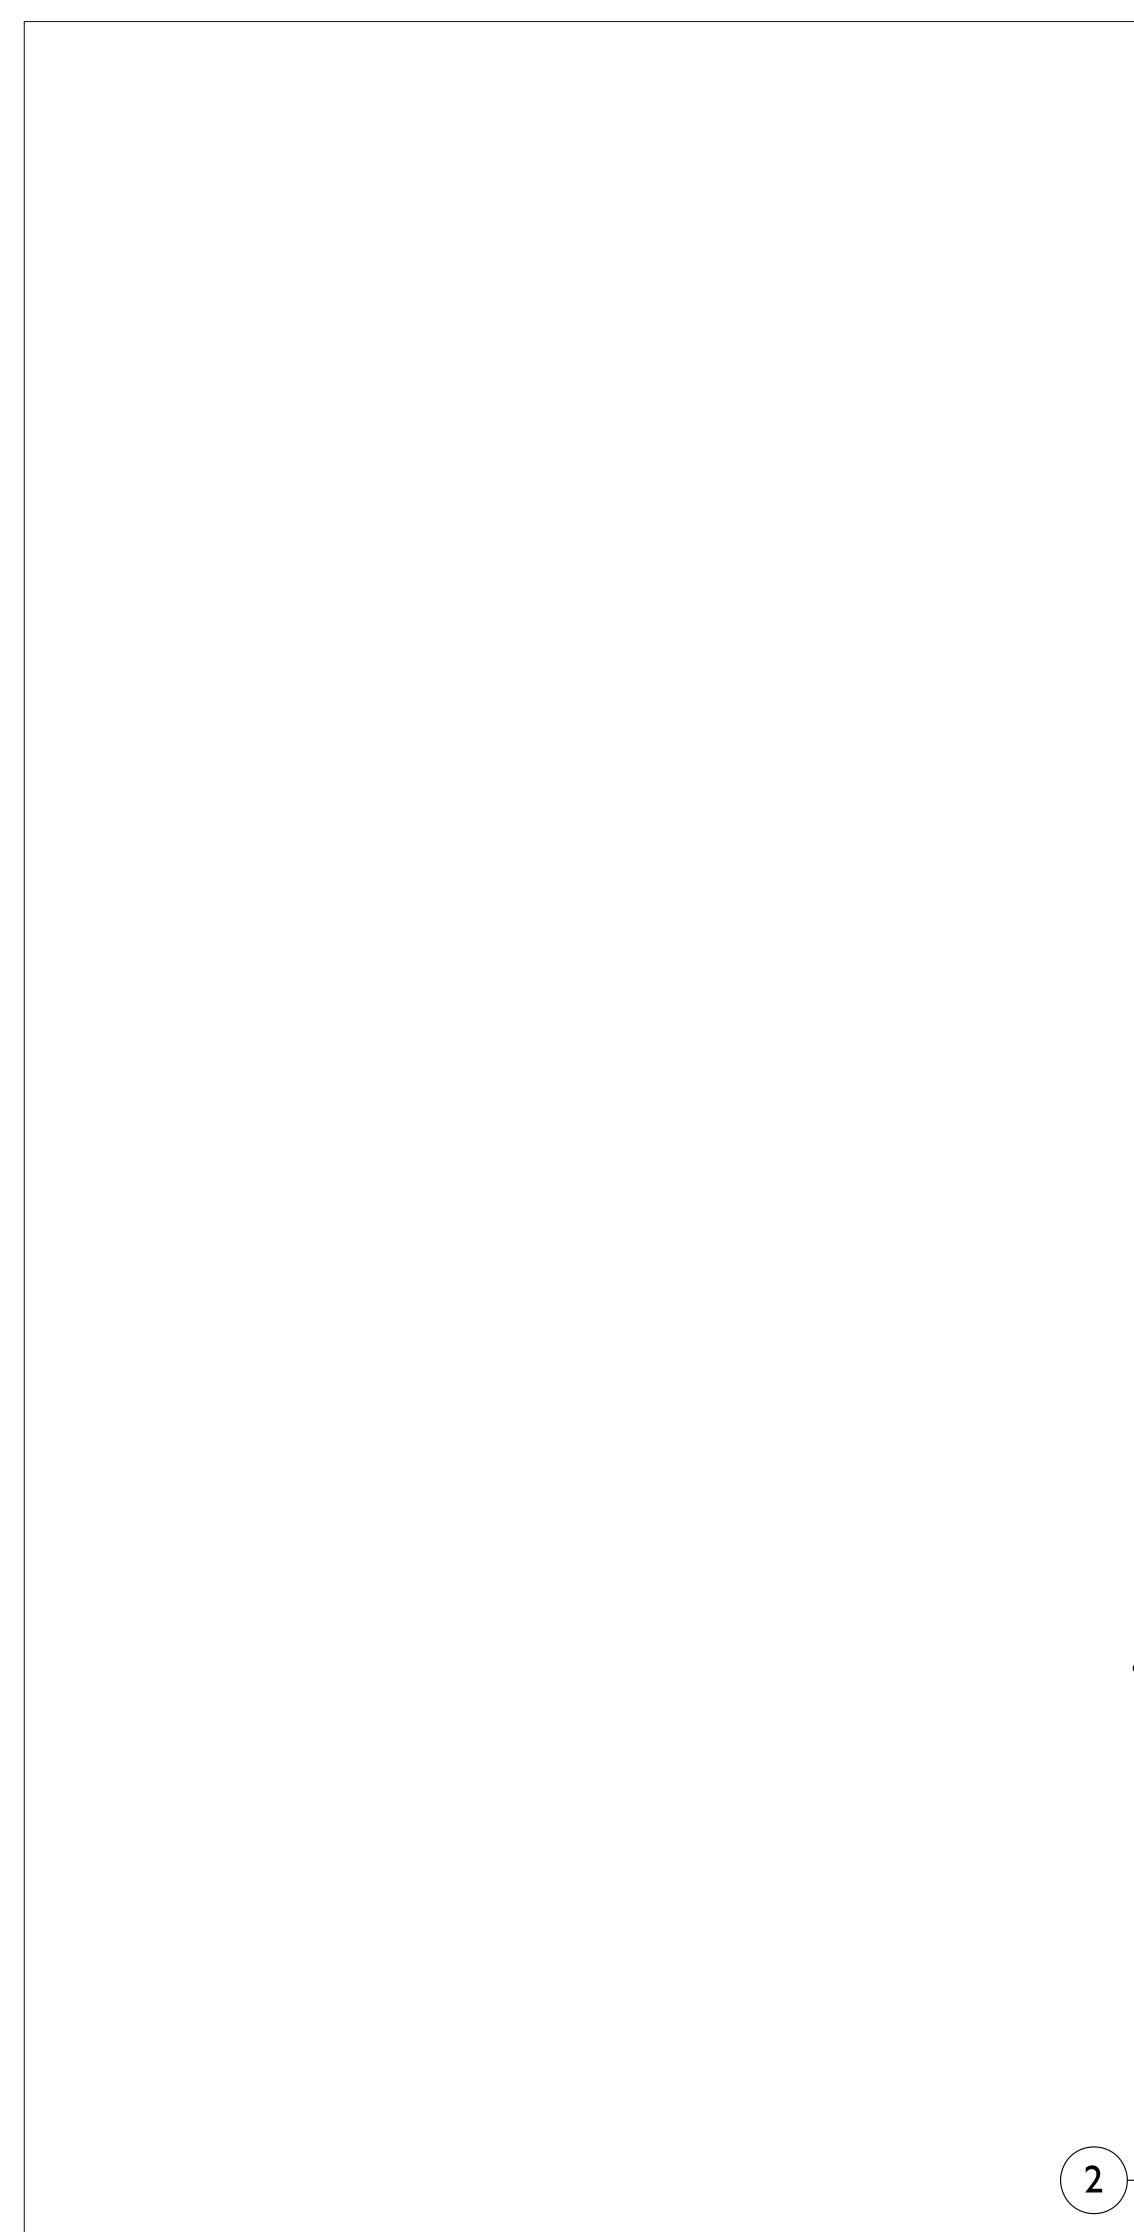

$2 \frac{\text{CONCRETE RETAINING WALL - SECTION}}{1/2" = 1'-0"}$

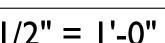

$\frac{3}{4}$ = 1'-0"

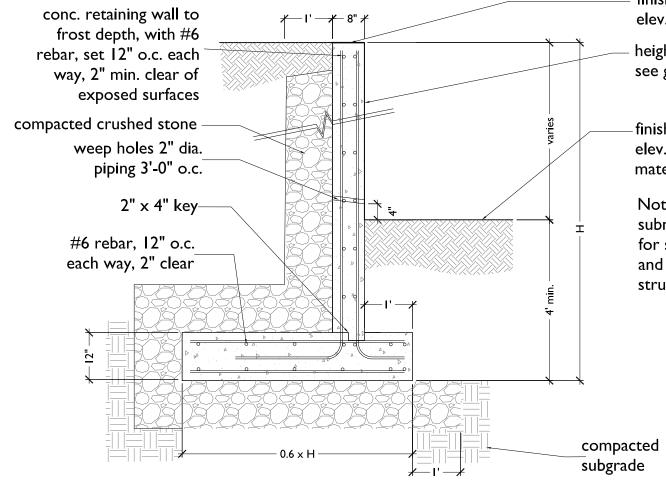


⊀−−**I**′ −**⊀**− 8″ **⊀**


Note: Contractor shall submit shop drawing for steel placement and size stamped by structural engineer


—finish grade, elev. varies & material varies

elev. varies height of wall varies, see grading plan

finished grade,

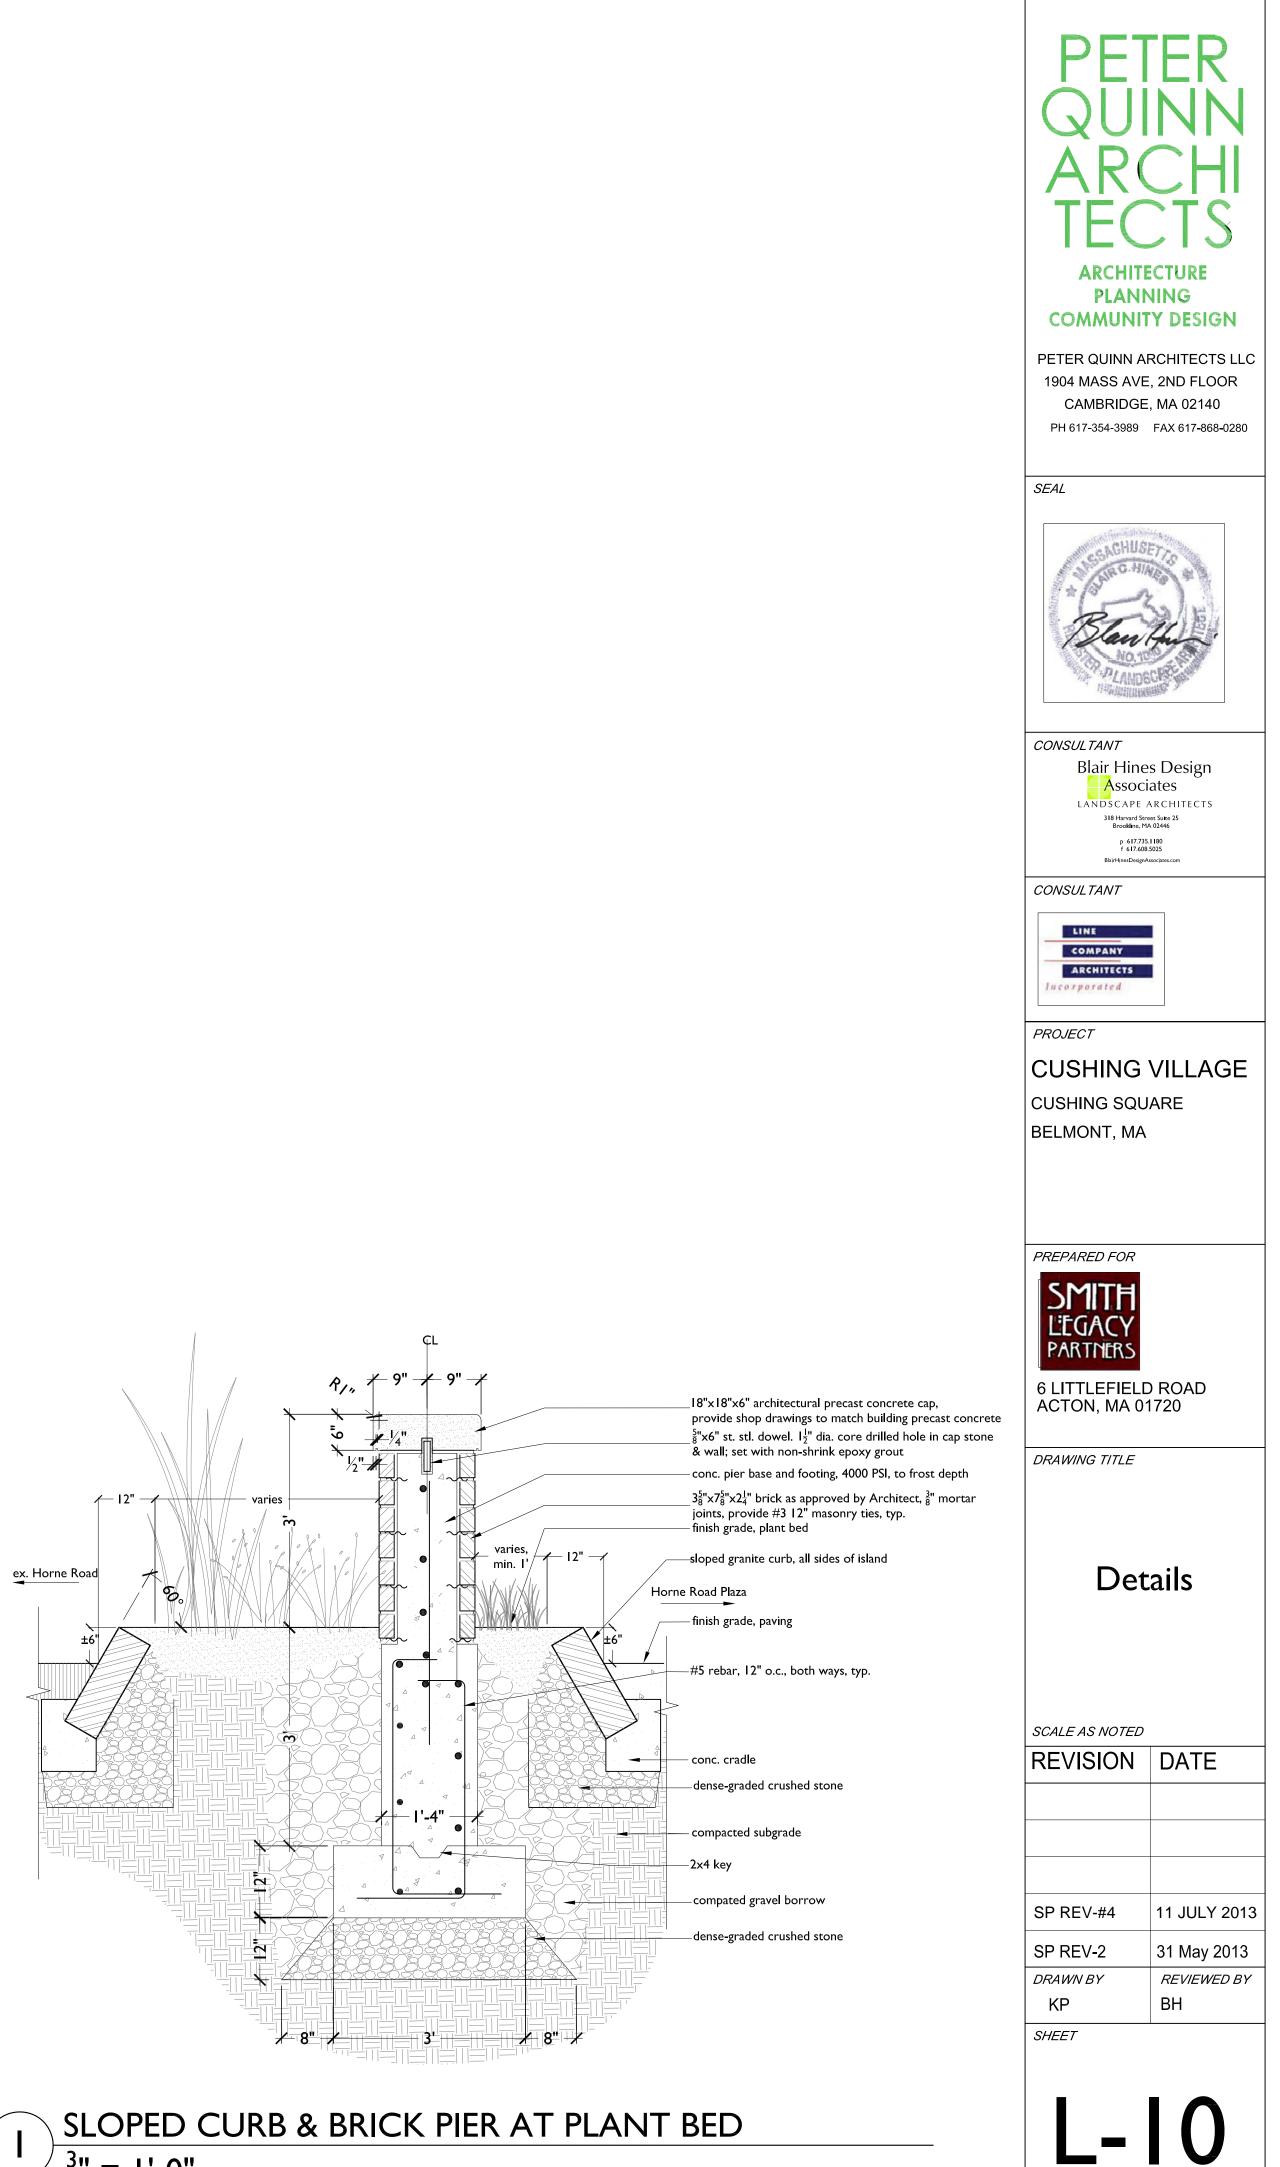

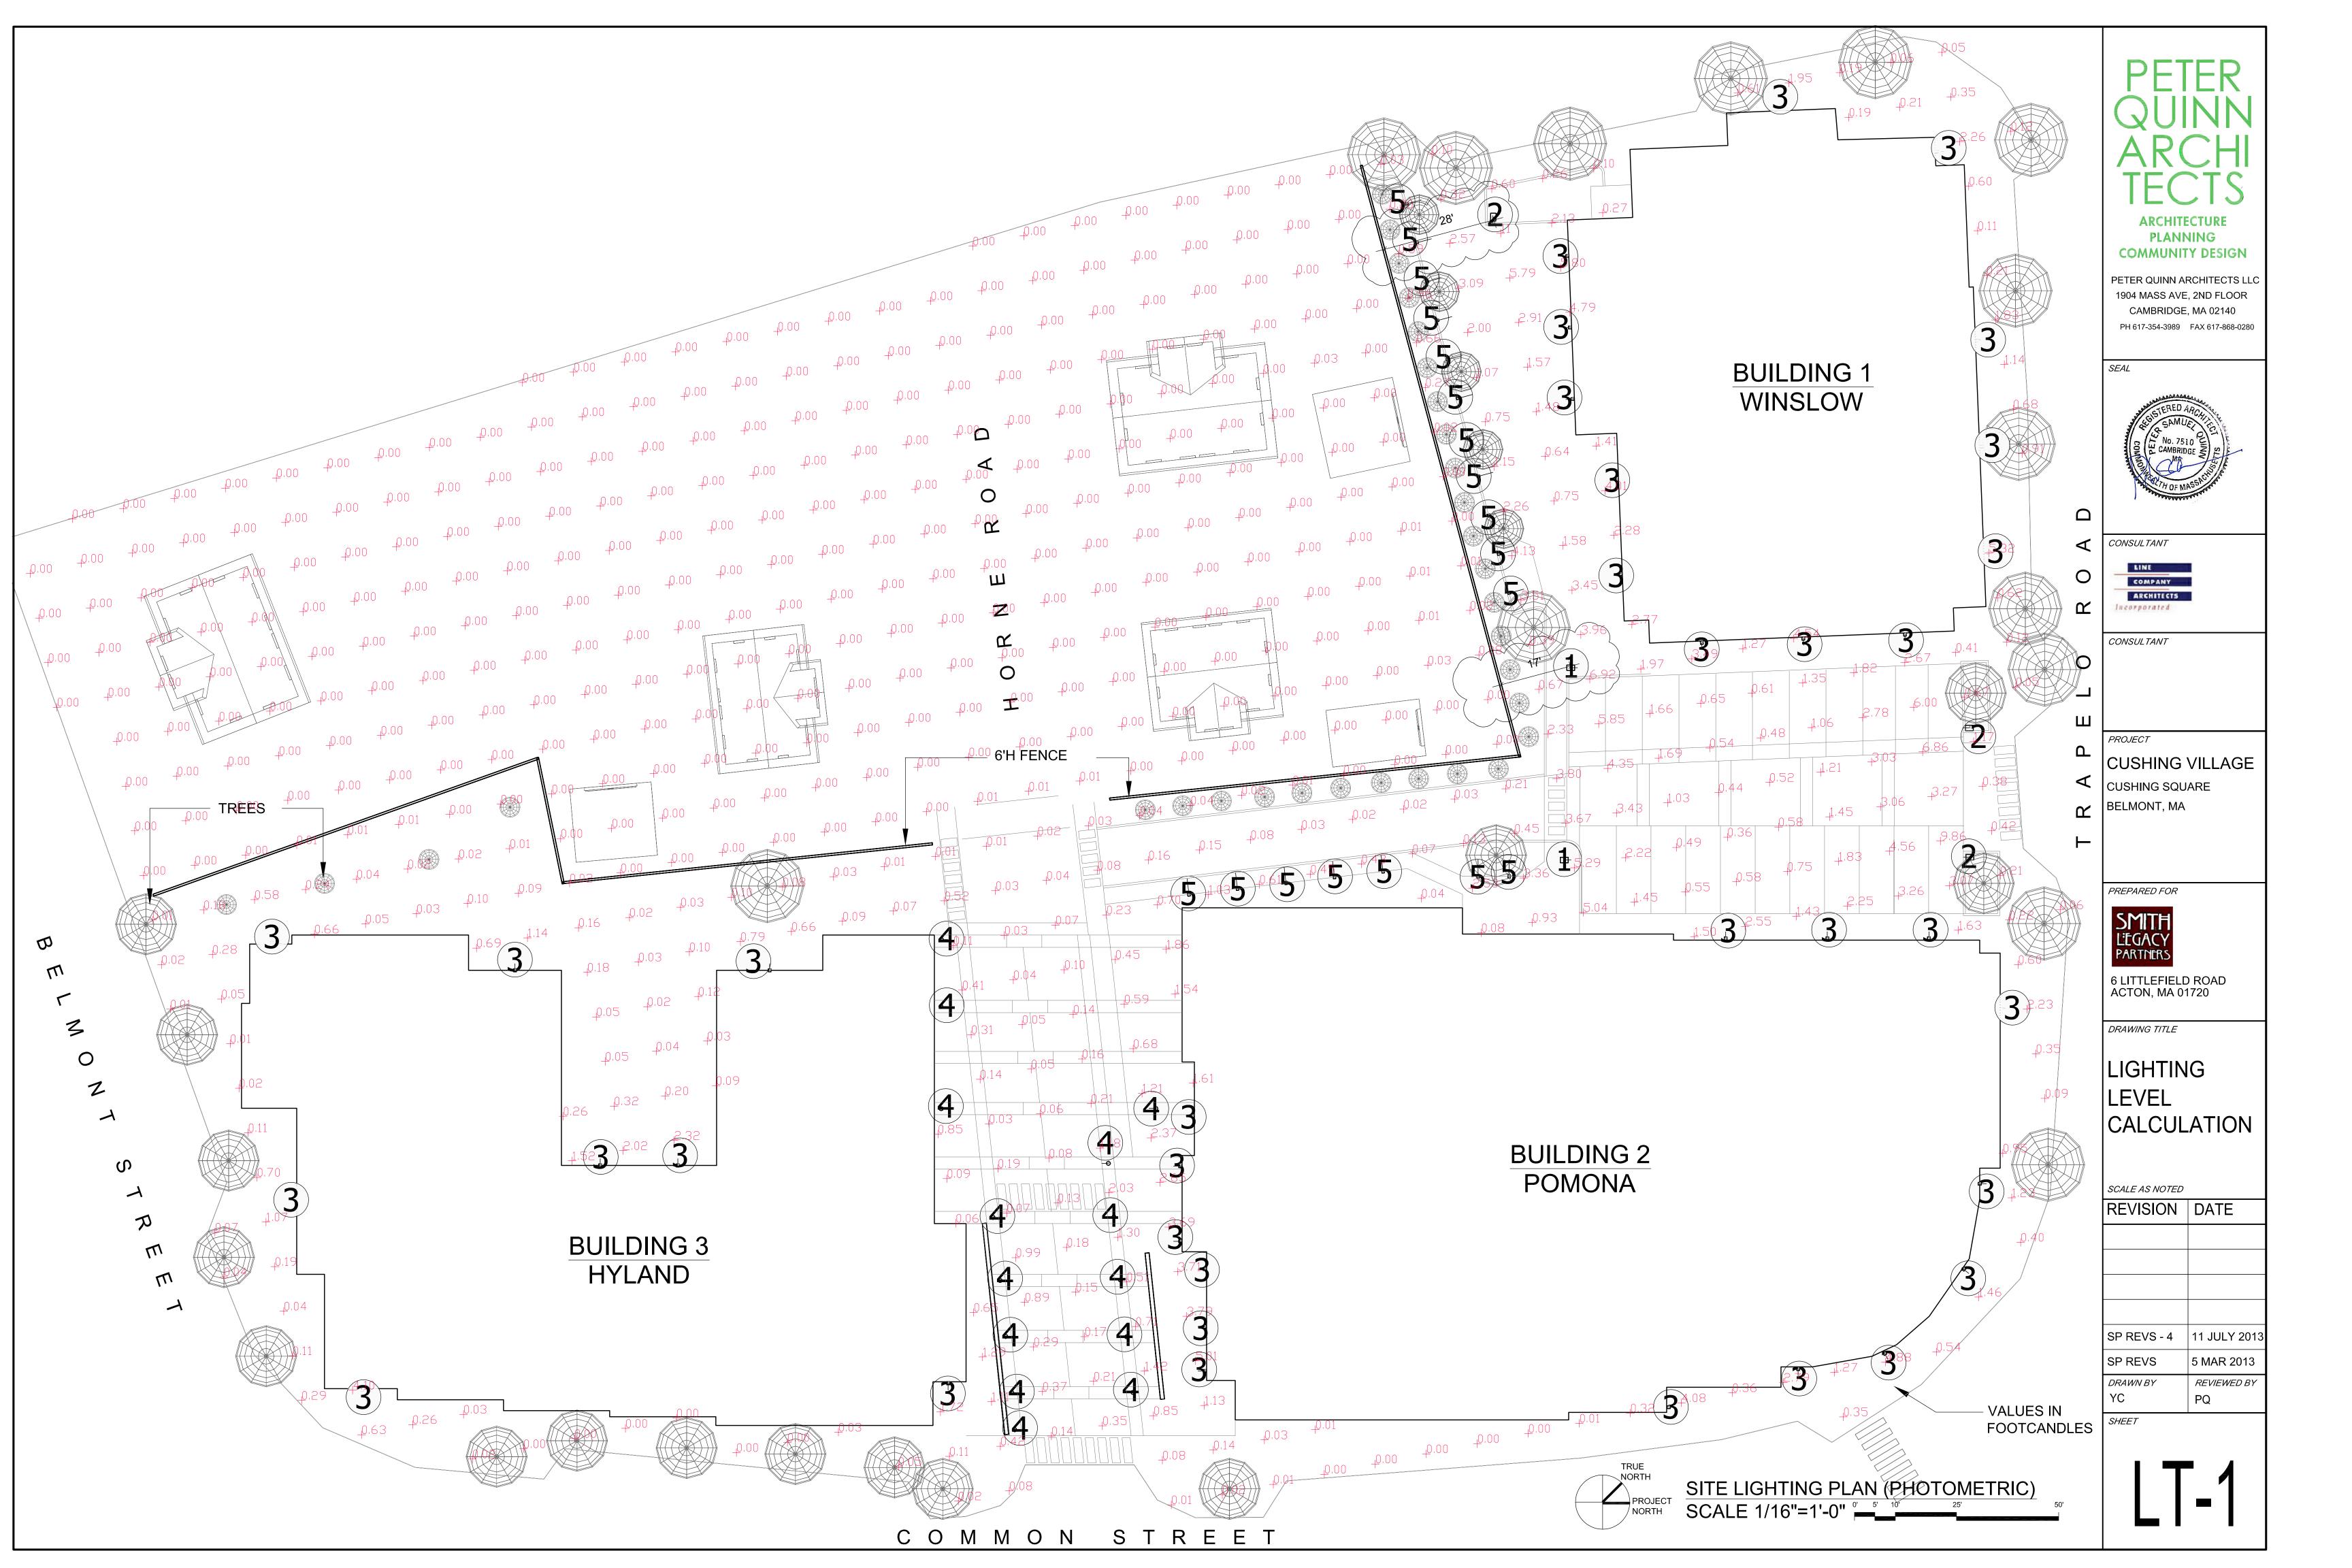

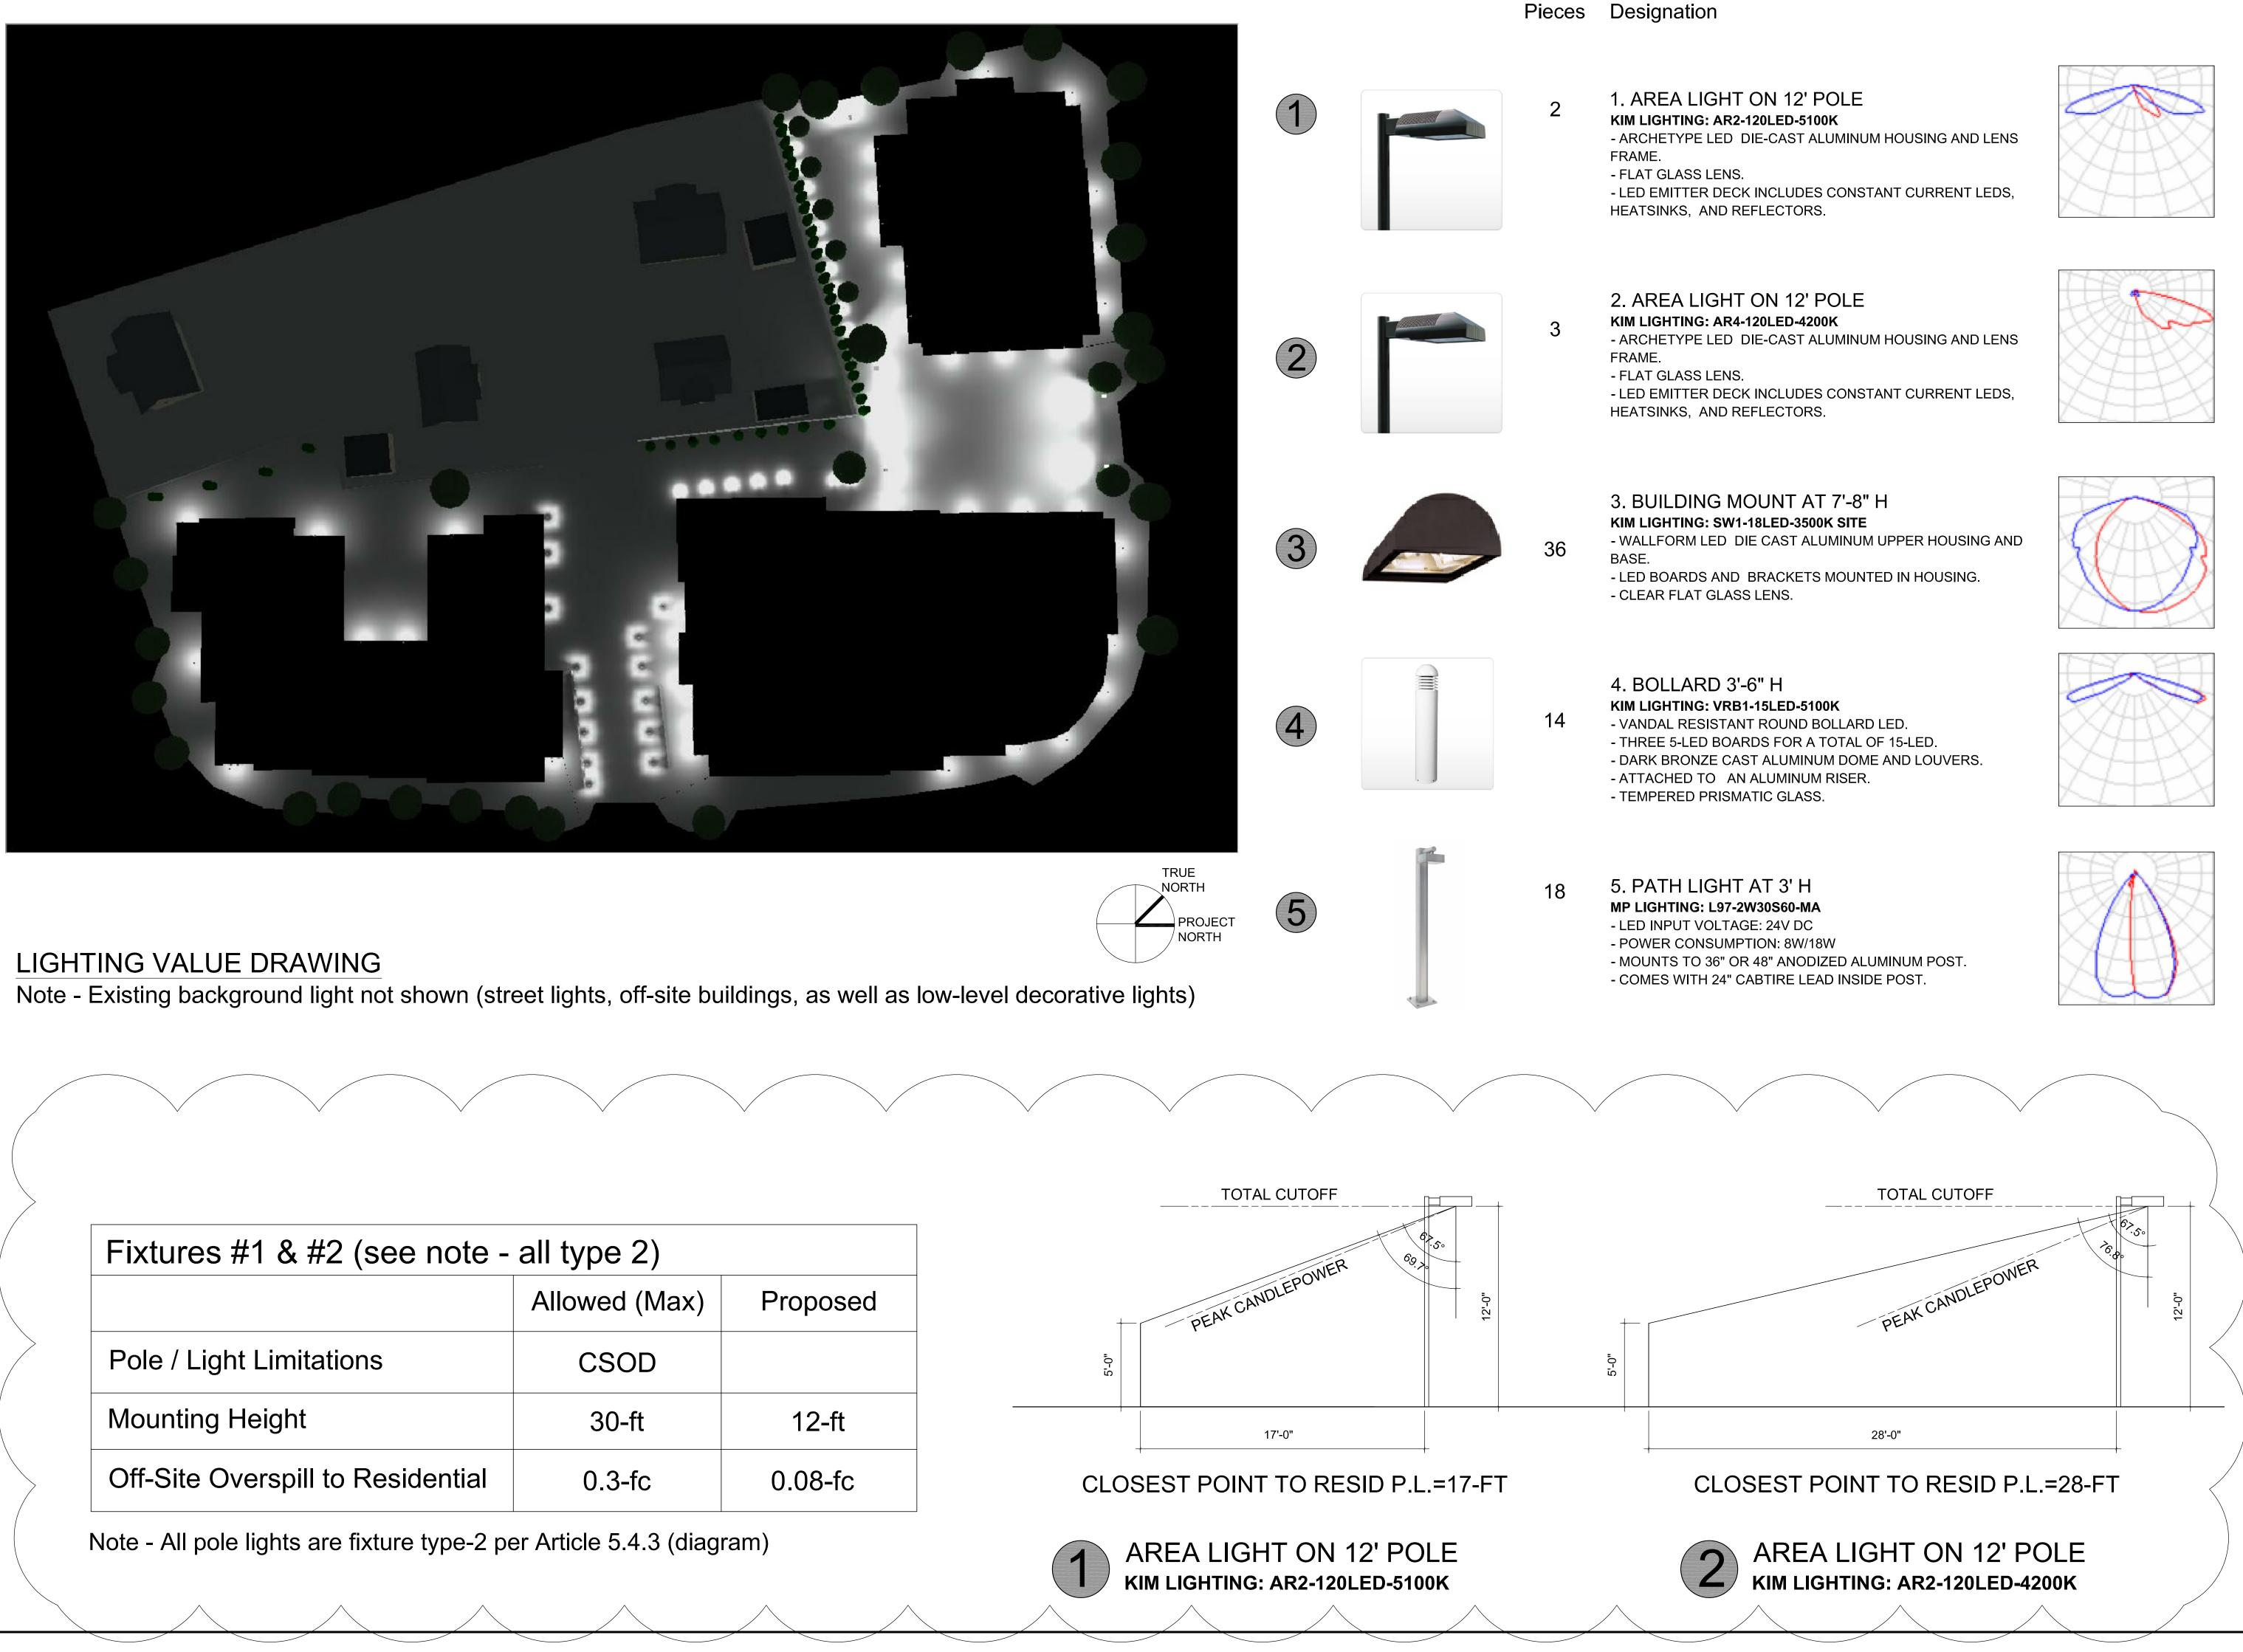

	Allowed (Max)	Proposed
Pole / Light Limitations	CSOD	
Mounting Height	30-ft	12-ft
Off-Site Overspill to Residential	0.3-fc	0.08-fc

PETER QUINN ARCHITECTS LI ARCHITECTURE PETER QUINN ARCHITECTS LI 1904 MASS AVE, 2ND FLOOR CAMBRIDGE, MA 02140 PH 617-354-3989				
SEAL				
CONSULTANT LINE COMPANY ARCHITECTS Incorporated CONSULTANT				
PROJECT CUSHING VILLAGE CUSHING SQUARE BELMONT, MA				
PREPARED FOR SMITH LEGACY PARTNERS 6 LITTLEFIELD ROAD ACTON, MA 01720				
DRAWING TITLE LIGHTING GRAPHICS AND FIXTURES				
SCALE AS NOTED REVISION DATE				
SP REVS - 4 11 JULY 20 SP REVS 5 MAR 201 DRAWN BY REVIEWED B YC PQ SHEET	3			