

Town of Belmont Planning Board

APPLICATION FOR A SPECIAL PERMIT

	Date: _	August/5/2202
Planning Board Homer Municipal Building 19 Moore Street Belmont, MA 02478		
To Whom It May Concern:		
Pursuant to the provisions of Massachuset Section 9, as amended, and the Zoning By-Law of undersigned, being the owner(s) of a certain parcesituated on 277 Channing Strong Strong Special Permit for the erection or alterate thereof under the applicable Section of the Zoning creating an addition to an existing single family western side of the structure, as well as building	of the Town of el of land (with reet/Road, he dion on said p g By-Law of s ily home. Ad	f Belmont, I/we the the the buildings thereon) ereby apply to your Board remises or the use aid Town for ding 4 feet along the
on the ground that the same will be in harmony said Zoning By-Law. Signature of Petitioner Print Name Address		son ing Rd
Daytime Telephone Number	617584857	



OFFICE OF COMMUNITY DEVELOPMENT TOWN OF BELMONT

19 Moore Street Homer Municipal Building Belmont, Massachusetts 02478-0900

Telephone: (617) 993-2650 Fax: (617) 993-2651

Building Division (617) 993-2664 Engineering Division (617) 993-2665 Planning Division (617) 993-2666

June 27, 2022

Isaiah Berson 277 Channing Road Belmont, MA 02478

RE: Denial to Construct an Addition

Dear Isaiah Berson,

The Office of Community Development is in receipt of your building permit application for the construction of an addition at 277 Channing Road located in the Single Residence C (SR-C) Zoning District.

Your application has been denied because it does not comply with the Zoning By-Law. More specifically, §1.5.4C(2) allow expansions more than (30%) of the existing Gross Floor Area in the Single Residence C district by a Special Permit granted by the Planning Board. Also, §4.2.2 of the Zoning By-Law requires a minimum 25' front yard setback and a 10.0' side yard setback to the dwelling.

- 1. The proposed expansion exceeds the 30% existing Gross Floor Area threshold and is allowed by a Special Permit granted by the Planning Board.
- 2. The existing front yard setback is 19.9' and the proposed front yard setback is 19.9', a Special Permit is required.
- 3. The existing side setback on the side is 4.8' and the proposed side setback is 4.8', a Special Permit is required.

You may alter your plans to conform to the current Town of Belmont Zoning By-Law and resubmit a building permit application, or you may request three (3) Special Permits from the Planning Board. If you choose this option, please contact the Office of Community Development to schedule an appointment with Robert Hummel, Senior Planner at (617) 993-2650 in order to begin the Special Permit process.

Sincerely,

Glenn R. Clancy, P.E. Inspector of Buildings

Narrative statement regarding application for special permit

After living at 277 Channing Road for 5 years, we are applying for a special permit to allow us to make an addition to our home. We are hoping to expand the footprint by 4 feet and add 1 and 1/2 stories to convert the property into a more traditional family home.

The current structure is a cheaply constructed modular one-bedroom trailer home from the 1940s. The new construction will be a more modern, lovingly built family home that will better match the style and scale of the neighborhood. The addition to the home was designed by an architect to be in keeping with the neighborhood's style and feel. The orientation, scale, and design motifs of the new structure take cues from the neighboring houses to ensure it fits in with the established character of the street. The materials selected for the exterior of the building, vinyl siding and asphalt shingles, are the design standard for the surrounding houses. The current aging structure is poorly insulated and is hard to both heat and cool. The new structure will improve energy efficiency by using better building materials as well as employing heat pumps.

The current home is non-comforming due to 1) the size of the lot 2) the east side closet, which historically was the front entrance to the house protrudes 5 feet into the east side setback and 3) the front of the house is 20 feet from the road, protruding into the front setback. The new design keeps, but does not expand, the side closet and widens the house by 4 feet while maintaining the existing distance from the road. The proposed addition does not exceed lot coverage requirements and complies with height requirements and all other setbacks.


The house was built in the 1940s at the same time as a similarly sized house next door at 279 Channing Road. The neighboring house was granted a special permit in the 1990s for a similar scale addition as we are proposing. Currently our house is positioned in line with its next door neighbor 279 Channing Road and this will be maintained with the new footprint. The design for the addition uses reduced windows on the side of the house closest to our nearest neighbor, 279 Channing Road, to maintain privacy for both houses. With the proposed design, the house will continue to be smaller than the four houses closest to it, as well as be in the bottom half of houses in the defined neighborhood with regards to square feet.

Although the proposed floor area ratio is higher than neighboring houses due to the small size of the lot, a key consideration of the design was to keep as much open green space as possible to contribute to preserving the character of the neighborhood. We plan to continue improving the garden and landscaping of the property, to create an aesthetic environment for pedestrians and neighbors.







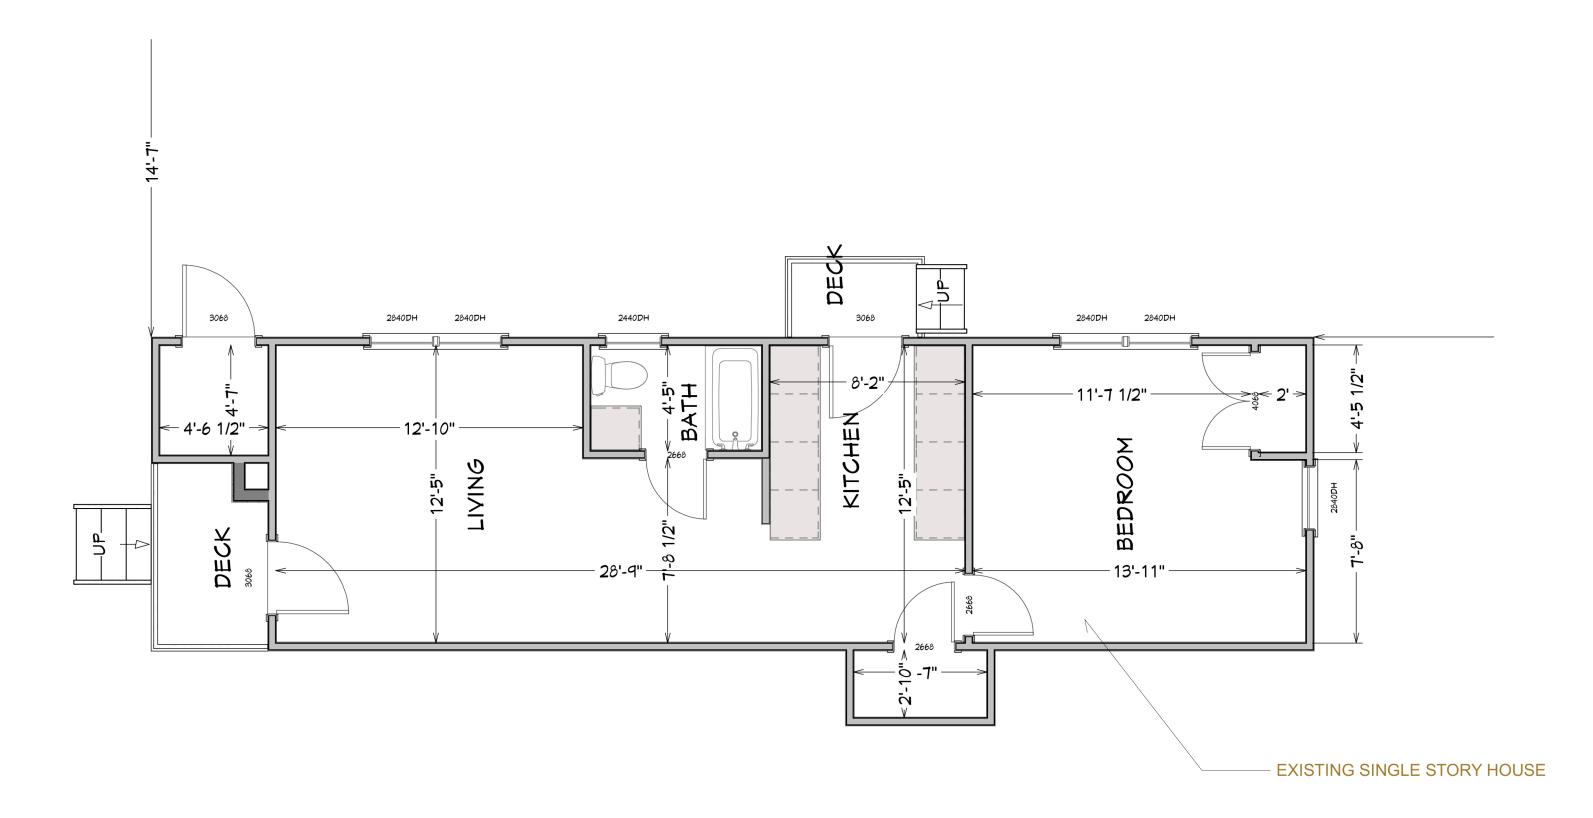



Berson Renovation277 Channing Road
Belmont, MA

SHEET TITLE

Existing First Floor

SCALE

1/4"=1'-0"

DATE

3/2/2022

SHEET NO.

Berson Renovation277 Channing Road Belmont, MA

SHEET TITLE

Proposed First Floor

SCALE

1/4"=1'-0"


DATE

3/2/2022

SHEET NO.

47.5 + 47.5 + 16 + 16 + 2.8 + 2.8 = 132.6

47.5 * 8.1 + 42.5 * 8 + 2.8 * 5.3 = 739.6

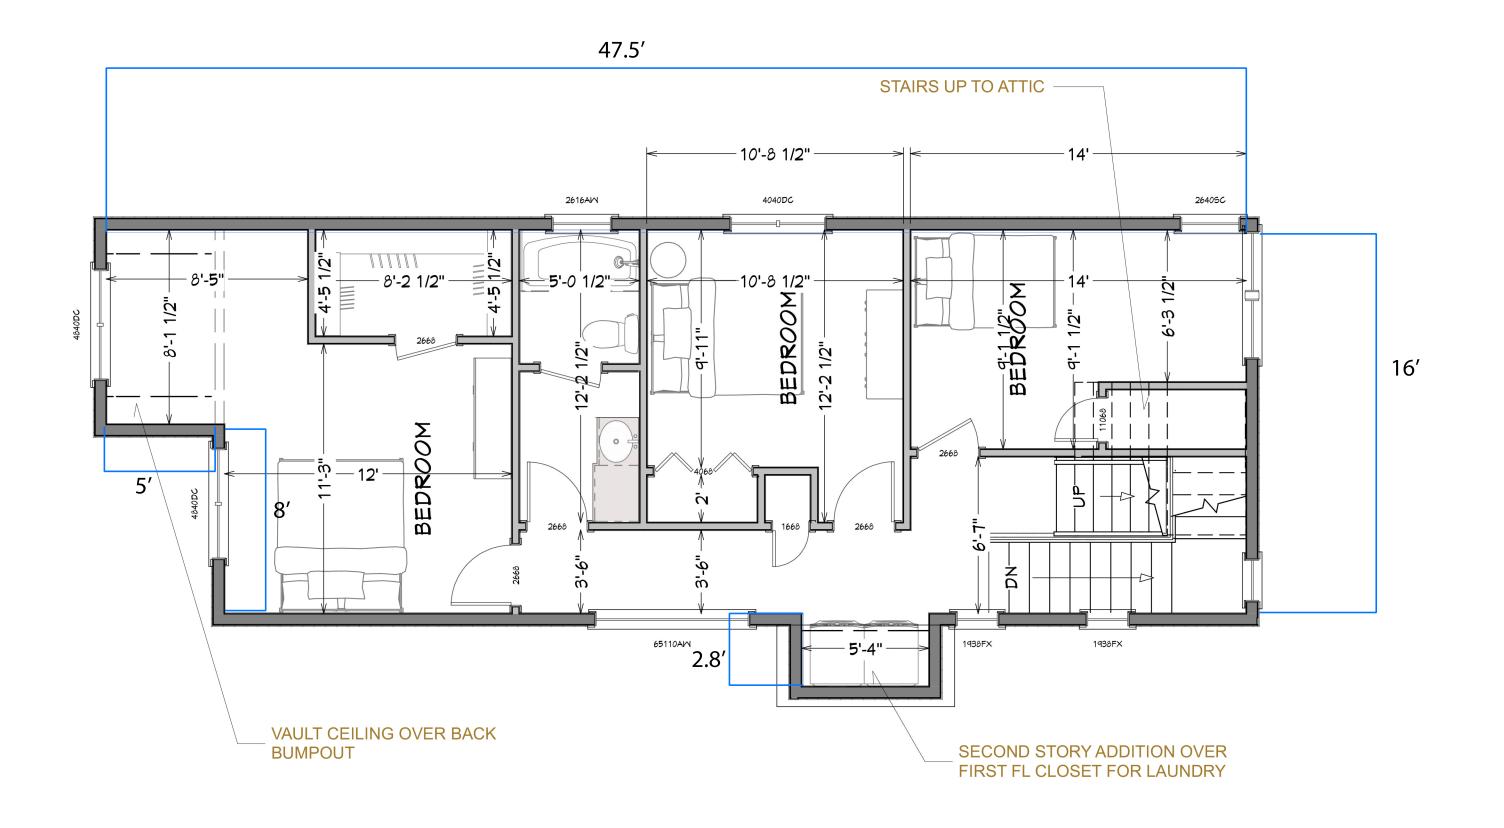

3/2/2022

SHEET NO.

Headroom calculation:

27.3 * 6.92 = 188.916 sq. ft 1 * 6.92 = 6.92 sq. ft 15 * 16.17 = 242.55 sq. ft 188.916 + 6.92 + 242.55 = 438.386 sq. feet of headroom above 5 feet

The area of the second floor is 739.6 438.386/739.6 = 59.27% 59.27% < 60%


Perimeter calculation:

10.63 + 10.63 + 15 + 15 = 51.26 ft

The perimeter of the second floor is 132.66 feet 51.26 / 132.6 = 38.7% 38.7% < 50%

Dormer length calculation:

15 ft dormer length / 43.5 roofline length = 34.48% 34.48% < 75%

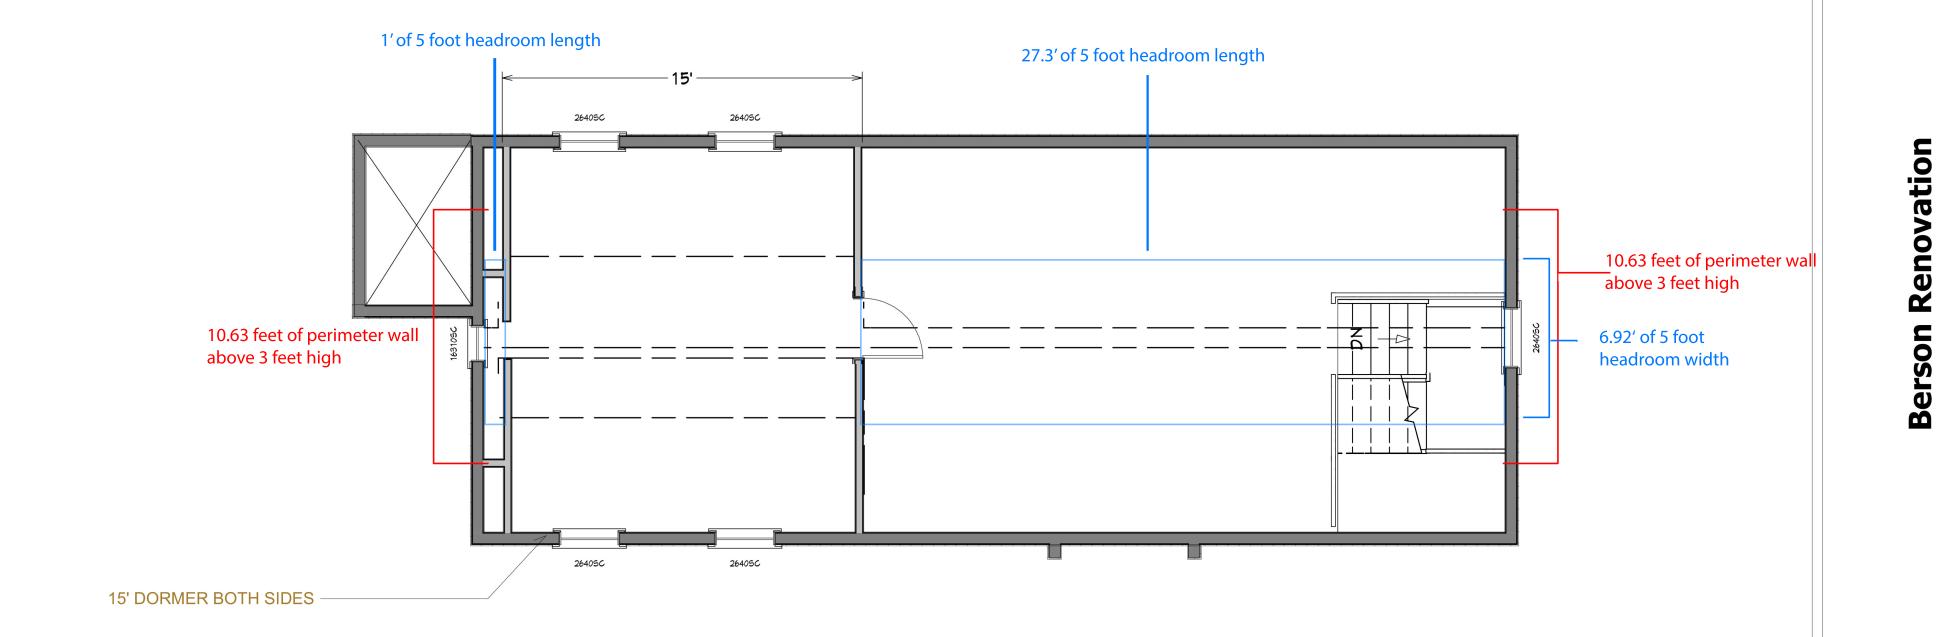


Proposed Attic

SCALE

1/4"=1'-0"

DATE 3/2/2022


SHEET NO.

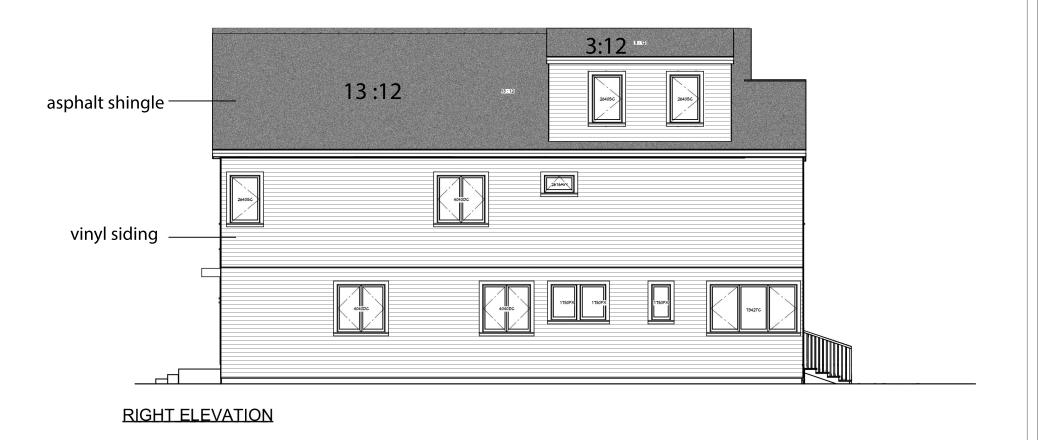

10.63

FRONT ELEVATION

291690

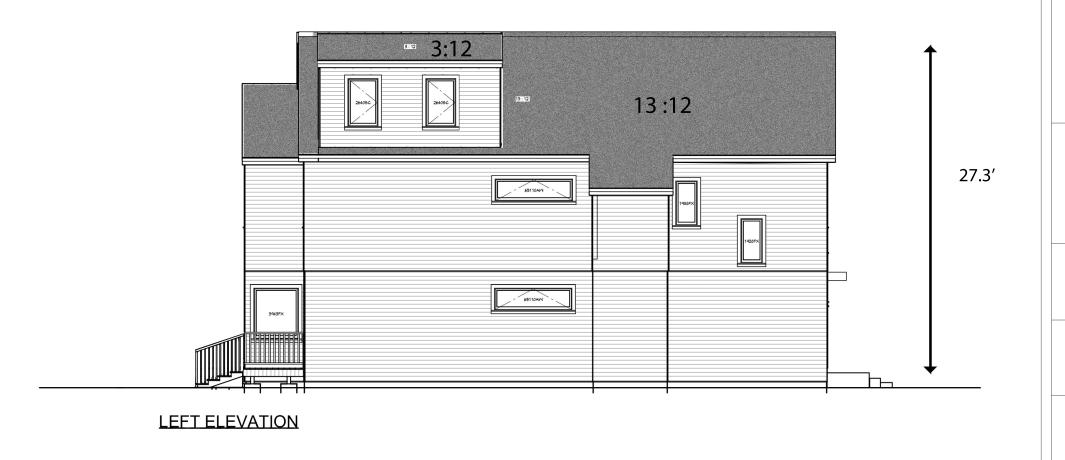

SHEET TITLE

Proposed Elevations

SCALE


1/8"=1'-0"

DATE

3/2/2022

SHEET NO.

CHANNING ROAD

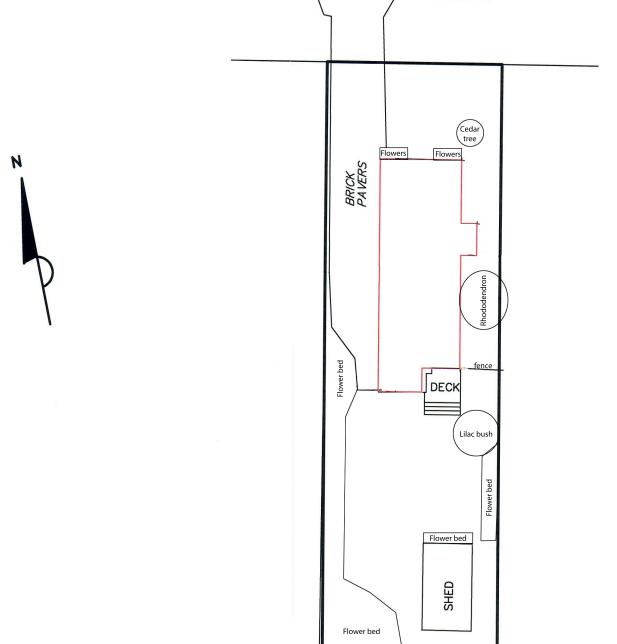


Landscaping Plan #277 CHANNING ROAD

BELMONT, MA (MIDDLESEX COUNTY)

SCALE: 1"= 20'

DATE: 4/29/2022



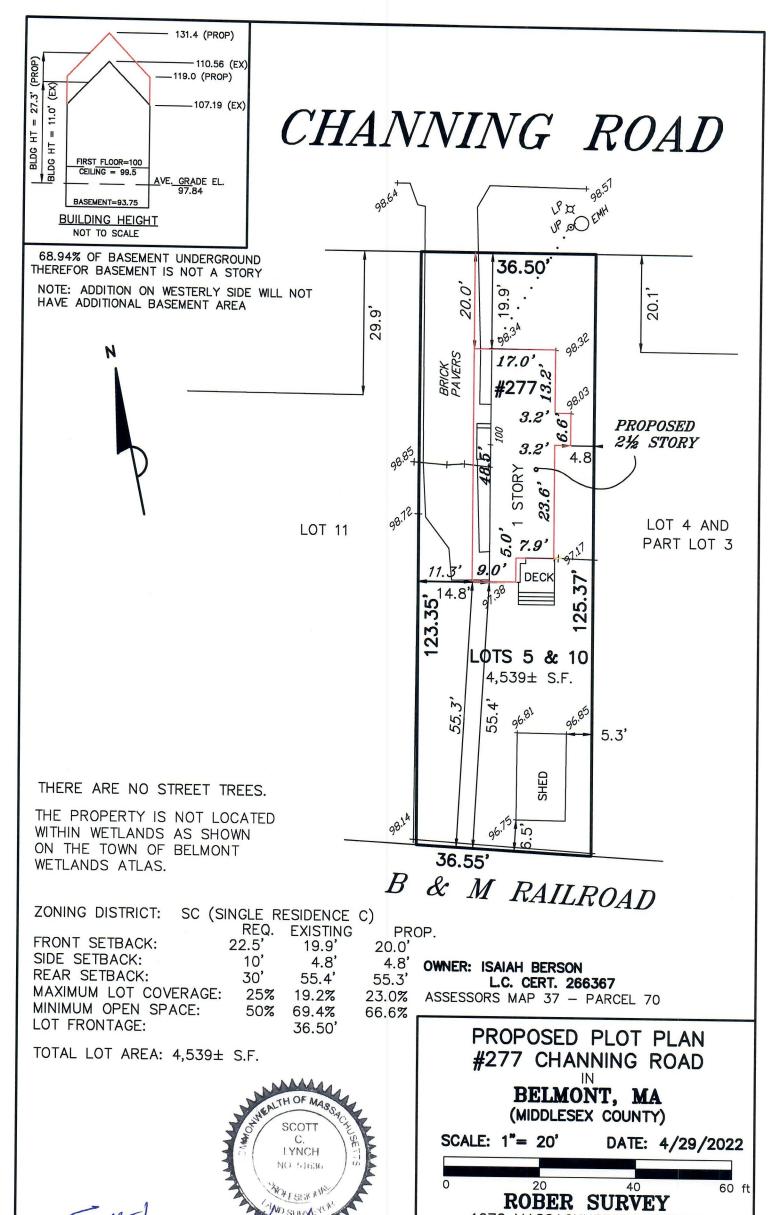

SCOTT LYNCH, PLS

DATE

1072 MASSACHUSETTS AVENUE
ARLINGTON, MA 02476
(781) 648-5533
DWG. NO. 6080PP1.DWG

Zoning Compliance Check List

Properties Located within the SR-C Districts (To be Completed by a Registered Land Surveyor)

Property Address: 277 Channin.

Surveyor Signature and Stamp:


Date: 4/29/2022

	D 84.0	P	TWO SURVEYOR					
Per §4.2 of the Zoning By-Law								
		REQUIRED	EXISTING	PROPOSED				
Lot Area (s	sq. ft.)	9000	4539	-				
Lot Frontag	ge (feet)	75	36,5	-				
Lot Covera	ge (% of lot)	25%	18.2%	23.0%				
Open Spac	e (% of lot)	50%	69,49	66,6%				
Cathard	> Front (a)	22.5'	18.8	20.0				
Setbacks: (feet)	➤ Side/Side	10 16	4.8 14.8	4.8 11.3				
	> Rear	30	554	55,3'				
Building Height:	➤ Midpoint (feet)	30/	11,0	29.3				
	➤ Ridge (feet)							
	➤ Stories	2/2	,	21/2				
1/2 Story (feet) (Per §1.4)	➤ Perimeter (50%)							
	> Area (60%)							
	> Length (75%)							
HVAC: Prohibited in Front Yard and Side and Rear Setbacks								

⁽a) Front setback is equal to the average front setbacks of the abutting properties on either side.

SUBMIT CALCULATIONS for all of the requirements listed above on a separate piece of paper(s) to verify how they were calculated

R6080 277 CHANNING ROAD 5/6/2022

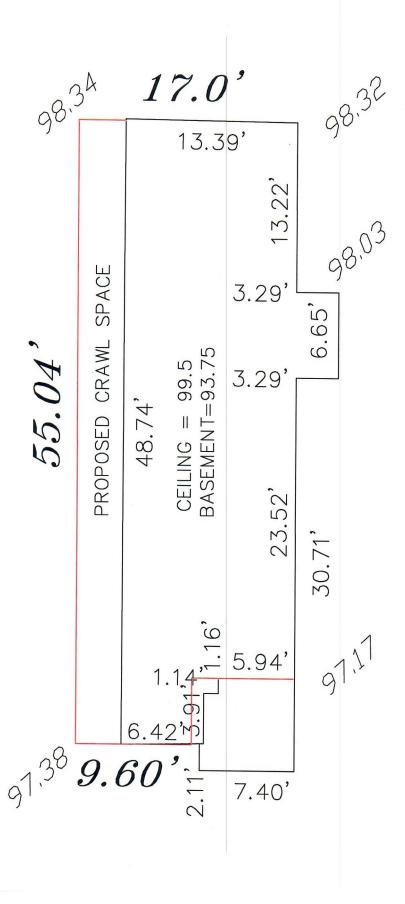

gment	Elevation	From	То	Length	Height	Footage	Footage	% Covered	Ceiling Height:
	99.51	97.38	97	.38 48.7	4 5.76	280.74	103.82	63.02%	Basement Floor Elevation
	99.51	97.38	97	.38 6.4	2 5.76	36.98	13.67	63.02%	Ceiling Elevation
	99.51	97.38	97	.38 3.9	1 5.76	22.52	8.33	63.02%	Perimeter Total Length
	99.51	97.38	97	38 1.1	4 5.76	6.57	2.43	63.02%	Total Perimeter Square Foot
	99.51	97.38	97	17 1.1	6 5.76	6.68	2.59	61.20%	Exposed Square Footage
	99.51	97.17	98	03 5.9	7 5.76	34.3872	11.4027	66.84%	
	99.51	98.03	98	03 23.5	2 5.76	135.475	34.8096	74.31%	% Covered
	99.51	98.03	98	03 3.2	9 5.76	18.9504	4.8692	74.31%	
	99.51	98.03	98	03 6.6	5 5.76	38.304	9.842	74.31%	
	99.51	98.03	98	32 3.2	9 5.76	18.9504	4.39215	76.82%	
	99.51	98.32	98	34 13.2	2 5.76	76.1472	15.5996	79.51%	
	99.51	98.34	97	38 13.3	5.76	77.1264	22.0935	71.35%	
	99.51			130.7	5.76	752.83	233.85	68.94%	

Ceiling

Ceiling

Segment

Elevation Elevation

Exposed

Square

Square



5.76 <- enter

93.75 <- enter

99.51

130.70

752.83

233.85

North South East

#REF!

0.00

0.00

0.00

#REF!

0.00

0.00

0.00

#REF! #REF! #REF!

#REF! #REF! #REF! #REF! #REF! #REF!

#REF! #REF! #REF!

#REF! #REF! #REF!

#REF! #REF! #REF!

#REF!

0.00

0.00

0.00

West

#REF!

#REF!

0.00

0.00

0.00

	Segment From Existing	Segment From New	Existing	Segment To	Segment	Avg				
Segment	Grade	Grade	Grade	New Grade	Length	Existing	Avg New	Difference	Ceiling Height:	5.76
M	97.38	97.38	97.38	97.38	9.6	934.848	934.848	0.00	Basement Floor Elevation	93.75
N	97.38	97.38	97.38	97.38	2.11	205.4718	205.4718	0.00	Ceiling Elevation	99.51
0	97.38	97.38	97.17	97.17	7.4	719.835	719.835	0.00	Perimeter Total Length	148.31
P	97.17	97.17	98.03	98.03	30.71	2997.296	2997.296	0.00	Total Perimeter Square Foot	854.27
Q	98.03	98.03	98.03	98.03	3.29	322.5187	322.5187	0.00	Average Existing Grade	97.84
R	98.03	98.03	98.03	98.03	6.65	651.8995	651.8995	0.00	New Average Grade	97.84
S	98.03	98.03	98.03	98.03	3.29	322.5187	322.5187	0.00	Difference in Grade in feet	0.00
Т	98.03	98.03	98.32	98.32	13.22	1297.874	1297.874	0.00		
U	98.32	98.32	98.34	98.34	17	1671.61	1671.61	0.00		
V	98.34	98.34	97.38	97.38	55.04	5386.214	5386.214	0.00		
					148.31	14510.09	14510.09	0	% Covered using Avg Grade	70.94%

Segment To

