NOTICE OF PUBLIC HEARING BY THE TOWN OF BELMONT PLANNING BOARD

ON APPLICATION FOR THREE SPECIAL PERMITS

Notice is hereby given that the Planning Board will hold a public hearing on Thursday, April 8, 2021 at 7:00 PM by remote access through the Zoom app. to consider the application of Ms. Christine Arthur and Mr. Eugene Klein to construct a second family unit and an addition at 201 Lexington Street located in General Residence (GR) Zoning District. Special Permits: 1.- §1.5.4A of the Zoning By-Law allows alteration and expansions of larger than 300 square feet in the GR district be a Special Permit granted by the Planning Board. 2.- §3.3 of the By-Law allows the construction of a two family (or a conversion of a single family to a two family) by a Special Permit. §4.2.2 of the By-Law requires a minimum side setback of 10.0°, the existing and proposed side setback is 7.5°.

Note: Application submittals, meeting agenda & instructions on remote access can be found on the Town's website: https://www.belmont-ma.gov/planning-board

TOWN OF BELMONT PLANNING BOARD



Town of Belmont Zoning Board of Appeals

APPLICATION FOR A SPECIAL PERMIT

Date:	3/2/2021	
		_

Zoning Board of Appeals Homer Municipal Building 19 Moore Street Belmont, MA 02478

To Whom It May Concern:

Pursuant to the provisions of Massachusetts General Laws, Chapter 40A,
Section 9, as amended, and the Zoning By-Laws of the Town of Belmont, I/we the
undersigned, being the owner(s) of a certain parcel of land (with the buildings thereon situated onStreet/Road, hereby apply to your Board
for a SPECIAL PERMIT for the erection or alteration on said premises or the use
thereof under the applicable Section of the Zoning By-Law of said Town for hvo(2
especial Permits: (1) second dwelling unit and (2) alter a non conforming structure,
J .
on the ground that the same will be in harmony with the general purpose and intent said Zoning By-Law.
Signature of Petitioner Chings Orflus
Print Name CHRISTINE ARTHUR
Address 201 LEXINGTON ST
BELMONT MA 02478
Daytime Telephone Number 617 458 9301




Project Synopsis for 201 Lexington St in Belmont 02.09.2021

Our existing home is a 2 ½ story, 1870's shingled, single-family residence located on the corner of Lexington St and Laurel St in the GR district in Belmont, very close to the Watertown border. The buildings in the area are mixed in height and use, as there are duplex style homes, vertical duplex style homes, single family homes, multifamily homes, townhouses, large churches, a school, and a few group homes in the surrounding neighborhood.

We are proposing a vertical style duplex based on a New England protype, the Main House with a Barn. The idea is to have the Barn look as if it was built when the house was built and recently renovated. In Belmont, a past farming community, there would likely have been many homes with adjacent barns. Our goal is to create a harmonious complex that supports the neighborhood through its look, use, setbacks, structure and height.

The barn's massing is separated from the existing house, except at the ground floor, to give it a barn like feel. Each dwelling unit has a garage with permeable parking area on Laurel Street so as to not add curb cuts on Lexington Street. This vignette shows the Laurel Street side without some of the street trees and landscaping for clarity.



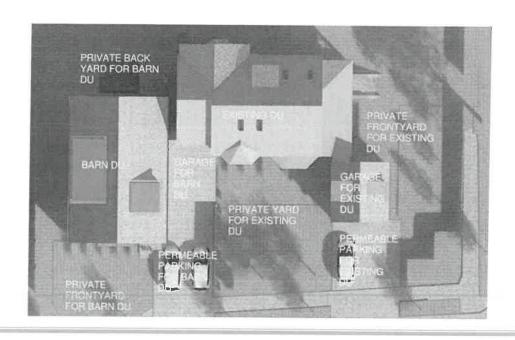

In late 2019, we met with two members of the Planning Board and Spencer Gober to discuss the project. Both the Planning Board members really liked the project and wanted it to move forward. They were delighted that the project was well designed. They were at first concerned that the barn was taller than the existing home, but it was not, and is not. The way Belmont measures height is to ½ the height of a sloped roof or to the top of a dormer. Since the Barns dormer is taller than the existing homes dormer, it seemed like the barn was taller in the survey information. The barn is 1'-0" shorter than the existing home measured to the top of the roof peak from the ground plane.



From our meeting we had thought the project would move forward quickly. Within a few weeks we received a missive from Spencer saying that the project would have difficulty on a few fronts. In the letter he mentioned that Total Living Area (TLA) was much larger than typical duplexes in the neighborhood. However, this is a vertical style duplex, like that at 316-318 Trapelo Road, which allows an attached garage and 2 ½ stories and thus creates a much larger floor plate and TLA.

Lot coverage was also a concern to Spencer, although the lot coverage was below the 30% max required by the code for all projects in the GR district. Again, this is similar to the vertical style duplex on Trapelo Rd. Our project also keeps more open space than required and has mature trees that will not be buildoze



Here is another example of a vertical style duplex in our neighborhood in Watertown. This duplex at 63 Holt Street was recently completed, and each unit has 3,750 sf of interior area, large garages with parking in front for each unit and 2 ½ stories above the garage level.

The Staff also recommended that we look at 172 and 174 Lexington Street, which demolished a 2½ story grand vertical style duplex from the 1870's and replaced it with two single-family, two-story homes that have garages in the back of the houses. Since we have a larger lot size than 8,000 sf, we too would likely be allowed to tear down the existing 1870's house to build two new houses. Although this is a nice project, we hope that you will see the value of keeping an 1870's home as a baseline to a design rather than having to demolish it to allow development of a site.



Height was also brought up as an issue, and these two houses, I was told, represent the TOB issue with the $\frac{1}{2}$ story 3^{rd} floor. We were told to keep the project to 2 stories, like this project did. The height of 2 $\frac{1}{2}$ stories is allowed by the current code and works well along the arterial streets that are wider and lined with typically taller buildings. To our north, east and south are other 1870's 2 $\frac{1}{2}$ story homes. Laurel Street has a few 2 $\frac{1}{2}$ story homes.

In January 2020, we sent emails to Spencer asking about the next requirements to move the project forward. He did not reply. After a while, I realized Spencer had always replied, so I looked him up and found out he had moved to another city in another state and no longer worked for the TOB. I then contacted Jeffrey Wheeler about the project. By that time, we were in quarantine, so we set up zoom meetings. We talked twice early in the pandemic, but he did not reply to any forms of communication past that second meeting. He obviously had more on his mind than my project, and I did not know he was ill. I asked others in the department but there were no answers.

We are resubmitting this proposal as is because the project works well and we are responding to the issues that were brought up by the Town. Likely, if we had asked to tear down the existing home, we would have been given permission to build two dwelling units by now. Although more complex, we feel our proposed project is the better solution, one that appreciates the value of the old and complements that with the new. Please let us know your thoughts and concerns. Chris Arthur and Trey Klein



OFFICE OF COMMUNITY DEVELOPMENT TOWN OF BELMONT

19 Moore Street Homer Municipal Building Belmont, Massachusetts 02478-0900

Telephone: (617) 993-2650 Fax: (617) 993-2651

Building Division (617) 993-2664 Engineering Division (617) 993-2665 Planning Division (617) 993-2666

July 22, 2019

Ms. Christine Arthur & Mr. Eugene Klein 201 Lexington Street Belmont, MA 02478

RE: <u>Denial to Construct a Second Dwelling Unit</u>

Dear Ms. Arthur and Mr. Klein,

The Office of Community Development is in receipt of your building permit application for your proposal to construct a second dwelling unit at 201 Lexington Street located in a General Residence Zoning District.

Your application has been denied because it does not comply with the Town of Belmont Zoning By-Law. More specifically, Section 3.3 of the Zoning By-Law allows a two family dwelling in a General Residence Zoning District by a Special Permit from the Planning Board. In addition, Section 4.2.2 of the Zoning By-Law requires a minimum side setback of 10.0'. The existing and proposed side setback is 7.5' +/- and therefore the structure is considered nonconforming.

You may alter your plans to conform to the current Town of Belmont Zoning By-Law and resubmit for a building permit, or you may request two (2) Special Permits from the Planning Board: (1) second dwelling unit and (2) alter a nonconforming structure. If you choose this option, please contact the Office of Community Development to schedule an appointment with a member of the Planning staff at (617) 993-2666 in order to begin the process.

Sincerely,

Glenn R. Clancy, P.E. Inspector of Buildings



OFFICE OF COMMUNITY DEVELOPMENT TOWN OF BELMONT

19 Moore Street Homer Municipal Building Belmont, Massachusetts 02478-0900

Special Permit Application Meeting | 201 Lexington Street

August 15, 2019 (Revised September 19, 2019)

RE: Planning Staff comments for a potential Applicant seeking a Special Permit for a change in use from 1-family to 2-family, and another Special Permit for altering a nonconforming structure in the General Residence Zoning District

Criteria for Granting a Special Permit

It is important to keep in mind as you move forward with the Special Permit process that the standards by which the Planning Board (the Board) must make their decision are outlined in Section 6D.6 of the Zoning By-Law (the By-Law), and in addition to specific performance standards the Board must find that the project is:

- 1. Generally in harmony with the neighborhood; and,
- 2. Neither generates excessive traffic, parking, noise, or density impacts on the abutters, or creates other detrimental effects on the neighborhood.

Case-Specific Red Flag Concerns

The following have been identified by Planning Staff (Staff) as "Red Flag Concerns" and are anticipated to be topics of serious concern for the Board that may impact the probability of receiving approval for the Special Permit.

Proposed Total Livable Area

The Total Livable Area (TLA) is one tool that the Board uses to determine (in a quantifiable way) if a proposed project is more detrimental to the neighborhood than what currently exists. The Board considers the TLA of each project on a case by case basis and does not have a prescribed range that it deems appropriate. Instead, a project's TLA is compared to the surrounding neighborhood to determine if the proposed TLA is comparable to that of the neighborhood.

As existing, 201 Lexington Street has a TLA of 3,099 sf, which is significantly higher than the average home in the surrounding neighborhood. The proposed alterations will increase the TLA of the structure by approximately 2,750 sf. This will bring the TLA to 5,851 sf, which would make this the largest house in the neighborhood.

Additionally, the average TLA for a 2-family home in Belmont is approximately 2,600 sf, which is 3,251 sf less than what is currently proposed.

08.15.2019 (Revised September 19, 2019)

2. Proposed Lot Coverage

The By-Law allows for a maximum lot coverage of 30 percent. The existing lot coverage is 22.9 percent, and the proposed lot coverage is equal to the maximum allowed. Additionally, the existing floor-area-ratio (FAR) is 0.32 and the proposed is 0.61, as compared to the neighborhood average of 0.39.

While the By-Law allows a lot coverage of 30 percent for a by-right project, for Special Permits the Board is required to consider if what is being proposed is "compatible with the surrounding built environment," and does not create "other detrimental effects on the neighborhood." Staff is concerned that the proposal to maximize the lot coverage is a significant hurdle for this project and inconsistent with the neighborhood.

3. Proposed Rear Setback

The existing rear setback is 30.9' and the required rear setback, per the Zoning Compliance Checklist, is 24'. However, the proposed setback is 10.3', which equates to the creation of a new nonconformity. The Board has taken the position that it will not allow the increase to an existing nonconformity nor the creation of a new nonconformity.

4. Proposed Building Height

The existing home is 28.7' tall and the maximum height allowed in this district is 33'. The proposed height of 32.23' is taller than the existing structure and just below the maximum allowed by-right.

Given that the existing structure, which is already determined to be large compared to the neighborhood, is 28.7' tall, Staff strongly recommends that any proposed addition not exceed the existing height.

Staff Recommendation


Staff recommends revising the plans to address/mitigate the above mentioned red flags, and scheduling a follow-up meeting to discuss the revisions prior to moving forward with a Special Permit application.

Case Studies to Consider

Staff reviewed the following case files at the application meeting, and encourages the applicant to also review recordings of these hearings at www.belmontmedia.org:


1. 172 and 174 Lexington Street (approved).

The hearing dates for each can be found on the Planning Board's website at www.belmont-ma.gov/planning-board.

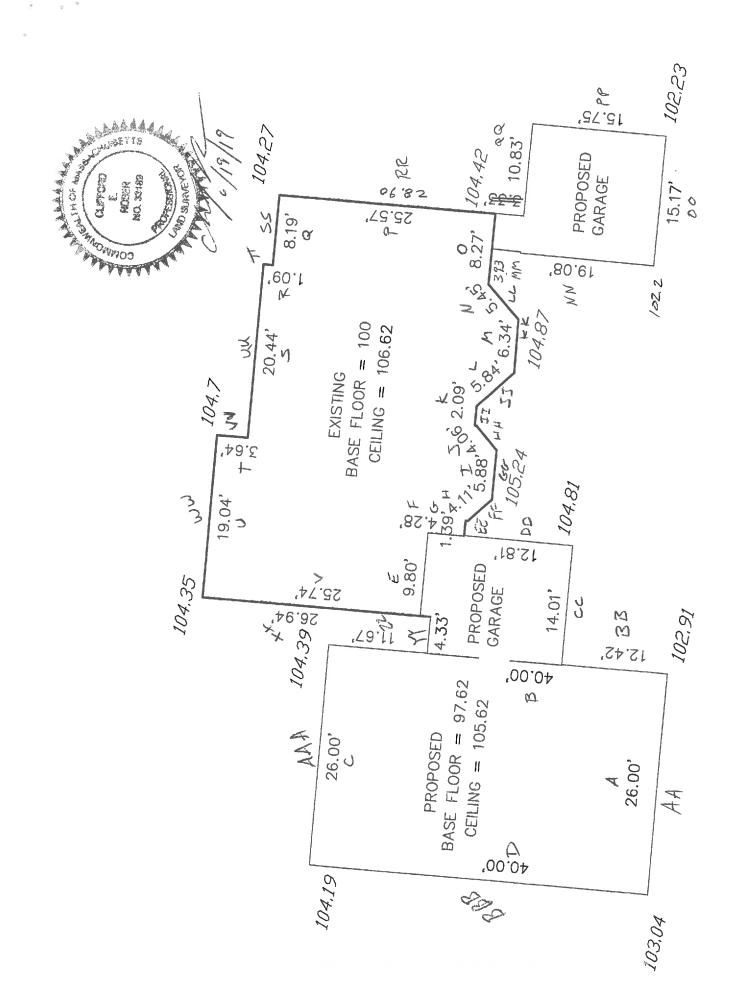

Segment	Ceiling Elevation	Elevation From	Elevation To	Length	Ceiling Height	Square Footage	Exposed Square Footage	8/ C I
A	105.62	103.04	102.91	26,00				% Covered
В	105.62	102.91	104.39					66.94%
С	105.62	104.39	104.19				. 0.00	75.37%
D	105.62	104.19	103.04		•			83.37%
E	105.62	104.39	104.55					74.94%
F	105.62	105.24			•		11.27	85.62%
G	106.62	105.24		1.39	6.62	34.24	1.63	95.25%
H	106.62	105.24	105.24	4.11		9.20	1.92	79.15%
1	106.62	105.24	105.24	5.88	6.62	27.21	5.67	79.15%
1	106.62	105.24	105.24	4.06	6.62	38.93	8.11	79.15%
K	106.62	105.24	104.87	2.09	6.62	26.88	5.60	79.15%
Ł	106.62	104.87	104.87		6.62	13.84	3.27	76.36%
M	106.62	104.87	104.84	5.84	6.62	38.6608	10.22	73.56%
N	106.62	104.87	104.64	6.34	6.62	41.9708	11.1901	73.34%
0	106.62	104.42		5.45	6.62	36.079	10.76375	70.17%
P	106.62	104.42	104.42	8.27	6.62	54.7474	18.194	66.77%
Q	106.62	104.27	104.27	25.57	6.62	169.273	58.17175	65.63%
R	106.62	104.27	104.27	8.19	6.62	54.2178	19.2465	64.50%
S	106.62	104.27	104.27	1.09	6.62	7.22	2.56	64.50%
Т	106.62	104.27	104.7	20.44	6.62	135.313	43.6394	67.75%
บ	106.62		104.7	3.64	6.62	24.0968	6.9888	71.00%
V	106.62	104.7	104.35	19.04	6.62	126.045	39.8888	68.35%
	106.62	104.35	104.39	25.74	6.62	170.399	57.915	66.01%
	100,62			293.22	6.99636	2142.71	578.60	73.00%

Ceiling Height: Basement Floor Elevation Ceiling Elevation Perimeter Total Length Fotal Perimeter Square Foot Exposed Square Footage	6.62 <- enter 100 <- enter 106.62 293.22 2142.71 578.60	North #REF! 0.00 0.00 0.00	South #REF! #REF! 0.00 0.00	#REF! #REF! 0.00	#REF!
6 Covered	73:00% <- result	0.00	0.00	0.00	0.00
		0.00	0.00	0.00	0.00
		0.00	0.00	0.00	0.00
		0.00	0.00	0.00	0.00
		0.00	0.00	0.00	0.00
		0.00	0	0.00%	0.00%

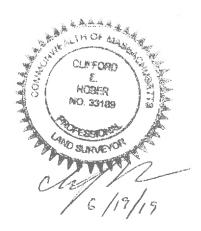

	Security 5		Segment To					
Segment	Segment From Existing Grade		Existing	Segment To	Segment	Ave		
AA		Grade	Grade	New Grade	Length	Existing	Δυσ Νουι	Difference
BB	103.04	103.04	-02.51			_		
CC	102.91	102.71	104.81	104.81	12.42		1289.941	
DD	104.81	104.61	104.81	104.81	14.01	1468.388	1468.388	0.00
EE	104.81	104.61	105.24	105.24	12.81			
FF	105.24 105.24	103.24	105.24	105.24	1.39		146.2836	
GG	105.24	103.24	105.24	105.24	4.11	432.5364	432.5364	0.00
HH	105.24	103.24	105.24	105.24	5.88	618.8112	618.8112	0.00
11	105.24	105.24	105.24	105.24	4.06	427.2744	427.2744	0.00
J.B	104.87	103.24	104.87	104.87	2.09	219.565	219.565	0.00
KK	104.87	104.87	104.87	104.87	5.84	612.4408		0.00
LL	104.87	104.87	104.87	104.87	6.34	664.8758	664.8758	0.00
MM	104.87	104.87	104.87	104.87	5.45	571.5415	571.5415	0.00
NN	104.87	104.87	104.87	104.87	3.93	412.1391	412.1391	0.00
00	102.2	104.87	102.2	102.2	19.08	1975.448	1975.448	0.00
PP	102.23	102.2	102.23	102.23	15.17	1550.602	1550.602	0.00
QQ	104.42	102.23	104.42	104.42	15.75	1627.369	1627.369	0.00
RR	104.42	104.42	104.42	104.42	10.83	1130.869	1130.869	0.00
SS	104.27	104.42	104.27	104.27	28.9	3015.571	3015.571	0
TI.	104.27	104.27	104.27	104.27	8.19	853.9713	853.9713	0
410.	201,21	104.27	104.27	104.27	1.09	113.6543	113.6543	0
UU	104.27	104.27	104.7	104,7				•
VV	104.7	104.7	104.7	104.7	20.44	2135.673		0
WW	104.7	104.7	104.35	104.7	3.64	381.108	381.108	0
XX	104.35	104.35	104.39	104.35	19.04	1990.156	1990.156	0
YY	104.39	104.39	104.39		26.94	2811.728	2811.728	0
ZZ	104.39	104.39	104.39	104.39	4.33	452.0087	452.0087	0
AAA	104.39	104.39	104.19	104.39		1218.231		0
BBB	104.19	104.19	103.04	104.19	26	2711.54	2711.54	0
			103.04	103.04	40	4144.6	4144.6	0
					355.4	36999.05	36999.05	0

Ceiling Height:	6.62
Basement Floor Elevation	100
Ceiling Elevation	106.62
Perimeter Total Length	355.40
Total Perimeter Square Foot	2352.75
Average Existing Grade	104.11
New Average Grade	104.11
Difference in Grade in feet	0.00

% Covered using Avg Grade 62.01%



Zoning Compliance Check List

Properties Located within the GR Zoning Districts (To be Completed by a Registered Land Surveyor)


Property

veyor Signature and Stamp:

Date: 6/19/19

The STATE AS				
**********	Per §	4.2 of the Zonir	ng By-Laws	
-		REQUIRED	EXISTING	PROPOSED
Lot Area (sq. ft.)		7600	9589	
Lot Fronta	ge (feet)	70'	80,00	P-1-1-1-1
Lot Area/L	Init (sq. ft./d.u.)	3500	4794	4794
Lot Covera	age (% of lot)	30	22:9	30.0
Open Spac	ce (% of lot)	40	65.8	63,9
0.15	> Front	20/16.6	30,7/35	1
Setbacks: (feet)	> Side/Side	10"	7.7	21,6
	> Rear	24	30,9	10,3
Building	> Feet	33'	28,7	32.23
Height:	> Stories	21/2	2.1/2	2.1/2
1/2 Story	> Perimeter		-	
(feet)	> Area			•
(Per §1.4)	> Length	·		
	Per §6	D of the Zoning	By-Laws	
		REQUIRED	EXISTING	PROPOSED
-ront	> Face Street			
Doors:	➢ Setback			
Curb Cut	=			
	> Front Yard			
IVAC:	➢ Side/Rear Setbacks			

SUBMIT CALCULATIONS for all of the requirements listed above on a separate piece of paper(s) to verify how they were calculated

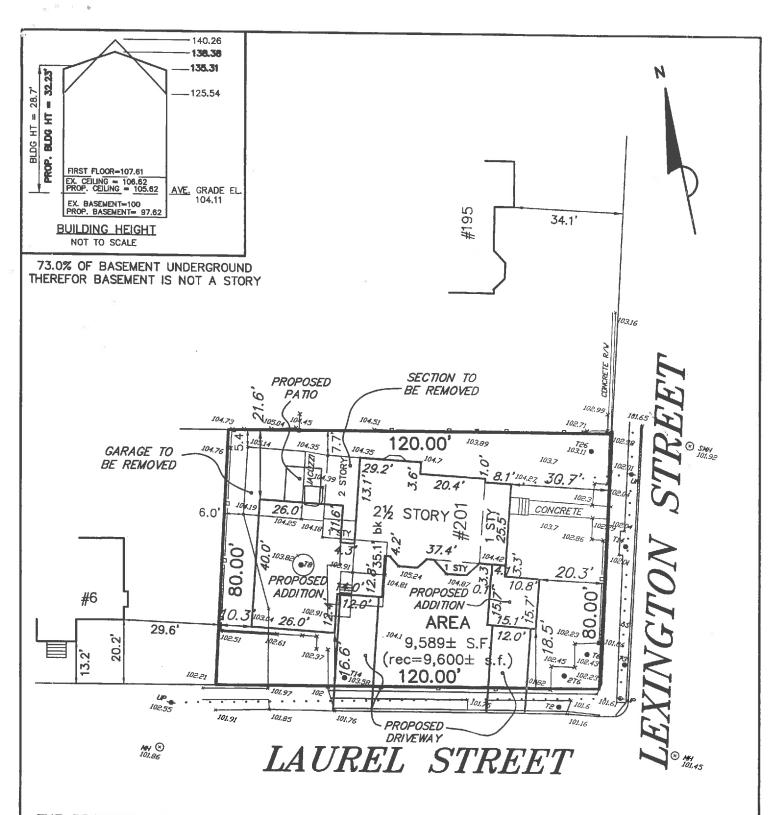

THE PROPERTY IS NOT LOCATED WITHIN WETLANDS AS SHOWN ON THE TOWN OF BELMONT WETLANDS ATLAS.

ZONING DISTRICT: GR (GENERAL RESIDENCE) REQ. PROP. **EXISTING** FRONT S/B (LEXINGTON): FRONT S/B (LAUREL): 20' 30.7 20.3 16.6 35.1' 16.6 SIDE SETBACK: 10' 7.7 21.6 REAR S/B (LEXINGTON): 2420 30.9 10.3 MAXIMUM LOT COVERAGE: 30% 22.9% 30.0% MINIMUM OPEN SPACE: 65.8% 40% 63.9% LOT FRONTAGE: 80.00 TOTAL LOT AREA: 9,589± S.F.

PREPARED FOR: EUGENE KLEIN, III & CHRISTINE ARTHUR 60071/185

ASSESSORS MAP 15 - PARCEL 219

PROPOSED PLOT PLAN #201 LEXINGTON STREET

BELMONT, MA (MIDDLESEX COUNTY)

SCALE: 1"= 30'

0

DATE: 12/14/2017

90 ft

ROBER SURVEY

1072 MASSACHUSETTS AVENUE ARLINGTON, MA 02476 (781) 648-5533 DWG. NO. 5415PP6.DWG

CLIPFORD E. ROBER, PLS


DATE

12

RO

E DM

Swo B.

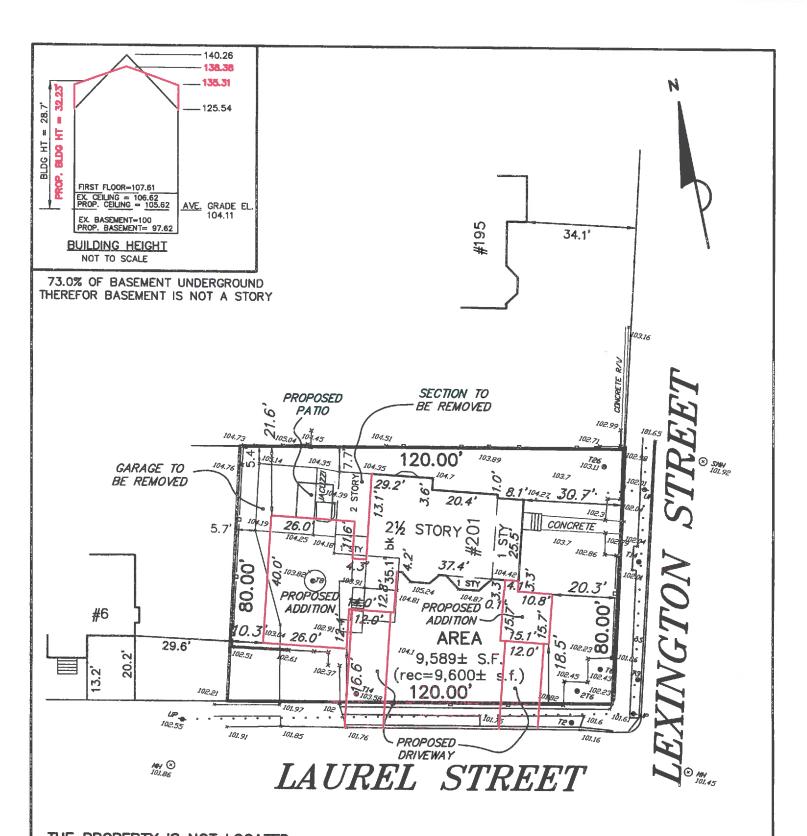

THE PROPERTY IS NOT LOCATED WITHIN WETLANDS AS SHOWN ON THE TOWN OF BELMONT WETLANDS ATLAS.

ZONING DISTRICT: GR (GENERAL RESIDENCE)

REQ. PROP. **EXISTING** FRONT S/B (LEXINGTON): 20' 30.7 20.3 FRONT S/B (LAUREL): 35.1' 16.6 16.6 SIDE SETBACK: 10' 7.7 21.6 REAR S/B (LEXINGTON): 24' 30.6 10.3 MAXIMUM LOT COVERAGE: 30% 22.9% 30.0% MINIMUM OPEN SPACE: 40% 65.8% 63.9%

LOT FRONTAGE:

TOTAL LOT AREA: 9,589± S.F. CLIPPORD E. ROBER RECISTERED STATE 3/11/202

80.00

CLIFFORD E. ROBER, PLS

DATE

PREPARED FOR: EUGENE KLEIN, III & CHRISTINE ARTHUR 60071/185 ASSESSORS MAP 15 - PARCEL 219

PROPOSED PLOT PLAN #201 LEXINGTON STREET

> BELMONT, MA (MIDDLESEX COUNTY)

SCALE: 1"= 30'

O

DATE: 12/14/2017

90 ft

30 60 ROBER SURVEY

1072 MASSACHUSETTS AVENUE ARLINGTON, MA 02476 (781) 648-5533

DWG. NO. 5415PP7.DWG

ZONING: GENERAL RESIDENCE "GR"

MINIMUM LOT AREA 5000 SF
MINIMUM LOT FRONTAGE 50 feet
MAXIMUM LOT COVERAGI30%
MINIMUM OPEN SPACE 40%
GR MINIMUM SETBACK
DIMENSIONS in FEET
Dwelling front: 20 side: 10
rear: 20/.2xL>100' max bldg ht: 35
stories: 2.5

- 1) In the GR District, a minimum lot area of 7,000 square feet and a minimum lot frontage of 70 feet shall exist for a two-family dwelling.
- 5. Notwithstanding the front setback requirement listed in Section 4.2.2, the front setback for the GR District shall not exceed the average of the front setbacks of the buildings on the lots contiguous thereto on either side. A vacant lot, a lot occupied by a building set back more than the required minimum, or an intersecting street shall be counted as though occupied by a building set back at that minimum.
- 6. On lots having depth of less than 100 feet, dwelling setback from the rear lot line shall equal ... not less than 20% of lot depth in General Residence Districts; but in no event shall the rear setback equal less than... 16 feet in General Residence Districts.
- 8. In the GR Districts, on lots having depth of greater than 100 feet, dwelling setback from the rear lot line shall equal 20% of the lot depth.


30% Lot Coverage - Percentage of total lot area covered by structures or roofed.

9,589 SF X.3= 2,876.7 sf **2,874.63 SF AS DESIGNED**

40% Open Space - An open area on a lot, unbuilt on, containing landscape materials, pedestrian walks, patios, recreational facilities, but excluding driveways and parking spaces.

OPEN SPACE: 9,589 sf X.4= 3,835.6 sf or greater: **5,829 SF AS DESIGNED**

SUPER INSULATED ENVELOPE:
R20 BASEMENT WALLS;
R40 WALLS;
R60 ROOF
TRIPLE GLAZED WINDOWS
HEAT PUMP
HEAT RECOVERY VENTILATION
SOLAR PV
LED LIGHTING
INDUCTION COOKTOP
CONVECTION OVEN
ENERGY STAR APPLIANCES

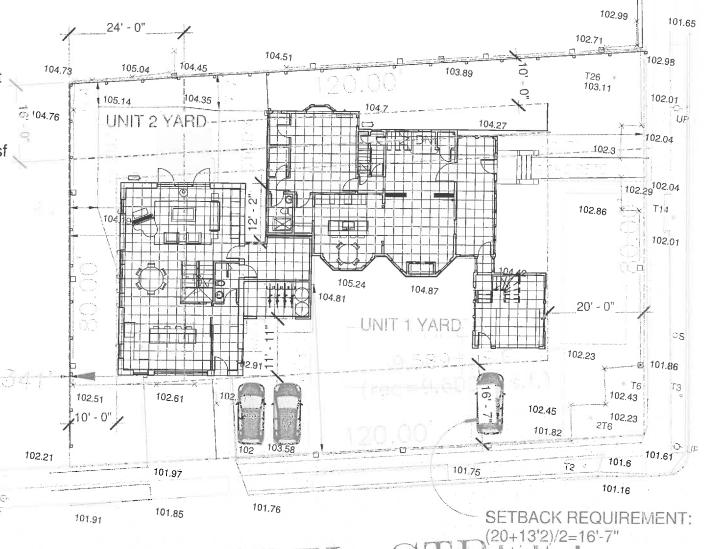

1 1ST FIOOR LOT COVERAGE 1" = 20'-0"

PROJECT SUMMARY: NEW DWELLING UNIT TO LOOK LIKE A "BARN" TO THE EXISTING HOME. NEW GARAGE FOR OLDER HOME.



ARCHITECTURE PLANNING DESIGN

CHRISTINEARTHUR@GMAIL.COM

OWNER

ARTHUR-KLEIN 201 LEXINGTON ST BELMONT MA 02478

DATE:


06/14/2019

SPECIAL PERMIT SET

TITLE

GENERAL INFORMATION

DWG NO

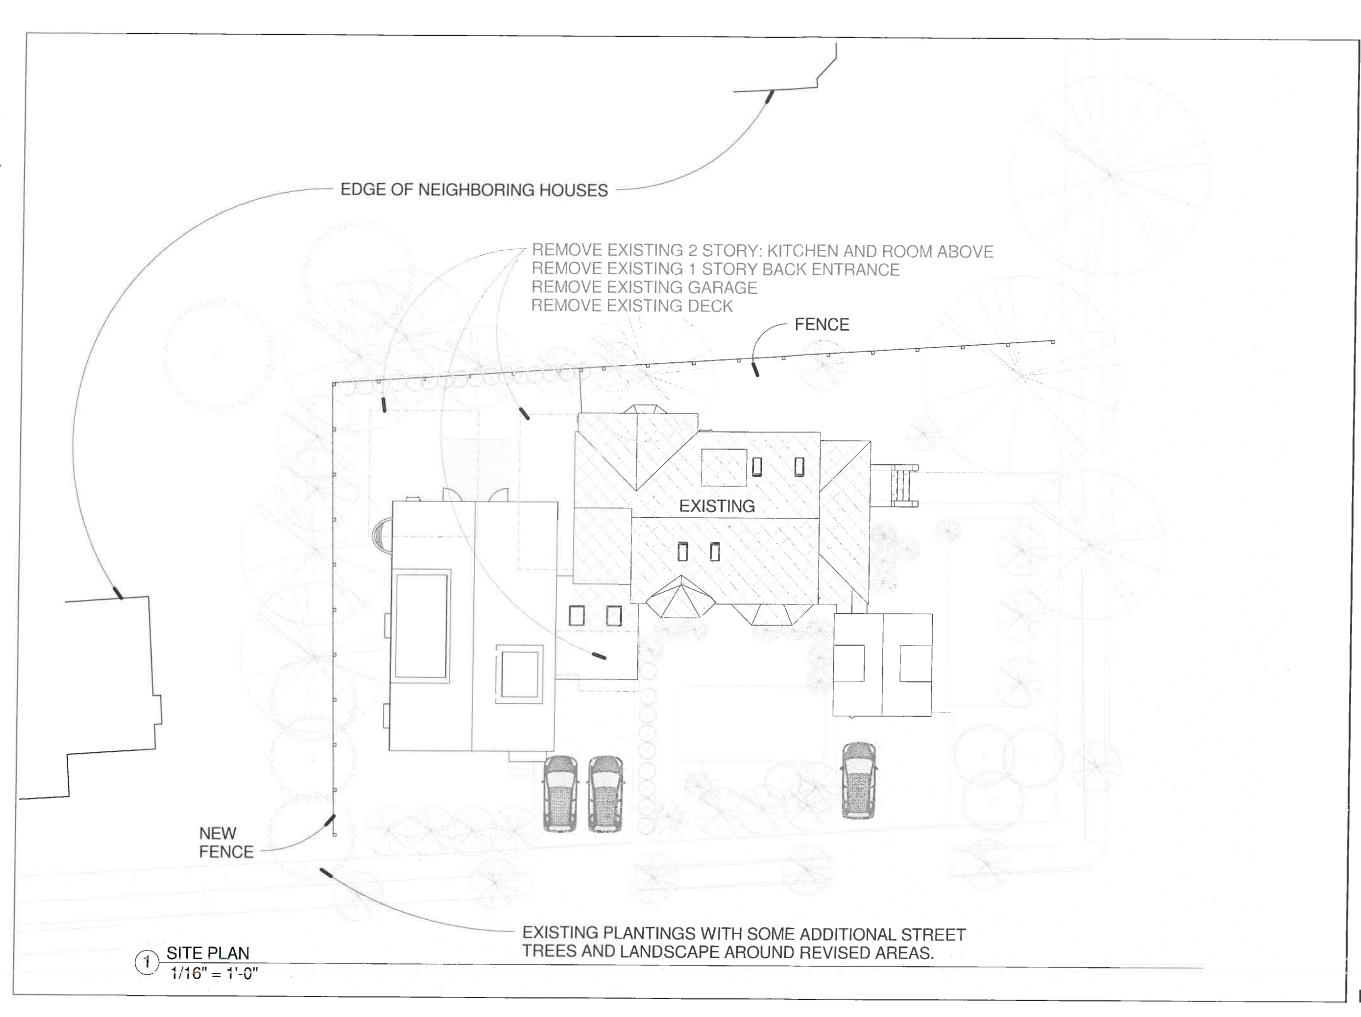



DA DESIGN STUDIO ELC

ARCHITECTURE PLANNING DESIGN

CHRISTINEARTHUR@GMAIL.COM

OWNER

ARTHUR-KLEIN
201 LEXINGTON ST
BELMONT MA
02478

DATE:

06/14/2019


SPECIAL PERMIT SET

TITLE

SITE PLAN/ ROOF PLAN

DWG NO

A₁

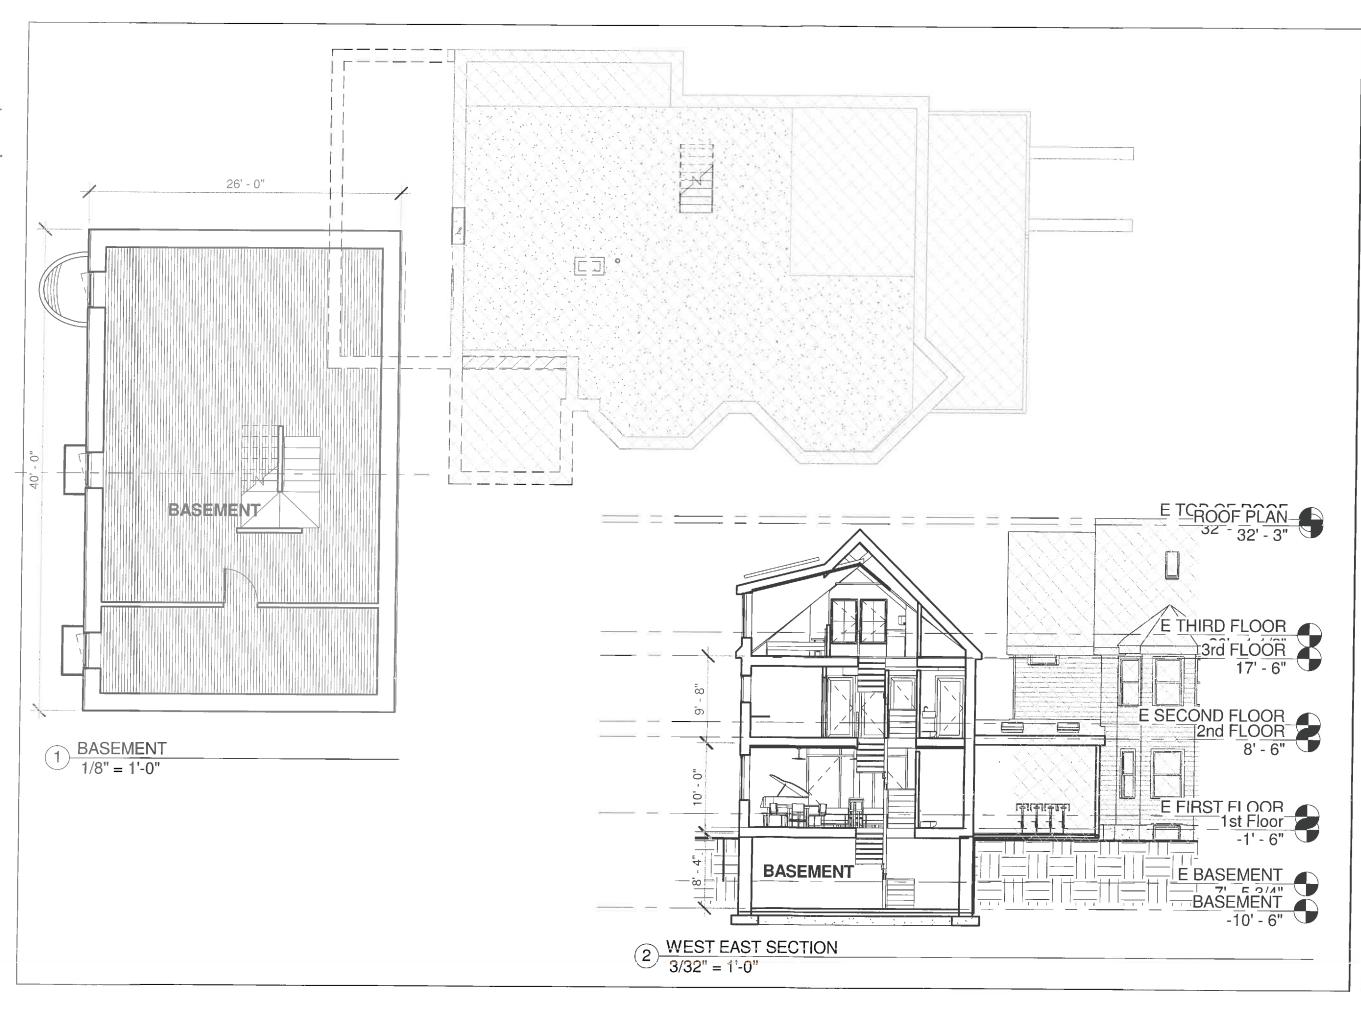



ARCHITECTURE PLANNING DESIGN

CHRISTINEARTHUR@GMAIL.COM

OWNER

ARTHUR-KLEIN 201 LEXINGTON ST BELMONT MA 02478

DATE:


06/14/2019

SPECIAL PERMIT SET

TITLE

BASEMENT AND BARN SECTION

DWG NO

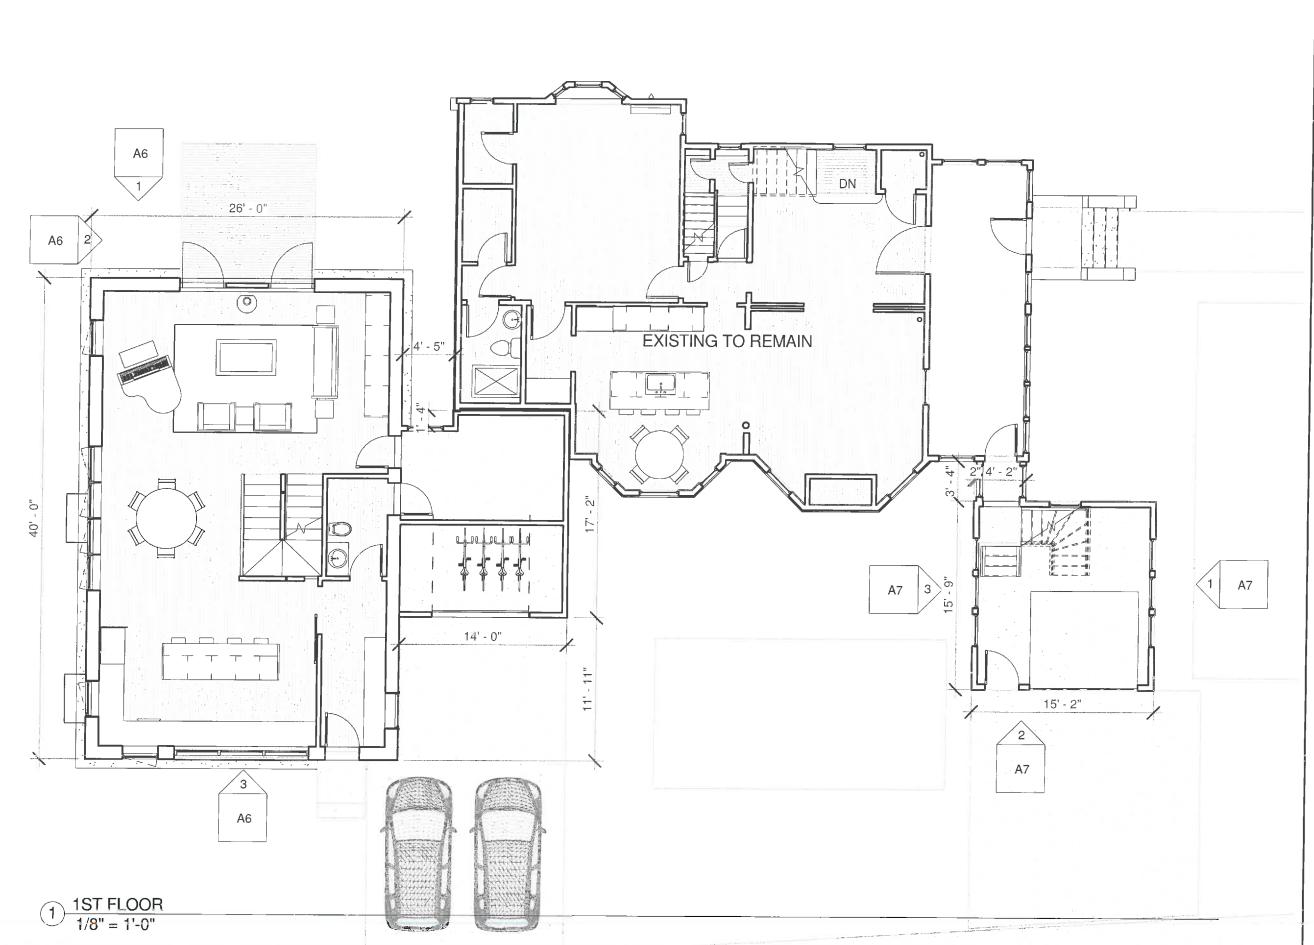



CA DESIGN STUDIO LLC

ARCHITECTURE PLANNING DESIGN

CHRISTINEARTHUR@GMAIL.COM

OWNER

ARTHUR-KLEIN 201 LEXINGTON ST BELMONT MA 02478

DATE:


06/14/2019

SPECIAL PERMIT SET

TITLE

FIRST FLOOR PLAN

DWG NO

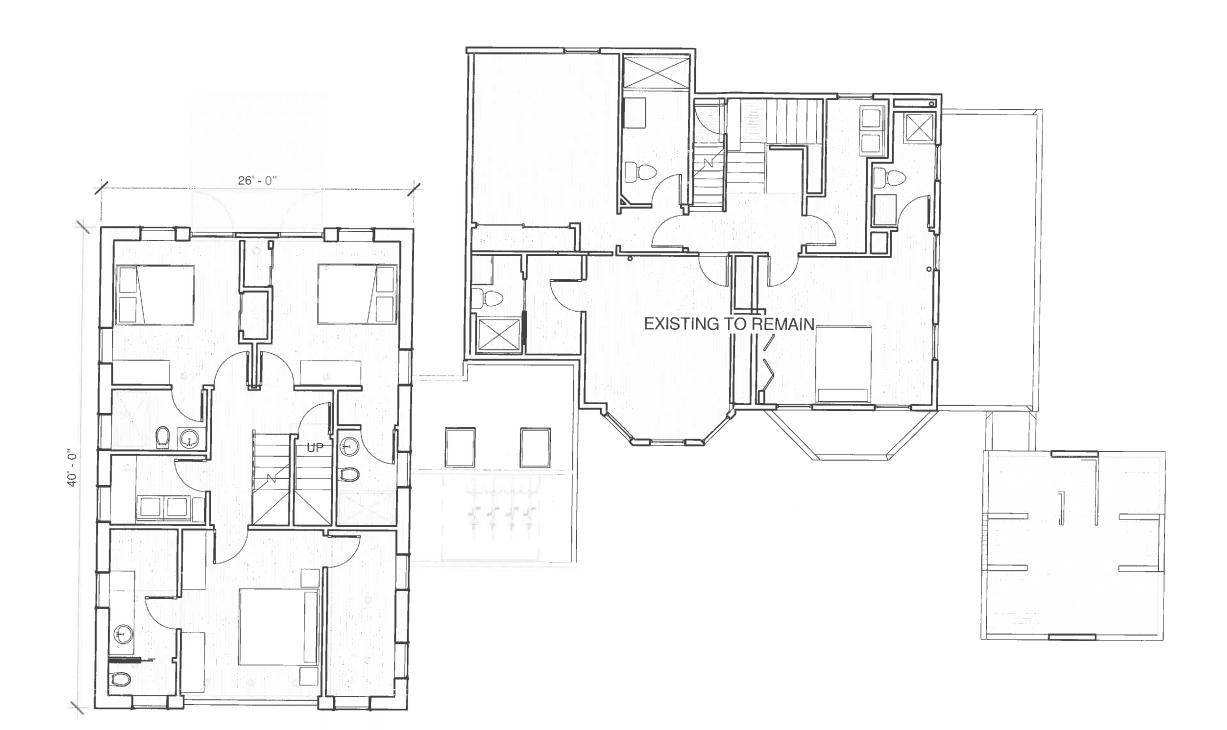



ARCHITECTURE PLANNING DESIGN

CHRISTINEARTHUR@GMAIL.COM

OWNER

ARTHUR-KLEIN 201 LEXINGTON ST **BELMONT MA** 02478

DATE:

06/14/2019


SPECIAL PERMIT SET

TITLE

SECOND FLOOR PLAN

DWG NO

2nd FLOOR 1/8" = 1'-0"

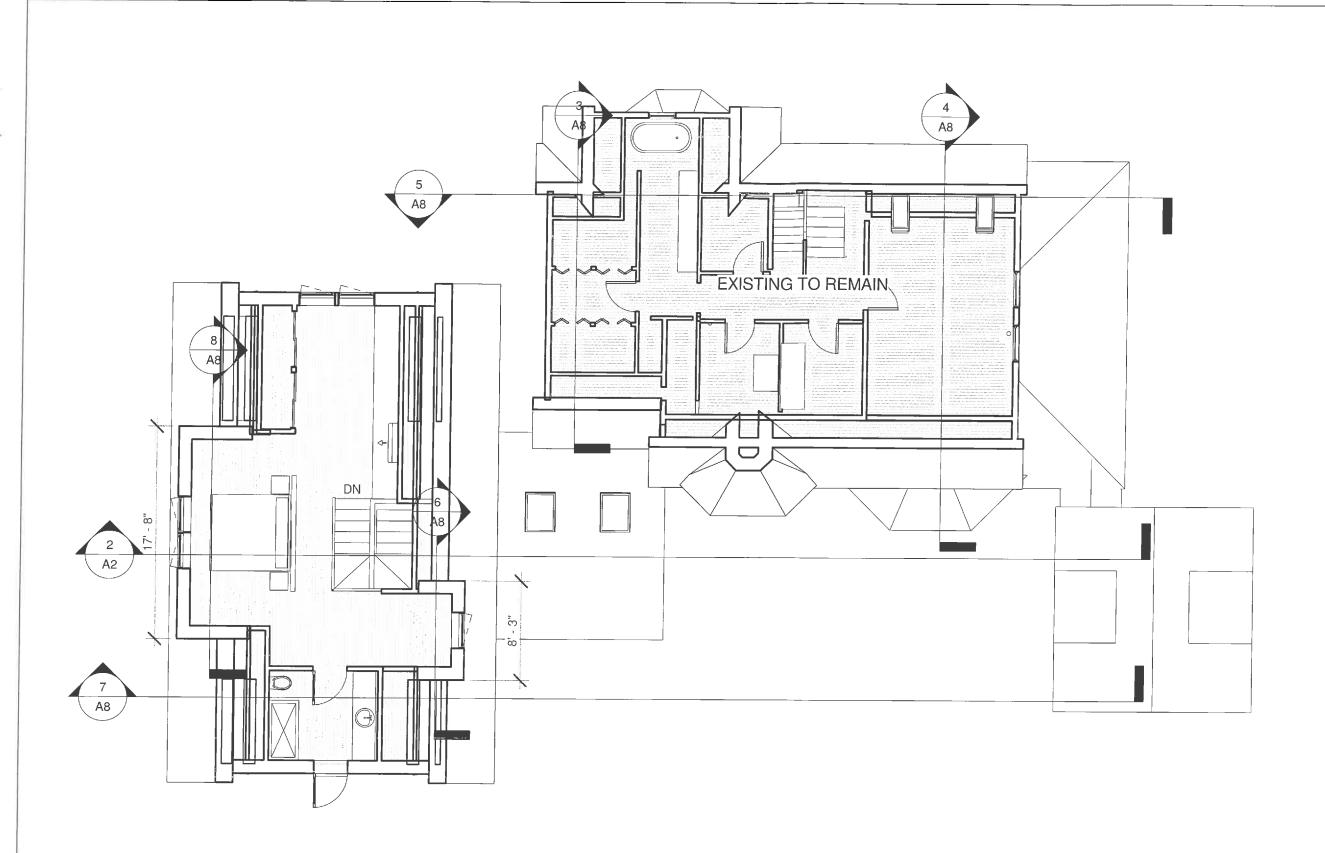



CA DESIGN STUDIO LLO

ARCHITECTURE PLANNING DESIGN

CHRISTINEARTHUR@GMAIL.COM

OWNER

ARTHUR-KLEIN
201 LEXINGTON ST
BELMONT MA
02478

DATE:

06/14/2019

SPECIAL PERMIT SET

TITLE

THIRD FLOOR PLAN

DWG NO

A5

1 3rd FLOOR 1/8" = 1'-0"





CA DESIGN STUDIO LLC

ARCHITECTURE PLANNING DESIGN

CHRISTINEARTHUR@GMAIL.COM

OWNER

ARTHUR-KLEIN 201 LEXINGTON ST BELMONT MA 02478

DATE:

10/30/18

SPECIAL PERMIT SET

TITLE

BARN ELEVATIONS

DWG NO









5 VIEW FROM LAUREL ST 12" = 1'-0" Δ

CA DESIGN STUDIO LLC

ARCHITECTURE PLANNING DESIGN

CHRISTINEARTHUR@GMAIL.COM

OWNER

ARTHUR-KLEIN 201 LEXINGTON ST BELMONT MA 02478

DATE:


10/30/18


SPECIAL PERMIT SET

TITLE

GARAGE ELEV AND PROJECT VIGNETTES

DWG NO

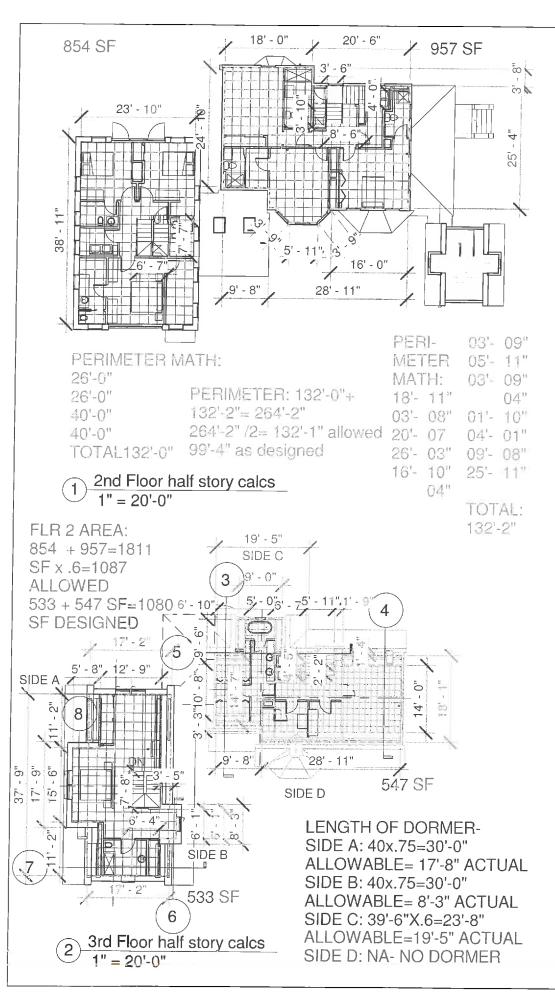

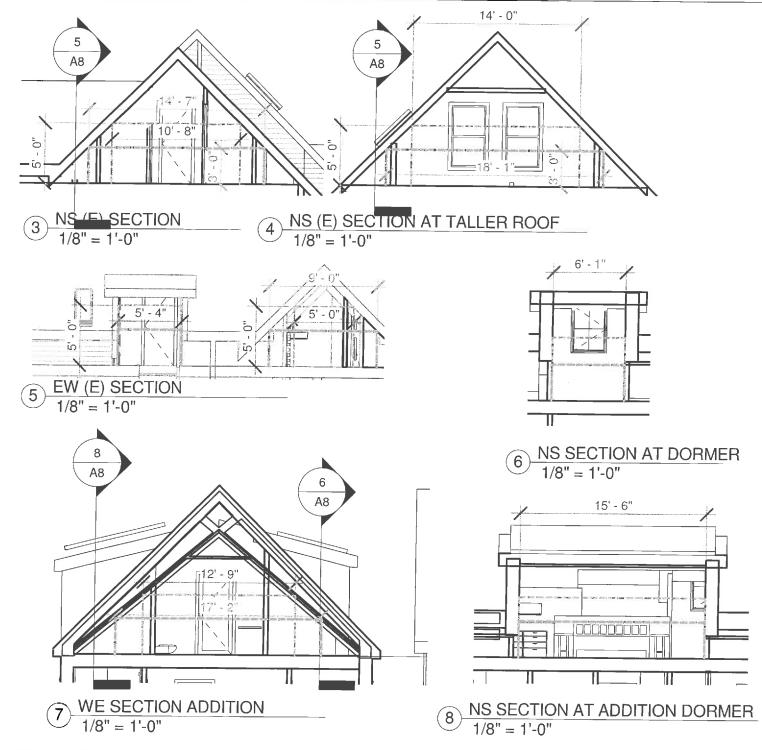

Story, Half - A space under a sloping roof where:

- a) the line of intersection of the rafter bottoms and the interior wall surface is not more than three feet above floor level on at least half the perimeter of the second floor,
- b) the potential space having headroom of five feet or more is not more than 60% as large as the second floor,
- c) provided that the length of any dormer does not exceed 75% of the length of the roofline of the side of the structure where the dormer is constructed, and
- d) for purposes of this calculation, when the height of the second floor is indeterminate, the height of the second floor (from finished floor to finished ceiling) shall be equal to 12 feet, the remaining portion of the wall shall be factored into the half-story calculation.



CA DESIGN STUDIO LLC

ARCHITECTURE PLANNING DESIGN

CHRISTINEARTHUR@GMAIL.COM

OWNER

ARTHUR-KLEIN 201 LEXINGTON ST BELMONT MA 02478

DATE:

06142019

SPECIAL PERMIT SET

TITLE

HALF STORY CALCS

DWG NO