Special Permit - SRC January 16, 2020 Page 7



Town of Belmont Planning Board

APPLICATION FOR A SPECIAL PERMIT

Date:	October	5,	2020	

Planning Board Homer Municipal Building 19 Moore Street Belmont, MA 02478

To Whom It May Concern:

Pursuant to the provisions of Massachusetts General Laws, Chapter 40A,
Section 9, as amended, and the Zoning By-Law of the Town of Belmont, I/we the
undersigned, being the owner(s) of a certain parcel of land (with the buildings thereon)
situated on 28 Pierce Road Street/Road, hereby apply to your Board
for a SPECIAL PERMIT for the erection or alteration on said premises or the use
thereof under the applicable Section of the Zoning By-Law of said Town for
the expansion of the existing single family residence via multiple additions. See
attached description in narrative statement. The existing structure has a side setback of
8.1 feet.
on the ground that the same will be in harmony with the general purpose and intent of
said Zoning By-Law.
Signature of Petitioner Jonatha S. Butt
Print Name Tongthan F. Britt
Address 28 Pierce Road
Belmont, MA 02478
Daytime Telephone Number 617 - 484 - 3749



OFFICE OF COMMUNITY DEVELOPMENT TOWN OF BELMONT

19 Moore Street Homer Municipal Building Belmont, Massachusetts 02478-0900

Telephone: (617) 993-2650 Fax: (617) 993-2651

Building Division (617) 993-2664 **Engineering Division** (617) 993-2665 Planning Division (617) 993-2666

August 31, 2020 (Revised)

Mr. Jonathan and Ms. Michele Britt 28 Pierce Road Belmont, MA 02478

RE:

Denial to Construct a Second Story above the Garage and a Two-Story Addition at the Rear of the Home at 28 Pierce Road

Dear Mr. and Ms. Britt

The Office of Community Development is in receipt of your building permit application for the construction of a second story above the garage and a two-story addition at the rear of the home at 28 Pierce Road in a Single Residence C (SR-C) Zoning District.

Your application has been denied because it does not comply with the Zoning By-Law. More specifically, your property does not conform to the side setback requirement and is therefore considered nonconforming (allowed 10.0'; existing and proposed 8.1').

You may alter your plans to conform to the Zoning By-Law and resubmit for a building permit or you may request two Special Permits from the Planning Board to (1) maintain the side setback and (2) increase the size of your home by more than 30% of the gross floor area. If you choose to pursue the Special Permits, please call the Office of Community Development at (617)-993-2666 to schedule an appointment with the Planning Staff to begin the process.

Sincerely,

Glenn R. Clancy, P.E.

Inspector of Buildings

3. Narrative Statement describing the proposal for 28 Pierce Road

We, Jonathan and Michele Britt, are writing to request that the Belmont Planning Board approve our application for a special permit to increase our non-conforming structure by more than 30% of the gross floor area. Our property, located at 28 Pierce Road, is deemed a non-conforming structure on account of the existing garage wall being 8.1 feet from the property line, which does not meet the current ten-foot side setback zoning requirement.

Michele is a lifelong resident of Belmont. Other than attending college, she has not lived anywhere else. We purchased our home in June 2004 from Frederick Mosteller, the original owner, just eight months after being married. The property is a three bedroom and 2 ½ bath center entrance colonial with 1,788 square foot TLA on a 9,832 square foot lot (Town records). The Walnut Hill neighborhood is special to us because Michele's father and grandfather both grew up here.

We dreamed of raising a family in the same neighborhood where Michele's family has its roots, but life took a few unexpected turns. Now sixteen years later we are both working from home and using each bedroom as a partial home office. Michele's job was full-time remote before the coronavirus pandemic, and Jonathan's employer has a generous teleworking policy, so office space is a long-term need for our family. Furthermore, we are currently making plans for Jonathan's parents to move in with us.

The house was built in 1949 and since that time there have been no discernable renovations or upgrades. We have been working with a local Cambridge architect to: bring modern technology to our 71 year old home; create a space that will suit our immediate and long-term needs; design a structure that will blend well with the existing conditions; and to provide a home where extended family can gather for memorable get-togethers. Jonathan's sister, brother-in-law, and their four children live in mid Maine and visit regularly. With Jonathan's parents planning to move into our home in the future, these visits are expected to become more frequent.

The proposed renovations to 28 Pierce Road consist of four aspects: adding a nine-foot deep single-story addition to the rear of the house; adding a fourth bedroom to the second floor; extending the garage bays; and adding an attic dormer.

Nine-foot addition – There exists a 9' x 12.5' covered porch on the back of our house. We would like to enclose this as living area and expand this space across the back of the house (453 square feet), as an open floor plan concept. This added space on the rear of the house will: expand our current 10' x 10' family room (at the top of the cellar stairs) so that our larger / growing family can gather in one space; expand our 11' x14' kitchen to include an island and eating area for our family; and include a mud room with direct access to the garage. We currently step outside to access the garage. This single-story addition will have negligible effects on the rear abutter. Not only does the existing covered porch have a similar footprint as the proposed addition, there is

mature landscaping along the rear property line, including fifteen-foot-tall hemlocks, that hamper the rear abutter from seeing our house. See attached photos.

Fourth bedroom – We need an additional bedroom to accommodate Jonathan's parents when they downsize and move in with us. We are proposing to add a bedroom over the first-floor garage and mudroom (757 square feet). We considered developing over the first-floor rear addition to reduce costs but extending the current hallway to the garage wall is a better design and room layout. The second-floor bedroom walls align with the garage and mudroom walls on the first floor. If first and second floor walls do not align, special structural considerations are needed to support the ridge. The proposed addition introduces a new gable facing Pierce Road which breaks up the massing ridge and introduces visual interest. The overall effect is in harmony with the architecture and scale of the neighborhood. Smaller bedroom windows facing the abutter, located above the bed, were chosen to preserve privacy. This garage area of the property is heavily shaded from mature trees. Adding a second story to the garage will minimally impact the natural lighting to the side abutter. See attached photo.

Extending garage – In order for Jonathan's 2017 GMC pickup truck to fit inside the garage, additional space is needed. We are proposing to add six feet to each garage bay (112 square feet), and to have the outside wall be at the 8.1 foot setback so that the deeper bay is functional. Extending the rear of the garage will not be seen by the abutter due to an existing retaining wall combined with an existing six-foot fence that blocks their view of the garage at ground level. See attached photo.

Attic Dormer – We are proposing to add an attic dormer on to the rear of the house (260 square feet) for unfinished attic storage. The existing ridge allows a four-foot-wide area that has 6'6" head room clearance. Jonathan is excessively tall. More head room is needed so that he can access other parts of the attic with ease. The walk-up attic stairs hinder access to half of the eaves along the front of the house, shifting most storage space towards the rear. Because there are at least five (5) homes in our immediate area that have rear attic dormers (including front and rear abutters), adding an attic dormer is in characteristic of the neighborhood. See attached photos showing attic dormers on neighboring structures. See attached list of addresses that have dormers.

Other renovations – The forced hot air heating system will be upgraded. The existing one zone of heat servicing the entire house is inadequate and inefficient. Central air conditioning units will be added. The units' location meet the Town guidelines. The oil furnace will be replaced with a gas furnace. The chimney in the center of the house will be removed, and replaced with a first-floor bath, and a second-floor closet. The existing 6' x 9' master bath will become a second-floor laundry room. The existing bulkhead to the cellar will be moved to behind the mudroom.

The property is well landscaped, with a lush, green lawn. We intend to keep as much of the existing landscaping as possible. Plant and shrub descriptions, and location, are identified on the landscaping plan. Bushes that are damaged from construction will be replaced.

Jonathan worked with Jeffrey Wheeler on which streets are considered part of the Pierce Road Neighborhood. Mr. Wheeler explained how a neighborhood is determined, and provided a list of addresses, including property statistics, that pertain to the neighborhood relevant 28 Pierce Road.


The proposed design adds 1,222 square feet of finished living space to the existing home, leading to a 3,028 square foot house that will compliment nicely to the Pierce Road neighborhood. The proposed renovations have been designed to reflect the architectural character of the neighborhood and are consistent with renovations to nearby homes. The proposed design is in harmony with the neighborhood vernacular, and the size of the proposed home is consistent with one third of houses on Pierce road, and many in the neighborhood. Photos of the surrounding properties are included, along with similar properties in the neighborhood. The proposed design is in keeping with the intent of Town Meeting and the Planning Board Special permit criteria (Section 1.5.4.B) and is not substantially detrimental to the neighborhood.

We have shared our ideas with our immediate neighbors and received enthusiastic support. We will be providing a signed petition demonstrating neighborhood support.

We look forward to creating a house and home that is an asset to the Town and that complements the neighborhood. Thank you for consideration on this matter.

9. Additional Material


- Page 1 28 Pierce Road Front artist rendition before & after
- Page 2 28 Pierce Road Rear artist rendition before & after
- Page 3 28 Pierce Road Front picture and side along Brettwood Road picture
- Page 4 28 Pierce Road backyard. Can not see rear abutter (55 Hastings Road)
- Page 5 28 Pierce Road side / rear, existing 9' x 12.5' porch, far abutter tree(s)
- Page 6 Abutter 22 Pierce Rd side yard in shade, and 28 Pierce Rd garage not visible due to wall and six ft fence
- Page 7 Abutter 22 Pierce Road rear bedroom window aligns with 28 Pierce garages.
- Page 8 28 Pierce Rd artist rendition of garage / master bedroom side showing windows 28 Pierce Rd view from driveway towards 48 Brettwood Rd
- Page 9 48 Brettwood Rd across the street from 28 Pierce Rd
- Page 10 22 Pierce Rd side abutter to 28 Pierce Rd
- Page 11 55 Hastings Rd rear abutter to 28 Pierce Rd
- Page 12 Pierce Rd street view
- Page 13 -17 Pierce Road diagonally across from 28 Pierce Rd
- Page 14 8 Pierce Road third house from 28 Pierce Rd. FAR = 0.37
- Page 15 18 Hastings Road FAR = 0.49
- Page 16 41 Homer Road FAR = 0.36
- Page 17 47 Homer Road FAR = 0.29
- Page 18 44 Hastings Road FAR = 0.33
- Page 19 48 Hastings Road developed over the garage. FAR 0.308
- Page 20 28 Homer Road developed over the garage, and dormer
- Page 21 81 Brettwood Road developed over the garage
- Page 22 69 Brettwood road across Brettwood Rd from 28 Pierce Rd side yard
- Page 23 List of addresses that developed over the garage
- Page 24 List of addresses that have dormers
- Page 25 List of addresses sorted by FAR

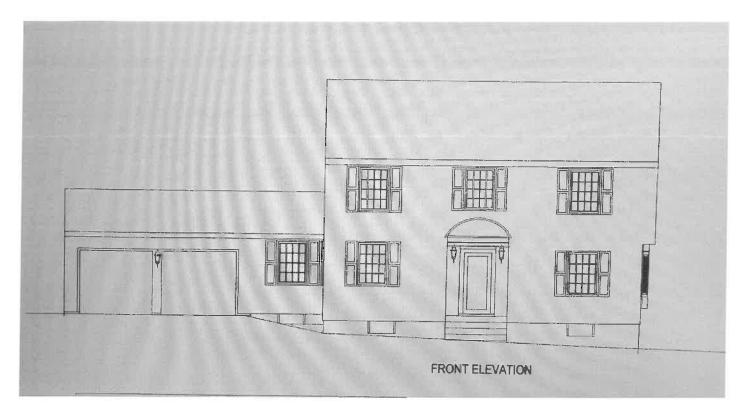


28 Pierce Road Front – artist rendition before and after



Page 1

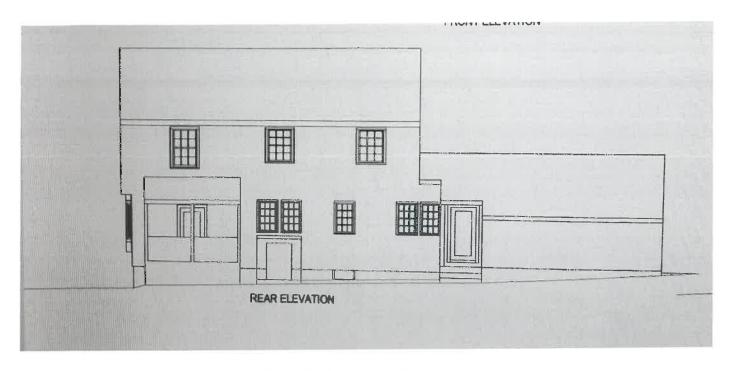


28 Pierce Road Rear – artist rendition before and after

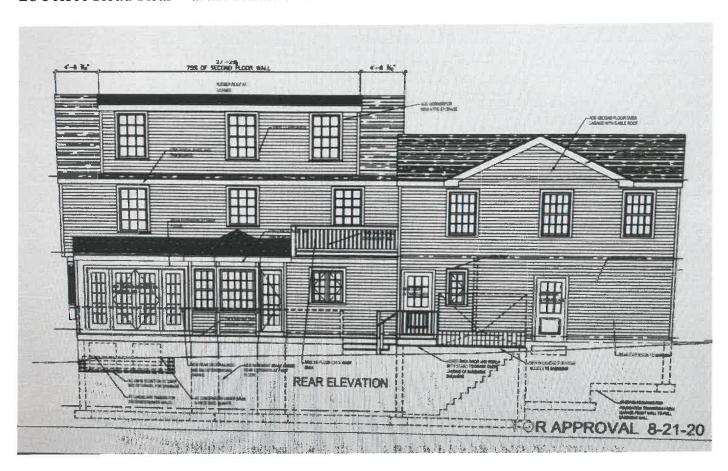



28 Pierce Road Front and side along Brettwood Road. Can not see rear abutter.



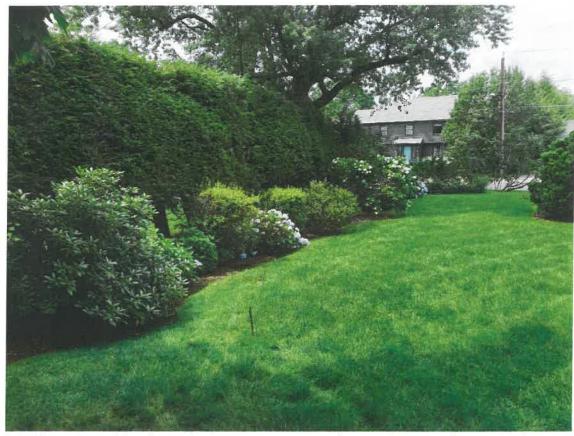

28 Pierce Road backyard. Can not see rear abutter (55 Hastings Road)





28 Pierce Road – Brettwood Road side & rear. Can not see rear abutter through tall tree 28 Pierce Road – existing 9' x 12.5' porch. Far abutter dense tree(s)







22 Pierce Road (abutter) side yard in shade

28 Pierce Rd garage (rear corner shown) not visible to abutter due to wall and six foot fence




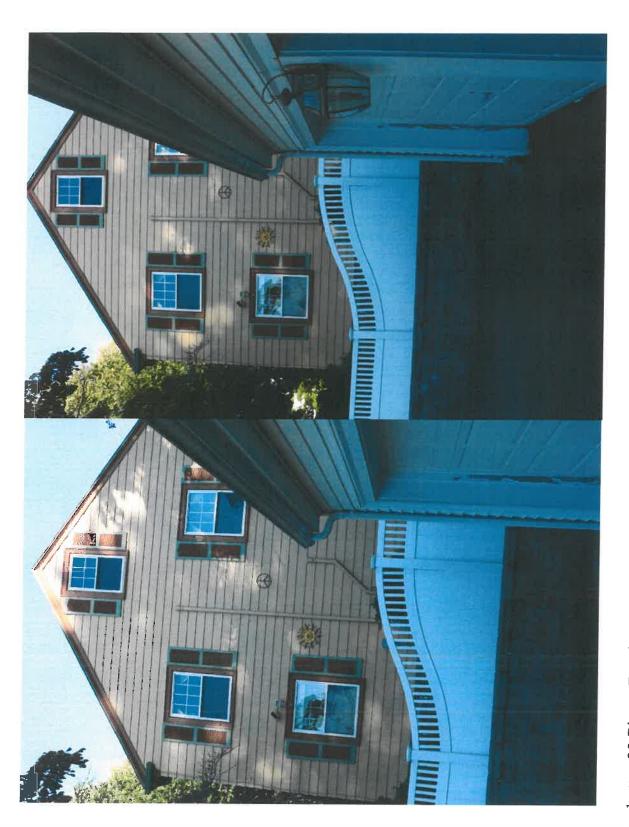

Side abutter 22 Pierce Road - rear bedroom window aligns with front corner of 28 Pierce garage

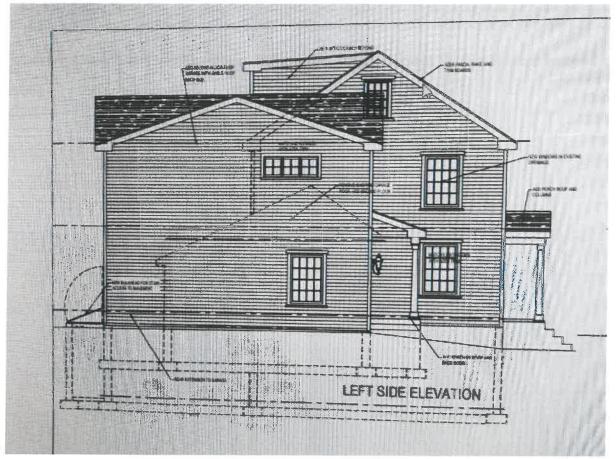

28 Pierce Rd artist rendition of left garage & master bedroom side. Bedroom windows were designed to be smaller and above the bed to preserve privacy with side abutter.

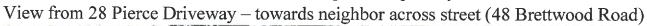





48 Brettwood Rd (across from 28 Pierce)
5 bedrooms 3,038 sq ft TLA 11,591 sq ft lot FAR 0.26





22 Pierce Road – side abutter to 28 Pierce Road 4 bedrooms 2,072 sq ft TLA 8,075 sq ft lot

FAR 0.26





55 Hastings Road – rear abutter to 28 Pierce Road 3 bedrooms 1,851 sq ft TLA 11,594 sq ft lot FAR 0.16



In front of 28 Pierce Rd – looking towards Homer Road



In front of 28 Pierce Rd – looking towards Brettwood Road





17 Pierce Road diagonally across from 28 Pierce. Aerial photo from Google Maps 5 bedrooms 3,080 sq ft TLA 9,168 sq ft lot FAR 0.34





8 Pierce Road (third house from 28 Pierce). Photos from Google Maps 4 bedrooms 2,985 sq ft TLA 8,075 sq ft lot FAR 0.37






18 Hastings Road. Aerial photo from Google Maps 4 bedrooms 5,119 sq ft TLA 10,367 sq ft lot FAR 0.49





41 Homer Road. Aerial photo from Google Map
5 bedrooms 3,527 sq ft TLA 9,682 sq ft lot FAR 0.36

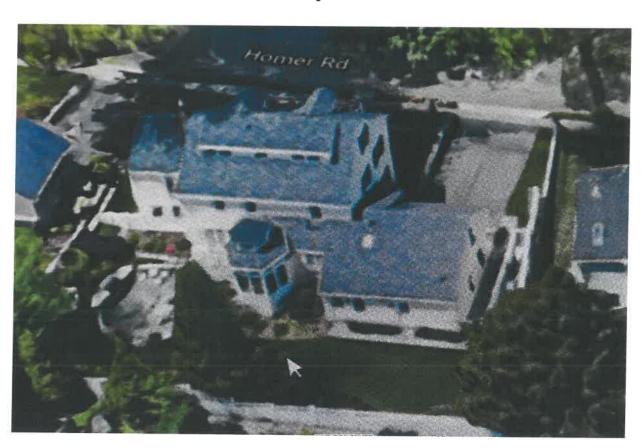



47 Homer Road. Aerial photo of 41 & 47 Homer Rd from Google Maps 4 bedrooms 2,980 sq ft TLA 10,178 sq ft lot FAR 0.29





44 Hastings Road. Photos from Google Maps 4 bedrooms 2,772 sq ft TLA 8,522 sq ft lot



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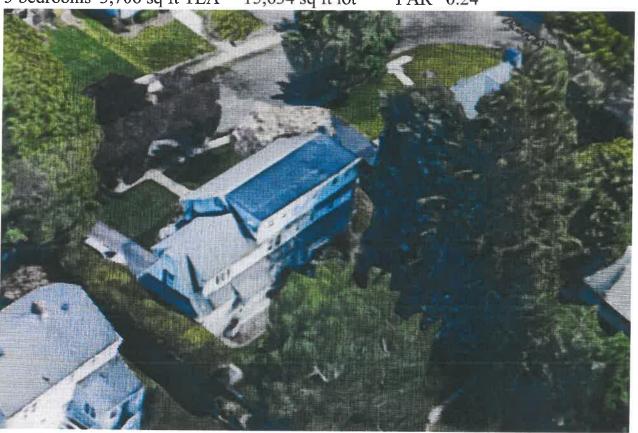
48 Hastings Road. Photos from Google Maps 4 bedrooms 2,633 sq ft TLA 8,540 sq ft lot

FAR 0.308






28 Homer Road. Photos from Google Maps
5 bedrooms 3,706 sq ft TLA 15,634 sq ft lot FAR 0.24





81 Brettwood Road. Photos from Google Maps 5 bedrooms 2,773 sq ft TLA 11,929 sq ft lot FAR 0.23

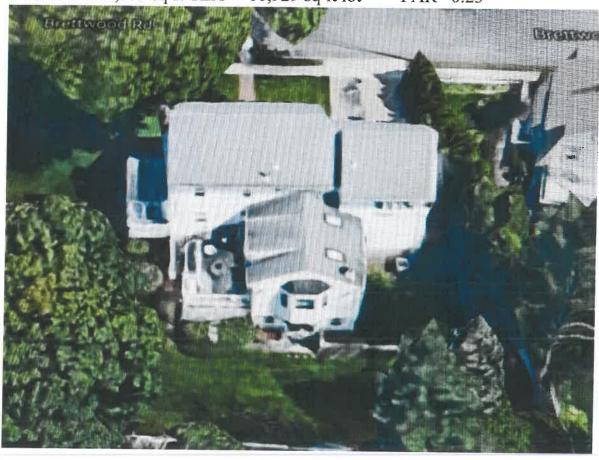



69 Brettwood Road. Aerial photo from Google Maps
3 bedrooms 2,343 sq ft TLA 9,633 sq ft lot FAR 0.24



Addresses that developed over the garage:

- 17 Brettwood Road
- 81 Brettwood Road
- 18 Hastings Road
- 23 Homer Road
- 28 Homer Road
- 48 Hastings Road

			28	Pierce Ro	ad				
			List of Addre	sses That H	ave Dorme	rs			
map	Address	USE	LOT	TLA	FAR	BED	STORIES	YEAR BUILT	DORMER 3
17-66	12 BRETTWOOD RD	101	10,683	1,998	0.1870	3	1.75	1950	Yes
17-63	17 BRETTWOOD RD	101	10,500	3,234	0.3080	4	2	1932	Yes
17-83	28 BRETTWOOD RD	101	9,928	2,686	0.2705	4	1.5	1953	Yes
17-84	36 BRETTWOOD RD	101	12,242	2,805	0.2291	4	1.5	1950	Yes
17-85	48 BRETTWOOD RD	101	11,591	3,038	0.2621	5	1.75	1950	Yes
17-58	51 BRETTWOOD RD	101	9,000	1,542	0.1713	2		1950	Yes
17-81	239 COMMON ST	101	11,787	3,638	0.3086	5		1915	Yes
17-76	279 COMMON ST	101	10,256	2,384	0.2324	5		1947	Yes
17-75	285 COMMON ST	101	10,459	2,383	0.2278	3		1948	Yes
17-121	18 HASTINGS RD	101	10,367	5,119	0.4938	4		2010	Yes
17-73	21 HASTINGS RD	101	13,030	3,014	0.2313	5		1938	Yes
17-122	24 HASTINGS RD	101	9,183	2,382	0.2594	4		1938	Yes
17-126	48 HASTINGS RD	101	8,540	2,633	0.3083	4		1948	Yes
17-127	52 HASTINGS RD	101	8,221	1,727	0.2101	4		1953	Yes
17-91	55 HASTINGS RD	101	11,594	1,851	0.1597	3		1949	Yes
17-128	58 HASTINGS RD	101	9,831	2,509	0.2552	4		1953	Yes
17-71	15 HOMER RD	101	8,956	2,162	0.2414	3		1945	Yes
17-89	28 HOMER RD	101	15,634	3,706	0.2370	5		1941	Yes
17-70	29 HOMER RD	101	9,352	2,555	0.2732			1928	Yes
17-68	41 HOMER RD	101	9,692	3,527	0.3639	5		1940	Yes
17-67	47 HOMER RD	101	10,178	2,980	0.2928	4		1940	Yes

Average 10,231 2,519 0.250 4 2

			28 Pie	rce Road				
List of Addresses sorted by FAR								
тар	Address	USE	LOT	TLA	FAR	BED	STORIES	YEAR_BUILT
17-121	18 HASTINGS RD	101	10,367	5,119	0.4938	4	2.5	2010
17-97	8 PIERCE RD	101	8,075	2,985	0.3697	4	2	1940
17-68	41 HOMER RD	101	9,692	3,527	0.3639	5	2.5	1940
17-86	17 PIERCE RD	101	9,168	3,080	0.3360	5	2	1930
17-125	44 HASTINGS RD	101	8,522	2,772	0.3253	4	2	1938
17-82	22 BRETTWOOD RD	101	10,864	3,442	0.3168	5	2	1941
17-123	30 HASTINGS RD	101	8,558	2,656	0.3104	4	2	1935
17-81	239 COMMON ST	101	11,787	3,638	0.3086	5	2	1915
17-126	48 HASTINGS RD	101	8,540	2,633	0.3083	4	2	1948
17-63	17 BRETTWOOD RD	101	10,500	3,234	0.3080	4	2	1932
17-100	28 PIERCE RD renovated	101	9,832	3,028	0.3080	4	2	1949
17-67	47 HOMER RD	101	10,178	2,980	0.2928	4	2	1940
17-61	31 BRETTWOOD RD	101	9,000	2,555	0.2839	5	2	1950
17-65	227 COMMON ST	101	10,536	2,991	0.2839	3	2	1935
17-69	33 HOMER RD	101	9,566	2,669	0.2790	4	2	1940
17-70	29 HOMER RD	101	9,352	2,555	0.2732	4	2	1928
17-83	28 BRETTWOOD RD	101	9,928	2,686	0.2705	4	1.5	1953
17-85	48 BRETTWOOD RD	101	11,591	3,038	0.2621	5	1.75	1950
17-72	7 HOMER RD	101	9,406	2,441	0.2595	4	2	1928
17-122	24 HASTINGS RD	101	9,183	2,382	0.2594	4	2	1938
17-93	43 HASTINGS RD	101	9,000	2,319	0.2577	4	2	1941
L7-99	22 PIERCE RD	101	8,075	2,072	0.2566	4	2	1941
17-98	14 PIERCE RD	101	8,075	2,066	0.2559	4	. 2	1939
L7-128	58 HASTINGS RD	101	9,831	2,509	0.2552	4	1.75	1953
17-96	10 HOMER RD	101	9,444	2,390	0.2531	4	2	1940
17-87	11 PIERCE RD	101	8,500	2,104	0.2475	4	2	1940
7-92	49 HASTINGS RD	101	9,000	2,211	0.2457	4	2	1941
7-62	25 BRETTWOOD RD	101	9,000	2,200	0.2444	3	2	1940
.7-55	69 BRETTWOOD RD	101	9,633	2,343	0.2432	3	2	1949
.7-71	15 HOMER RD	101	8,956	2,162	0.2414	3	2	1945
.7-124	38 HASTINGS RD	101	8,544	2,051	0.2401	4	2	1935
.7-95	29 HASTINGS RD	101	10,803	2,578	0.2386	5	2	1938
7-89	28 HOMER RD	101	15,634	3,706	0.2370	5	2.5	1941
7-119	303 COMMON ST	101	10,937	2,558	0.2339	4	2	1929
7-60	37 BRETTWOOD RD	101	10,925	2,542	0.2327	4	2	1935
7-53	81 BRETTWOOD RD	101	11,929	2,773	0.2325	5	2	1950
7-76	279 COMMON ST	101	10,256	2,384	0.2324	5	1.5	1947
7-73	21 HASTINGS RD	101	13,030	3,014	0.2313	5	2 :	1938
7-84	36 BRETTWOOD RD	101	12,242	2,805	0.2291	4	1.5	1950
7-64	9 BRETTWOOD RD	101	10,000	2,276	0.2276	3	2 1	1934
7-88	22 HOMER RD	101	10,343	2,201	0.2128	3	2 1	1941
7-74	293 COMMON ST	101	12,455	2,528	0.2030	4	2 1	1938
7-78	263 COMMON ST	101	13,410	2,582	0.1925	3	2 1	942
7-100	28 PIERCE RD original	101	9,832	1,788	0.1819	3	2 1	949
7-54	75 BRETTWOOD RD	101	10,995	1,692	0.1539	3	2 1	.948
7-120	12 HASTINGS RD	101	14,000	2,118	0.1513	4	2 1	.938
Ì		Average	9,960	2,448	0.245	4	2	

Zoning Compliance Check List

Properties Located within the SR-C Districts

(To be Completed by a Registered Land Surveyor)

Property Address: 28 Pierce Road	
Surveyor Signature and Stamp:	Date: 9 A CUPPORD E ROBER


		A STATE OF THE STA		3
	<u>Per §4.2 of</u>	the Zoning By	/-Law	SSIONAL LA
	3	REQUIRED	EXISTING	PROPOSED
Lot Area (sq. ft.)	9,000	9,836	7020
Lot Fronta	ge (feet)			
Lot Covera	age (% of lot)	75	88.65	
	ce (% of lot)	25%	15.2%	21.8%
		50,90	75.3%	68.7%
Setbacks:	BRETTWOOD	25'	27.21	34.0'
feet)	➢ Side/Side	10 -	F. / -	8.1' -
	> Rear	285'	34.9'	
Transfer "	➤ Midpoint (feet)	4	34.1	28.8
Building Teight:	> Ridge (feet)			
	> Stories	21/2	0	6.1/
/2 Story	▶ Perimeter (50%)	. 4 /4	_ d	2/2
eet)	> Area (60%)			
Per §1.4)	> Length (75%)			
VAC (b)	Prohibited in Front Yard and Sid	e and Bear Soth		

⁽a) Front setback is equal to the average front setbacks of the abutting properties on

SUBMIT CALCULATIONS for all of the requirements listed above on a separate piece of paper(s) to verify how they were calculated.


⁽b) Includes all outdoor mechanical equipment and fuel storage systems.

#28 PIERCE ROAD

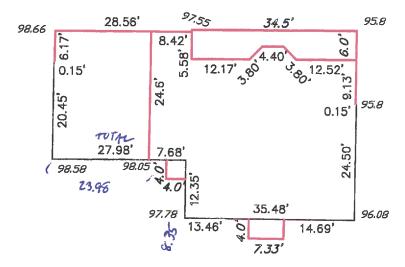



			Segment To						
	Segment From Existing	Segment From New	Existing	Segment To	Segment	Avg			
Segment	Grade	Grade		New Grade		Existing	Avg New	Difference	Ceiling Height:
A	98.58	98.58	98.05	98.05	23.98	2357.594	2357.594		Basement Floor Elevation
В	98.05	98.05	98.05	98.05	4				Ceiling Elevation
В	98.05	98.05	98.05	98.05	4	392.2			-
В	98.05	98.05	97.78	97.78	8.35	817.5903			Perimeter Total Length
C	97.78	97.78	97.78	97.78		1316.119			Total Perimeter Square Foot
D	97.78	97.78	97.78	97.78	4		391.12		Average Existing Grade
С	97.78	97.78	96.08	96.08	7.33			0.00	New Average Grade Difference in Grade in feet
D	96.08	96.08	96.08	96.08	4	384.32			billerence in Grade in 1660
D	96.08	96.08	96.08	96.08	14.69	1411.415			
E	96.08	96.08	95.8	95.8			2350.53		
E	95.8	95.8	95.8	95.8	0.15	14.37	14.37	0.00	9/ Covered with Ave C
F	95.8	95.8	95.8	95.8	9.13	874.654	874.654	0.00	% Covered using Avg Grade
G	95.8	95.8	95.8	95.8	6	574.8	574.8	0.00	
H	95.8	95.8	97.55	97.55	34.5		_	0.00	
1	97.55	97.55	97.55	97.55	0.42	40.971	40.971	0.00	
M	97.55	97.55	98.66	98.66	28.56	2801.879		0.00	
N	98.66	98.66	98.66	98.66	6.17			0.00	
0	98.66	98.66	98.66	98.66	0.15	14.799	14.799	0.00	
P	98.66	98.66	98.58	98.58	20.45	2016.779		0	
								0	

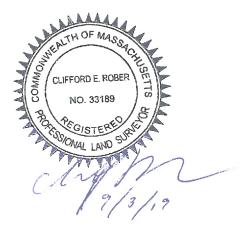

7.7 91.5 99.2 213.84 1646.57 97.30 97.30


75.28%

							Exposed	
	Ceiling	Elevation	Elevation		Ceiling	Square	Square	
Segment	Elevation	From	То	Length	Height	Footage	Footage	% Covered
A	99.2	98.05	98.05	7.68	7.7	59.14	8.83	85.06%
В	99.2	98.05	97.78	12.35	7.7	95.10	15.87	83.31%
С	99.2	97.78	96.08	35.48	7.7	273.20	80.54	70.52%
D	99.2	96.08	95.8	24.50	7.7	188.65	79.87	57.66%
E	99.2	95.8	95.8	0.15	7.7	1.16	0.51	55.84%
F	99.2	95.8	95.8	9.13	7.7	70.301	31.042	55.84%
G	99.2	95.8	95.8	12.52	7.7	96.404	42.568	55.84%
Н	99.2	95.8	97.55	3.8	7.7	29.26	9.595	67.21%
1	99.2	97.55	97.55	4.4	7.7	33.88	7.26	78.57%
J	99.2	97.55	97.55	3.8	7.7	29.26	6.27	78.57%
K	99.2	97.55	97.55	12.17	7.7	93.709	20.0805	78.57%
L	99.2	97.55	97.55	5.58	7.7	42.966	9.207	78.57%
M	99.2	97.55	97.75	8.42	7.7	64.834	13.051	79.87%
N	99.2	99.2	99.2	24.6	7.7	189.42	0	100.00%
	99.2			164.58	7.7	1267.27	324.69	74.38%

Ceiling Height:	7.7 <- enter
Basement Floor Elevation	91.5 <- enter
Ceiling Elevation	99.2
Perimeter Total Length	164.58
Total Perimeter Square Foot	1267.27
Exposed Square Footage	324.69
% Covered	74.38% <- result

North	South	East	West
#REF!	#REF!	#REF!	#REF!
#REF!	#REF!	#REF!	#REF!
0.00	0.00	0.00	0.00
0.00	0.00	0.00	0.00
0.00	0.00	0.00	0.00
#REF!	#REF!	#REF!	#REF!
#REF!	#REF!	#REF!	#REF!
#REF!	#REF!	#REF!	#REF!
#REF!	#REF!	#REF!	#REF!
#REF	#REF!	#REF!	#REF!
#REF!	#REF!	#REF!	#REF!



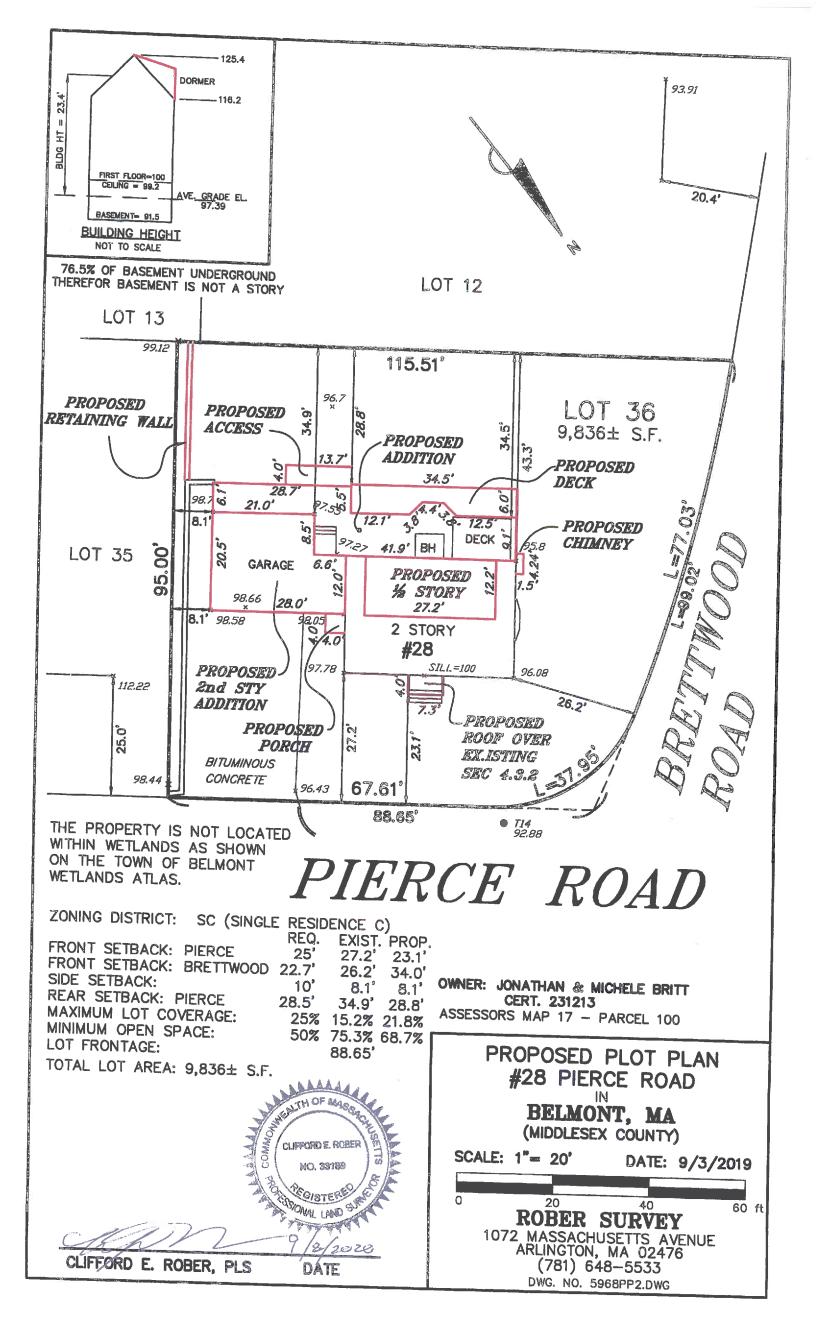





Keith B. Gross, RA 34 Silver Hill Road Weston, MA 02493 617-461-4505

No. :	Date:	Remarks:
1	8-7-20	PLAN CLARIFICATIONS
2	10-2-20	NOTATIONS
	-	
-		


BRITT Residence

28 PIERCE RD. BELMONT, MA

Date :	JAN. 6, 202
Scale	1/4" = 1'-0
Project Number	
Drawn By :	K
Checked By :	KBC

PROPOSED ELEVATIONS



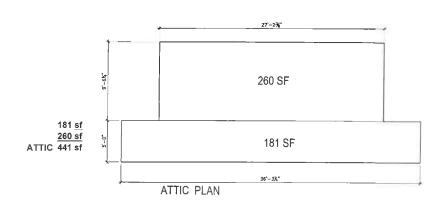

EXISTING HOUSE

870 sf TLA SECOND FLOOR

936 sf TLA FIRST FLOOR

1,806 TOTAL TLA

PROPOSED


1627 sf TLA SECOND FLOOR


1401 sf TLA FIRST FLOOR

3028 sf TLA

3028 - 1806 = 1222 sf INCREASE TLA 1222/1806 sf TLA = 67.7% INCREASE



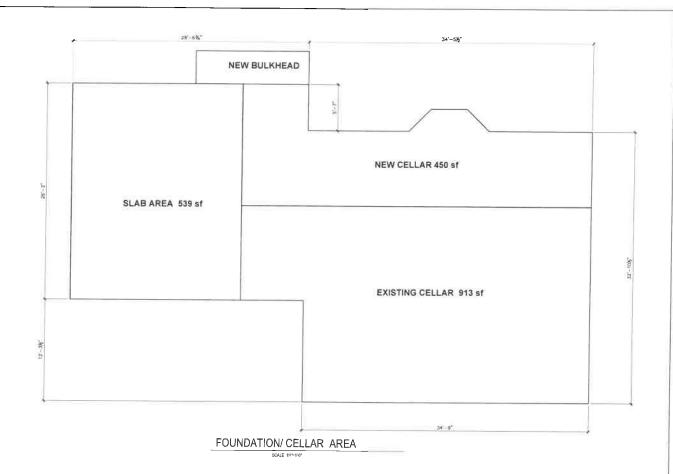

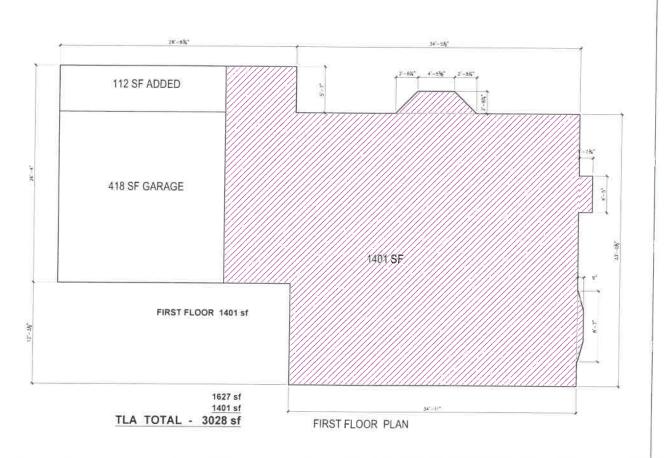



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10. :	Date:	Remarks
1	10-2-20	TLA CALCS
_	_	
_		
	-	-
	-	

BRITT Residence

28 PIERCE RD. BELMONT, MA


Date:	JAN. 6, 202
Scale:	3/16" = 1'-0
Project Number:	
Drawn By :	KC
Checked By :	кво

Drawing Title :

PROPOSED TLA PLANS



A0.2

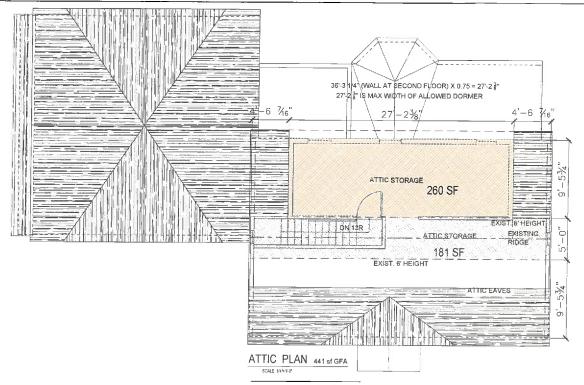


EXISTING HOUSE


181 sf GFA ATTIC 870 sf GFA SECOND FLOOR 936 sf GFA FIRST FLOOR 414 sf GFA GARAGE


2,401 TOTAL GFA

441 sf GFA ATTIC 1627 sf GFA SECOND FLOOR 1389 sf GFA FIRST FLOOR 531 sf GFA GARAGE

3988 sf GFA 3988 - 2401=1587 sf INCREASE GFA 1587/2401 sf GFA = 66.1% INCREASE

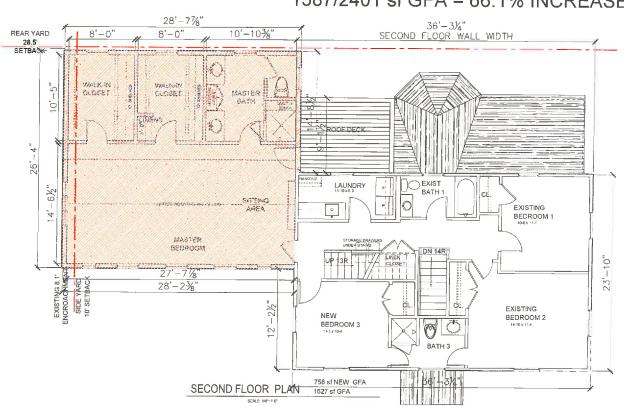

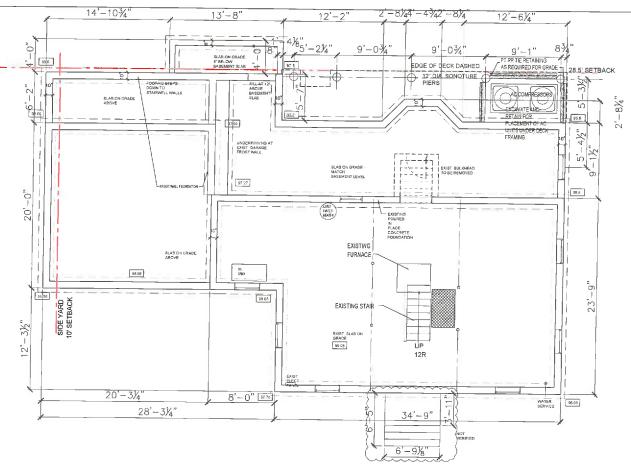

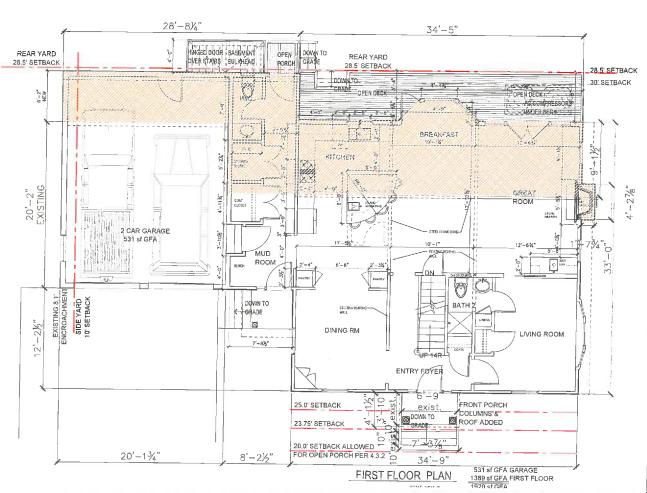



Keith B. Gross, RA 34 Silver Hill Road Weston, MA 02493 617-461-4505

Revisions :		
No. :	Date:	Remarks:
1	8-7-20	PLAN CLARIFICATION:
2	10-2-20	GRAPHICS
	-	

BRITT Residence

28 PIERCE RD. BELMONT, MA

Date	JAN 6, 202
Scale :	3/16" = 1'-0
Project Number :	
Drawn By:	K
Checked By :	KBC


Drawing Title

PROPOSED GFA PLANS



A0.1

FOR APPROVAL 8-21-20

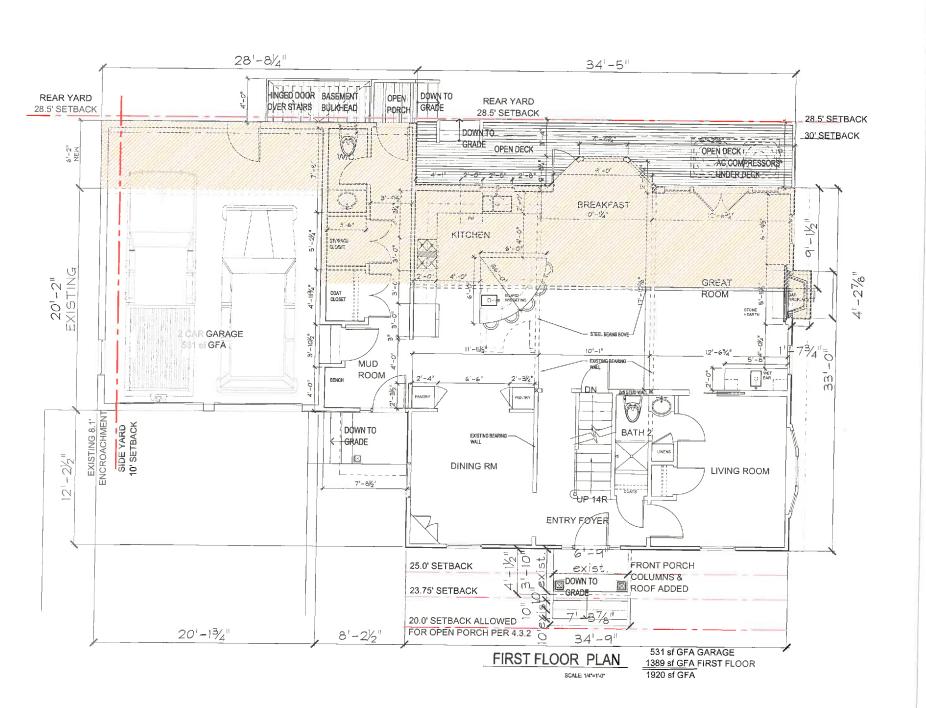



Keith B. Gross, RA 34 Silver Hill Road Weston, MA 02493 617-461-4505

No.:	Date:	Remarks:
1	8-7-20	PLAN CLARIFICATIONS
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_	_	
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BRITT Residence


28 PIERCE RD. BELMONT, MA

Date:	JAN. 6, 2020
Scale :	1/4" = 1'-0"
Project Number :	
Drawn By :	KG
Checked By :	KBG

PROPOSED FLOOR PLANS



A1.0

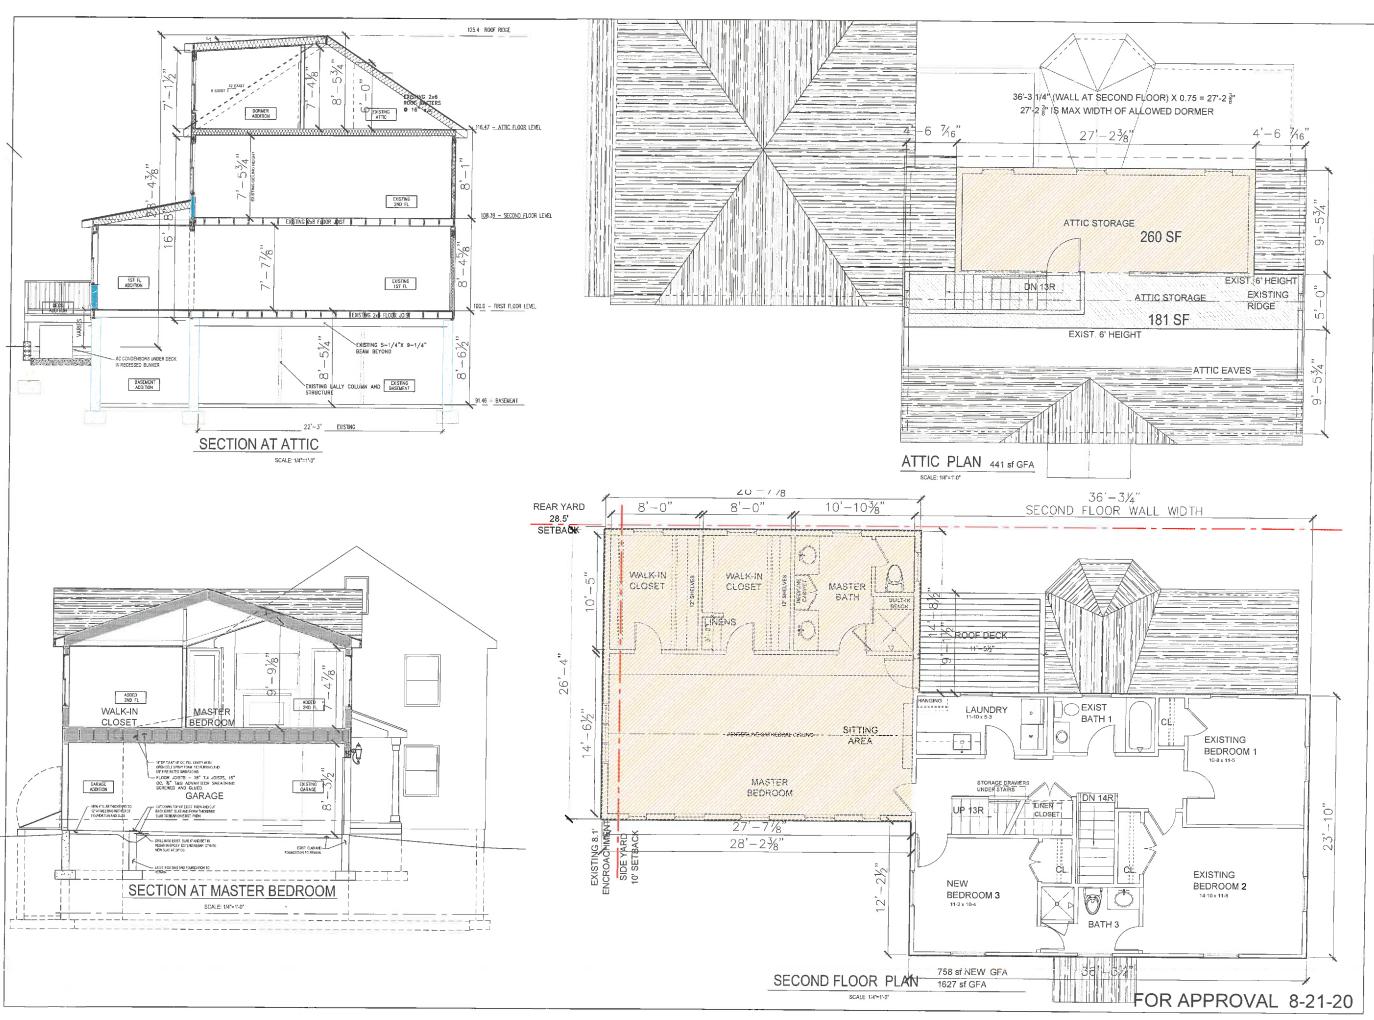



Keith B. Gross, RA 34 Silver Hill Road Weston, MA 02493 617-461-4505

No.	Date:	Remarks
1	8-7-20	PLAN CLARIFICATIONS
2	10-2-20	GRAPHICS
_		
_	-	

BRITT Residence

28 PIERCE RD. BELMONT, MA

Date:	JAN. 6, 202
Scale :	1/4" = 1'-0
Project Number	
Drawn By :	K
Checked By:	KBC

Drawing Title

PROPOSED PLANS & SECTIONS



A1.1




FACING PIERCE ROAD



CORNER OF PIERCE AND BRETTWOOD



ALONG BACK PROPERTY LINE

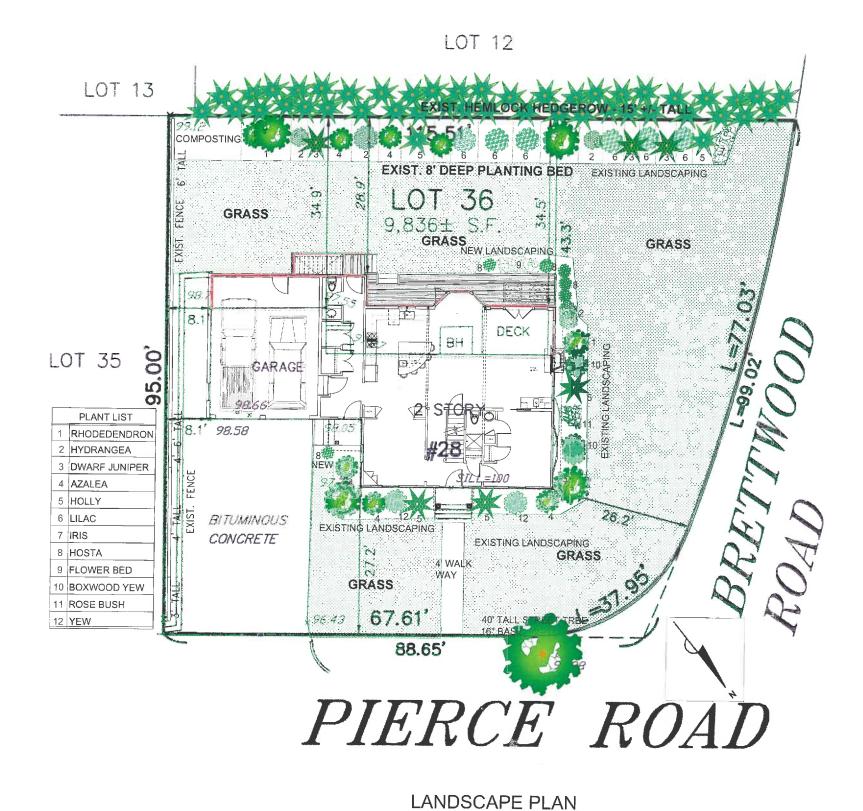

1/8" = 1'-0"

ARCHITECTURE
603 Mouni Auburi Si
www.rdsiarchitecture.com

Keith B. Gross, RA 34 Silver Hill Road Weston, MA 02493 617-461-4505

No. :	Date:	Remarks:
1	8-28-20	PLAN CREATION
	_	
	-	·
		-
-		
	_	

BRITT Residence

28 PIERCE RD. BELMONT, MA

Date:	JAN. 6, 2020
Scale :	1/8" = 1'-0"
Project Number:	
Drawn By :	KG
Checked By :	KBG

PROPOSED LANDSCAPE PLANS



L1.0