

2019 OCT -7 PH 1: 28

NOTICE OF PUBLIC HEARING BY THE PLANNING BOARD

ON AN APPLICATION FOR THREE SPECIAL PERMIT

Notice is hereby given that the Belmont Planning Board will hold a public hearing on TUESDAY, OCTOBER 15, 2019, at 7:00 PM in the Board of Selectmen's Meeting Room, Town Hall, 455 Concord Ave., to consider the application of Peter Arsenault for THREE SPECIAL PERMITS under Section 1.5.4 A of the Zoning By-Laws to ALTER A NONCONFORMING STRUCTURE IN ORDER TO CONSTRUCT A NEW ROOF AND A DORMER ADDITION, AND TO INCREASE THE SIZE OF THE HOME BY MORE THAN 300 SF at 30 Walnut Street located in the General Residence Zoning District.

Planning Board





Town of Belmont Planning Board

2013 OCT -7 PM 1: 29

APPLICATION FOR A SPECIAL PERMIT

Date:	9/3/19
Date.	

Planning Board Homer Municipal Building 19 Moore Street Belmont, MA 02478

To Whom It May Concern:

Pursuant to the provisions of Massachuse	tts General Laws, Chapter 40A,
Section 9, as amended, and the Zoning By-Law of	of the Town of Belmont, I/we the
undersigned, being the owner(s) of a certain pard	
	reet/Road, hereby apply to your Board
for a SPECIAL PERMIT for the erection or alterat	
thereof under the applicable Section of the Zoning	
roof alteration and down	
deck reconfiguration (2)	
to deck)	
· · · · · · · · · · · · · · · · · · ·	
on the ground that the same will be in harmony	with the general purpose and intent o
said Zoning By-Law.	
Signature of Petitioner	Peter Arsenault
Print Name	Peter Arsenault
Address	28 Walnut Street
	Belmont, MA 02478
Daytime Telephone Number	339-234-0727



OFFICE OF COMMUNITY DEVELOPMENT TOWN OF BELMONT

19 Moore Street Homer Municipal Building Belmont, Massachusetts 02478-0900

Telephone: (617) 993-2650 Fax: (617) 993-2651

Building Division (617) 993-2664 Engineering Division (617) 993-2665 Planning Division (617) 993-2666

August 28, 2019

Ms. Anne Arsenault 28 Walnut Street Belmont, MA 02478

RE: Denial to Construct New Roof and One (1) Dormer

Dear Ms. Arsenault:

The Office of Community Development is in receipt of your building permit application for the construction of a new roof and one (1) dormer on top of your home located in a General Residence (GR) Zoning District.

Your application has been denied because it does not comply with the Zoning By-Law. More specifically, Section 4.2.2 of the By-Law allows minimum 10.0' side setbacks and 2-1/2 stories; however, the existing and proposed side setback to the new roof on the east side of your home is 7.2' and the number of stories is 3-1/2. As a result, your home is considered nonconforming and therefore any addition greater than 300 square feet requires a Special Permit from the Planning Board. Your proposed addition is 518 square feet.

You may alter your plans to conform to the Zoning By-Law and resubmit for a building permit or you may request three (3) Special Permits from the Planning Board: side setback, number of stories, and addition greater than 300 square feet. If you choose to pursue the Special Permits, please call the Office of Community Development at (617)-993-2666 to schedule an appointment with the Planning Staff in order to begin this process.

Sincerely,

Glenn R. Clancy, P.E. Inspector of Buildings

Belmont Planning Board

Special Permit Narrative Statement

30 Walnut Street

Peter and Jen Arsenault of 30 Walnut Street seek a special permit in order to <u>alter the roof structure</u>, <u>convert an existing rear pantry into covered deck</u>, and add a dormer on an existing non-conforming two family structure in the GR zone. The proposed increase in GFA (ceiling height of 6' or greater) is 487 SF.

The current 2,472 sf (TLA) home has one unit (#28) on the first floor and a second unit (#30) on the second floor. The second floor unit currently has two bedrooms and one bathroom. The intention with the attic renovation is to add two more bedrooms and a second bathroom.

Peter and Jen have lived in this home for the past six years. The house has been in their family for three generations. The house was purchased by Peter's grandparents, Guy and Jenny Ruggeri in 1950 from Guy's uncle. Guy and his family resided downstairs in 28, while his sister and her family lived upstairs in 30 Walnut until 1985. Guy continued to live in the first floor unit until his death in 2005. After his grandparent's died, Peter's mother inherited the home. Peter and Jen hope to make Walnut Street their permanent home where they can raise a family.

The project involves three components.

- 1. Roof alteration: Currently, the attic space has a very shallow roof with a ridge height of only 6'-8" with 2x8 floor joists and 2x6 rafters. In order to convert this into a viable living space, the roof needs to be reconstructed with a steeper pitch (proposed 8.5:12 pitch) in order to allow for a thicker floor sandwich and deeper roof rafters to meet structural and energy code requirements as well as some more head height to meet building code requirements. The proposed roof alteration would replace the squat gambrel style roofline with a more ubiquitous and more aesthetically proportional roofline. It will increase the overall height from 26.2' (midpoint) to 28.1' (midpoint) which is still considerably lower than the 33' (midpoint) allowed by zoning. This would also increase the overall height from 29'-11" (ridge) to 33'-3" (ridge) which is still lower than the abutting structure # 24-26 to the left which is a recently constructed 4 story tall triple decker with a flat roof at 35' high; and aligned with #32-34 to the right which is a gable roof consistent with many of the other homes on the street, with a peak at approximately 33'-6" high. Currently, the Arsenault property is squat and disproportionate compared to its neighbors. The proposed alterations would adjust it so that it is consistent with the typical heights of the other gables along Walnut Street. Furthermore, the new gable roof with a front window is very consistent with the vernacular on the street (see attached photographs).
- 2. New dormer: The proposed renovation also includes incorporating a shed dormer on the back right side of the structure in order to provide the necessary head height at the stairs as well as the ability to incorporate the fourth bedroom with side facing windows. The dormer is deliberately located on the rear of the structure (21'-4" behind the front of the house) to minimize its impact on the street front elevation, and the dormer is staggered, with the rear portion of it stepped back by 2'-11" in order to further soften the visual impact as seen from the rear of the property. The dormer itself is conforming set back a generous 15.3' from the side property line and 101.2' from the rear property line.

3. Pantry conversion to deck: The third component of the renovation involves eliminating a small 4'-11" x5'-8" second floor pantry in order to expand the existing second floor covered deck to make it a more usable space for the owners to enjoy a connection to their back yard and view of the park. This has no significant impact on any zoning and a minimal visual impact as it will still have the same massing.


The overall effect will be in harmony with the architecture and scale of the neighborhood.

We had a design review meeting with Spencer Gober and incorporated his suggestions to arrive at the current design. Specifically, we reduced the overall square footage, reduced the roof pitch of the previous design and incorporated the staggered dormer strategy. The Arsenaults have also shared these plans with and received enthusiastic support from many neighbors including abutters.

The proposed design is in harmony with the neighborhood vernacular, and the size of the proposed home is consistent with many in the neighborhood. The proposed design is in keeping with the intent of Town Meeting and the Planning Board Special permit criteria (Section 1.5.4.B) and is not substantially detrimental to the neighborhood. In fact, we believe that the proposed addition represents a significant improvement to the property and therefore the neighborhood as a whole.


Thank you for your consideration on this matter.

30 Walnut Street in context – note that the subject property is significantly shorter than its neighbors. The intent of the design is for it to align with the other gable structures.

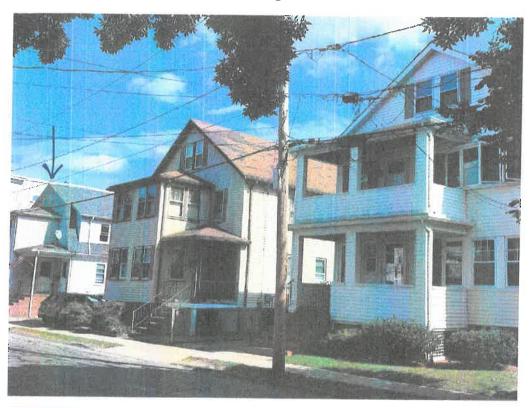






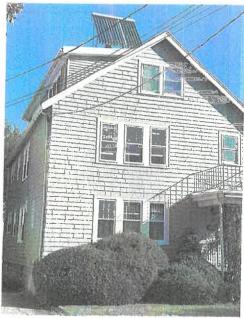







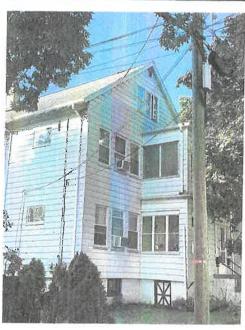




Examples of other gables with third floor windows in neighborhood (10f2)










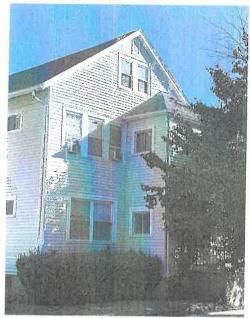





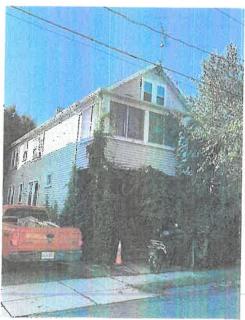













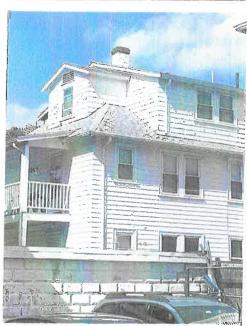

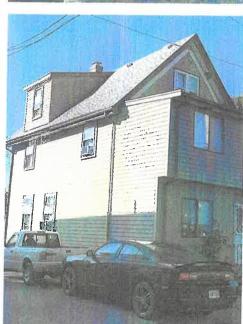

Examples of other dormers in neighborhood (1 of 2)













Zoning Compliance Check List

Properties Located within the GR Zoning Districts (To be Completed by a Registered Land Surveyor)

Property Address:	28-30	WALNUT ST.	

Surveyor Signature and Stamp		Date:	
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		<u> </u>				
	Per §4.2 of the Zoning By-Law					
			REQUIRED	E)	CISTING	PROPOSED
Lot Area (sq. ft.)	5,000 S.F.	7.8	030 SF	7.830 S.F.
Lot Fronta	ge (fe	eet)	50'	50	0.02	50.0
Lot Area/L	Jnit (s	g. ft./d.u.)	NIA	N	1,0	NIA
Lot Covera	age (9	% of lot)	300/6	19	,45/0	19.9%
Open Space	ce (%	of lot)	400%	71	50/6	71.50%
	>	Front (a)	8.31	6.	8	6.8
Setbacks:	>	2nd Front Door (25%)	NiA	N	10	NIA
(feet)	>	Side/Side	10' 10'	7.2	13,3"	7.21 16.31
	> 1	Rear	20'	101	.2'	121.2'
Building	>	-eet	73'	26	. 2-	28.11
Height:	> 8	Stories	21/2	3'	4	31/2
1/2 Story	> F	Perimeter (50%)				
(feet)	> A	rea (60%)				
(Per §1.4) >		ength (75%)				
Per §6D of the Zoning By-Law						
HVAC: Prohibited in Front Yard			rd and Side and	Rear	Setbacks	
Front Doors: Both Must Face Street			(b)			
			STANDARD		PR	OPOSED
Curb Cut (One per 70' Frontage) (c)				/		

⁽a) Front setback is equal to the average front setbacks of the abutting properties on either side.

(b) The second unit's front door may be allowed to face the side yard only if the existing structure is historically or architecturally significant.

(c) A second curb cut may be allowed where the Applicant can demonstrate that creating a second curb cut is harmonious with the surrounding neighborhood.

SUBMIT CALCULATIONS for all of the requirements listed above on a separate piece of paper(s) to verify how they were calculated

DLJ GEOMATICS

276 NORTH STREET WEYMOUTH, MA 02191

LANDSURV@COMCAST.NET
WWW.DLJGEO.COM

July 26, 2019

28-30 WALNUT STREET BELMONT, MA 02478

CELLAR CALCULATIONS:

THE CELLAR WALLS ARE 7.15 HIGH. THERE ARE SEVEN SEGMENTS.

SEGMENT:	LENGTH:	AREA:	AREA BELOW GRADE:
A	9.0	67.50 S.F.	36.63 S.F.
В	14.3'	102.25 S.F.	52.77 S.F.
C	9.0'	67.50 S.F.	33.39 S.F.
D	8.17	57.92 S.F.	28.35 S.F.
E	39.7'	283.86 S.F.	136.17 S.F.
F	27.1	193.77 S.F.	91.87 S.F.
G	39.7'	283.86 S.F.	138.16 S.F.

517.34/1,056.66=.4899

TOTAL:

48.99% OF THE FOUNDATION WALL IS BELOW GRADE.



1,056.66 S.F. 517.34 S.F.

28-30 WAGNUT 57. BELMONT

SEG A" BATEMENT CELLING= 10454 1070L 19.5 PACE 19.5 WAL PACE 101.93 100.68 101,46 x 407 BALON graie 31.63 4.07 36.63 = 15427 BOSEMENT FIRE 97.39 54.27% 9.0 BELOW grade SEC "B" CEILING = 104.54 14.3 - 10TOU PACE ghilograde 121.17 100,93 101.08 3.19 12.73 = .5/6/ 51.61% BELOW Euron= 97,39 14.3

BECMONT STREET

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±	BOTEMENT CERTINGE 10954	
9.0 17.15 PACE 67.50 PACE NULL		
9.0 4 3.71 101.17 4 3.39 BEAU 9 120de	3.71	718-1
33.34 67.50 .4947 49.47%	BOIEMANT pron 97, 29 ONINO MISS	•
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SEO. "D"	Dog 20-69-19-119	
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8,1 TOTAL 17,92 POPE 157,92 WILL		
	100.75	5
B. 1 BENN 20.35 Bennde	3.50	
28.73 = 4895 57.92		
43,95% BELOW 9	rate 8.1	

BELMONT.

549 E

349 E	•			
¥	BOSE	MENT CELL	ving=104.54	
39.7 Total 283.96 Work				
39.7 BELON 911de 13617. 100,75			100.8 Z.	100.39
136,17 783.56 97-77		×	3.43	1
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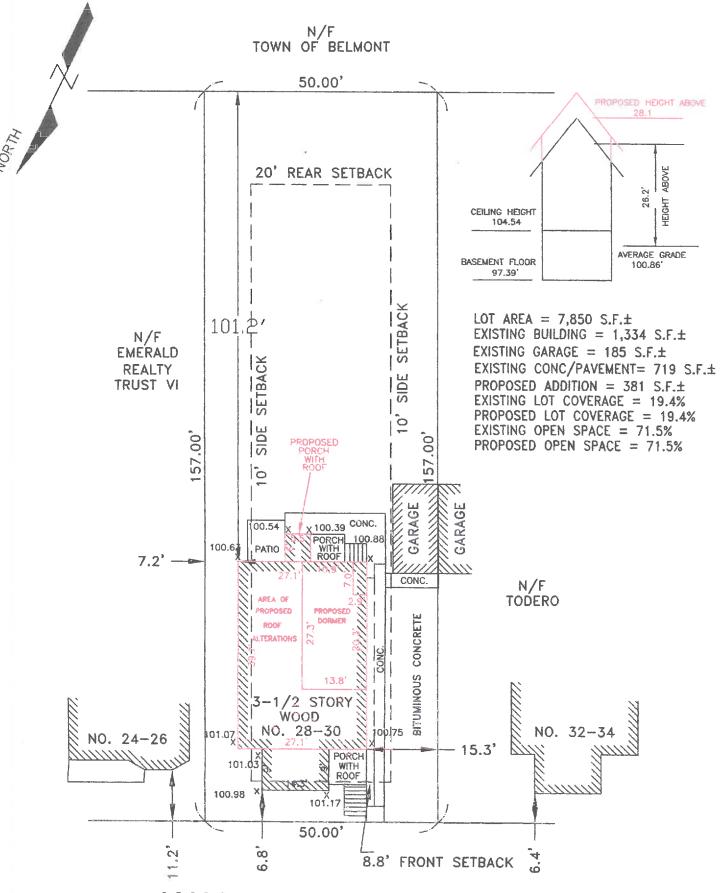
BELMONT SINCET

SEG "G"

39.7 - 1018 | 100.87 | 100.87 | 100.87 | 100.87 | 138.16 | 4868 | 138.16 | 4868 | 138.7 | 100.87 | 138.7 | 100.87 | 100.87 | 100.







WALNUT STREET

NOTES

- 1. SEE DEED RECORDED IN MIDDLESEX COUNTY REGISTRY OF DEEDS IN DEED BOOK 15805, PAGE 564.
- 2. SEE PLAN RECORDED IN MIDDLESEX COUNTY REGISTRY OF DEEDS IN PLAN BOOK 190, PLAN 6.
- 3. SUBJECT PARCEL IS LOCATED IN ZONE GR

DWAL LAND SURVEYOR

- 4. SUBJECT PARCEL IS LOCATED IN FLOOD ZONE X AS SHOWN ON PANEL 25017C0418E WITH AN EFFECTIVE DATE OF JUNE 4, 2010.
- 5. NO PUBLIC SHADE TREE IS LOCATED WITHIN THE LIMITS OF THE PROPERTY FRONTAGE OF THE SUBJECT PROPERTY.




(IN FEET)
1 inch = 20 ft.

CERTIFIED PLOT PLAN
IN
BELMONT, MA

SCALE: 1" = 20' JULY 26, 2019

DLJ GEOMATICS
PROFESSIONAL LAND SURVEYING
276 NORTH STREET
WEYMOUTH, MA 02191
(781) 812-0457
28-30 WALNUT ST BELMONT.dwg

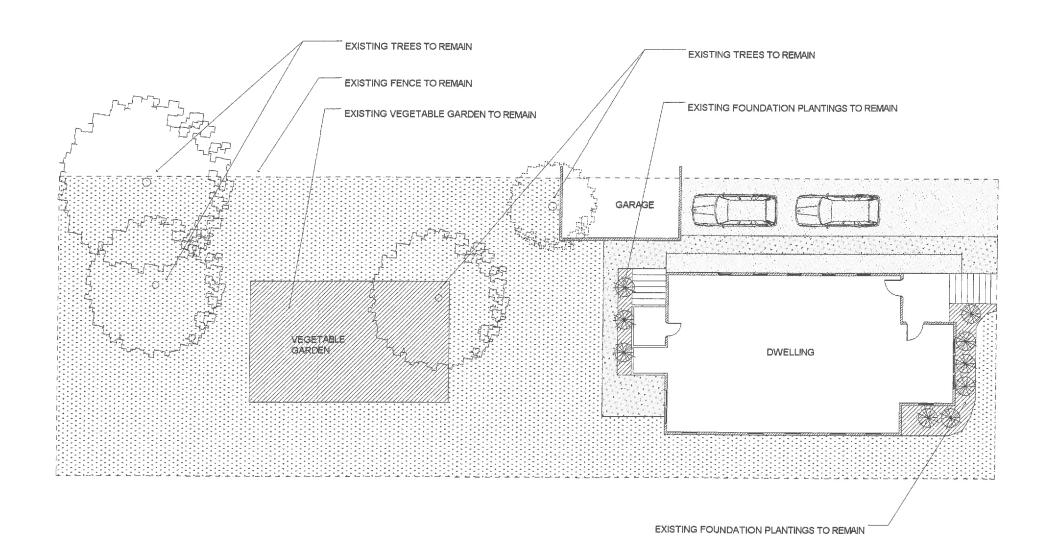

GRASS

MULCH

HARDWOOD
DECK


PAVERS

ASPHAULT

CONCRETE

RETAINING
WALL

PLAN
SCALE: 1/8" = 1'

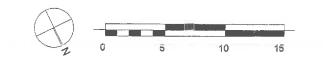




80 CLARK STREET BELMONT, MA 02478

Architect: Miller Design LLC 80 Clark Street Belmont MA 02478 617-993-3157

Date: Issued for;

7/24/19 PLANNING BOARD REVIEW

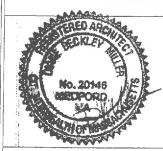


ARSENAULT RESIDENCE 30 WALNUT STREET BELMONT MA 02478

LANDSCAPE PLAN

Sheet Number:

L1

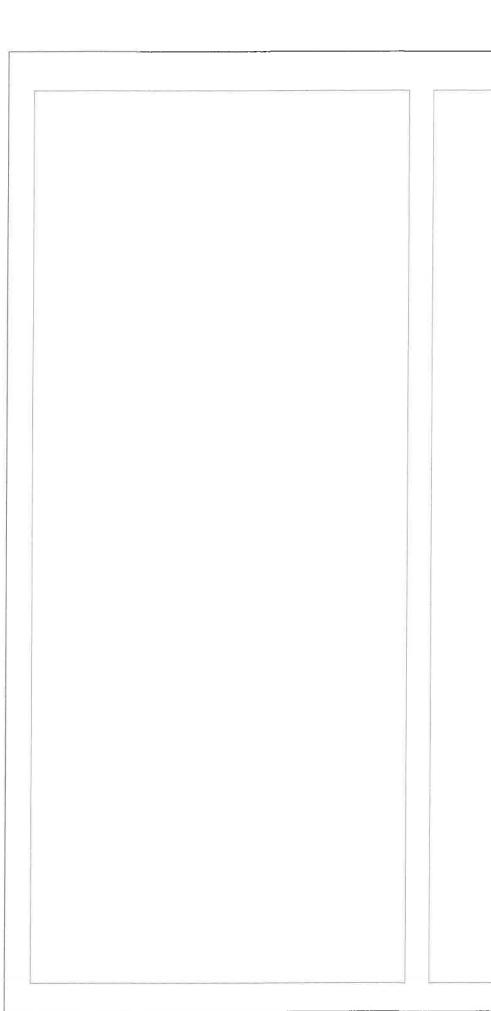

PLANNING BOARD REVIEW SET ATTIC EXPANSION & DORMER JULY 24, 2019

ENERGY AUDIT:

REFERENCE CH 11 - ENERGY EFFICIENCY 2015 INTERNATIONAL RESIDENTIAL CODE W/ MASS AMENDMENTS.

PRESCRIPTIVE OPTION FOR RESIDENTIAL ADDITION (401.3):

- 1. RENOVATION TO COMPLY WITH ENERGY STAR QUALIFIED HOMES THERMAL BYPASS INSPECTION CHECKLIST. INSULATION VALUES AS FOLLOWS: R49 ROOF R-VALUE, R30 FLOOR R-VALUE, R20 WALL R-VALUE, R15/19 BASEMENT / CRAWL SPACE WALL R-VALUE.
- 2. RENOVATION TO COMPLY WITH ENERGY STAR PROGRAM REQUIREMENTS FOR RESIDENTIAL WINDOWS, DOORS, AND SKYLIGHTS VERSION 5.0. ALL NEW WINDOW GLAZING TO BE .30 U FACTOR AND SKYLIGHTS TO
- 3. HEATING / COOLING DUCTS TO BE SEALED ADN TESTED TO MEET REQUIREMENTS OF 401.3.

PROJECT INFORMATION:

BELMONT ZONING GR

REQUIRED:

MAX 30% LOT COVERAGE MIN 40% OPEN SPACE

FRONT YARD SETBACK: AVERAGE REAR YARD SETBACK: 20-0" SIDE YARD SETBACK: 10'-0"

MAX HEIGHT: 2 1/2 STORIES AND 33' TO MIDPOINT

DRAWING LIST

COVER SHEET

EXISTING BASEMENT PLAN

EXISTING FIRST FLOOR PLAN EXISTING SECOND FLOOR PLAN

A5 EXISTING ATTIC PLAN

EXISTING ELEVATIONS

NEW SECOND FLOOR PLAN

A6 A7 A8 NEW ATTIC PLAN

A9 ATTIC CALCULATIONS AND AREAS

A10 **ROOF PLAN**

NEW ELEVATIONS

LIGHTING LEGEND

RECESSED LED CAN LIGHT - AS SELECTED BY OWNER

CEILING MOUNTED PENDANT - AS SELECTED BY OWNER

WALL MOUNTED SCONCES AS SELECTED BY OWNER



CEILING FAN WITH INTEGRAL LIGHT - AS SELECTED BY OWNER

SMOKE DETECTOR - NOTE ALL NEWAND EXISTING SMOKES TO BE HARD-WIRED PER CODE

S/CO HARD-WIRED SMOKE / CARBON MONOXIDE DETECTOR

DATA CONNECTION

TELEPHONE / DATA CONNECTION

ELECTRIC OUTLET (SPECIFIC LOCATIONS ONLY - ALL OUTLETS AS REQUIRED BY CODE ARE NOT SHOWN ON PLANS)

SYMBOL LEGEND

WALL TO BE DEMOLISHED

EXISTING WALL TO REMAIN



INTERIOR ELEVATION



SECTION

NEW WALL



WINDOW TAG

MILLER DESIGN LLC



80 CLARK STREET BELMONT, MA 02478


Architect: Miller Design LLC 80 Clark Street Belmont MA 02478 617-993-3157

4/15/19 SCHEMATIC DESIGN DESIGN DEVELOPMENT 7/24/19 PLANNING BOARD REVIEW



ARSENAULT RESIDENCE 30 WALNUT STREET BELMONT MA 02478


COVER SHEET

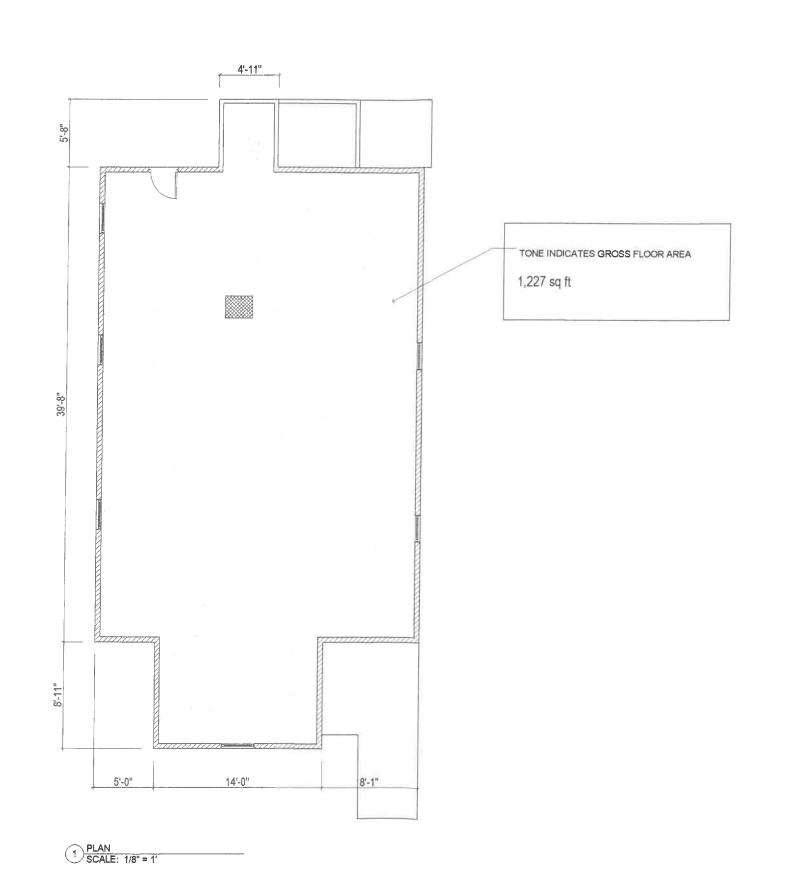



Architedt: Miller Design LLC 80 Clark Street Belmont MA 02478 617-993-3157


Date:	Issued for
4/15/19	SCHEMATIC DESIGN
5/15/19	DESIGN DEVELOPMENT
6/6/19	REVIEW
7/24/19	PLANNING BOARD REVIEW

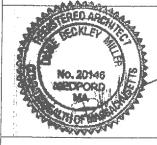

ARSENAULT RESIDENCE 30 WALNUT STREET BELMONT MA 02478

EXISTING BASEMENT

She

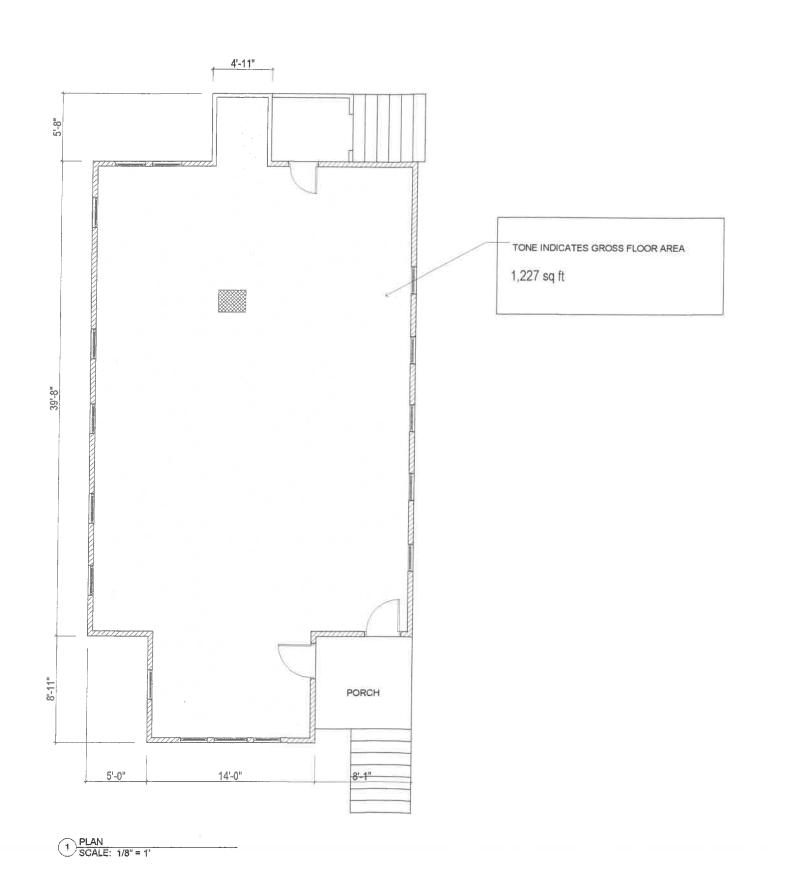



Architedt Miller Design LLC 80 Clark Street Belmont MA 02478 617-993-3157


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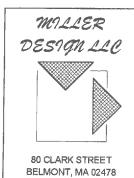


ARSENAULT RESIDENCE 30 WALNUT STREET BELMONT MA 02478

EXISTING FIRST FLOOR

Sheet Number:



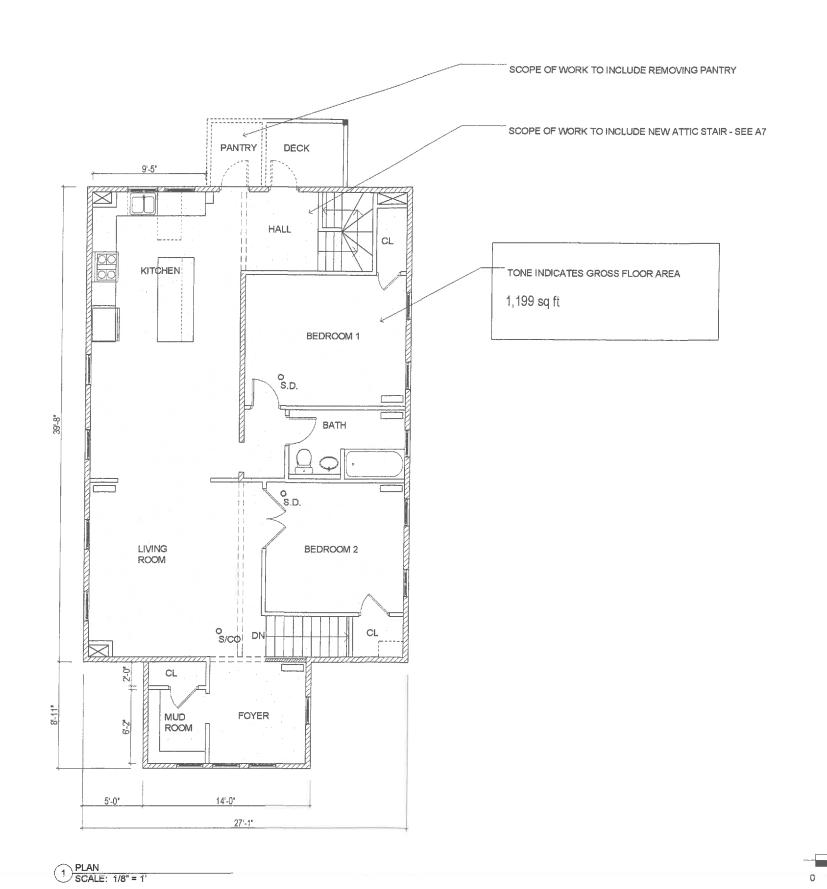

Architect; Miller Design LLC 80 Clark Street Belmont MA 02478 617-993-3157

ĺ	Date:	Issued for:
	4/15/19	SCHEMATIC DESIGN
	5/15/19	DESIGN DEVELOPMENT
	6/6/19	REVIEW
	7/24/19	PLANNING BOARD REVIEW




ARSENAULT RESIDENCE 30 WALNUT STREET BELMONT MA 02478

EXISTING SECOND FLOOR

Sheet Number:

10

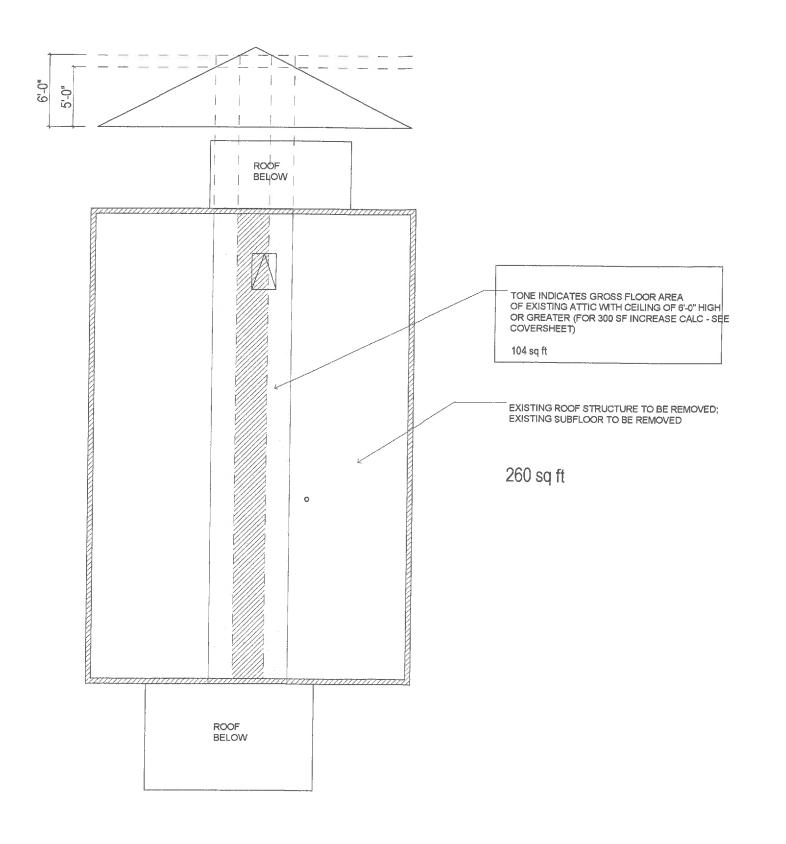



Architect; Miller Design LLC 80 Clark Street Belmont MA 02478 617-993-3157

- 11		103000 101.
	4/15/19	SCHEMATIC DESIGN
	5/15/19	DESIGN DEVELOPMENT
- 11	6/6/10	BEVIEW.

7/24/19 PLANNING BOARD REVIEW




ARSENAULT RESIDENCE 30 WALNUT STREET BELMONT MA 02478


EXISTING ATTIC


Sheet

A5

1 PLAN SCALE: 1/8" = 1 Ū 5 10 15

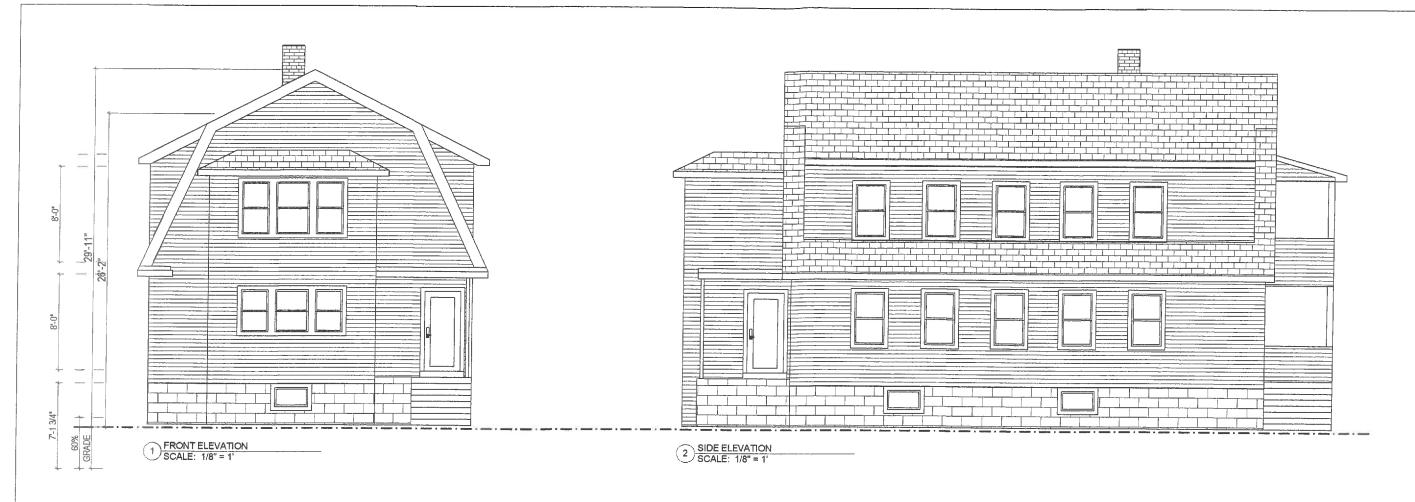

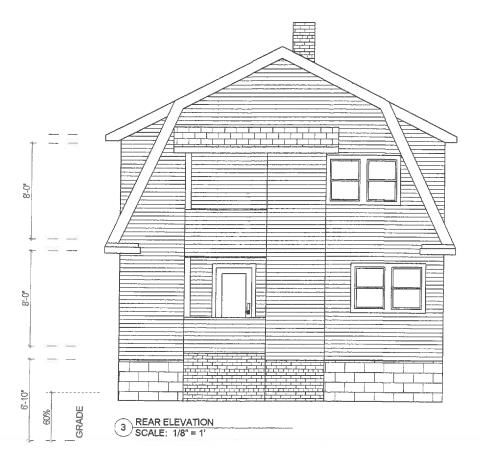


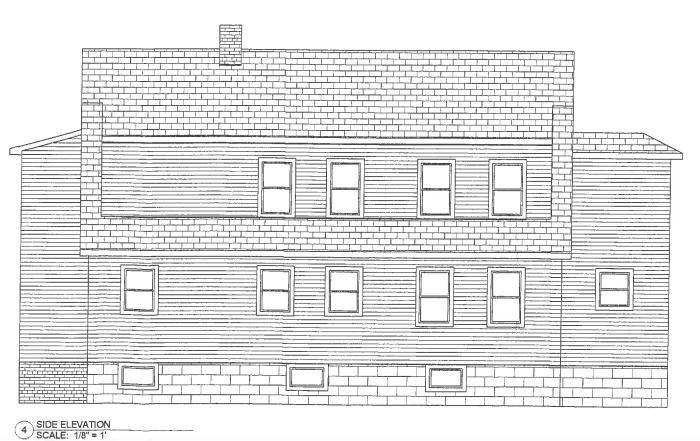



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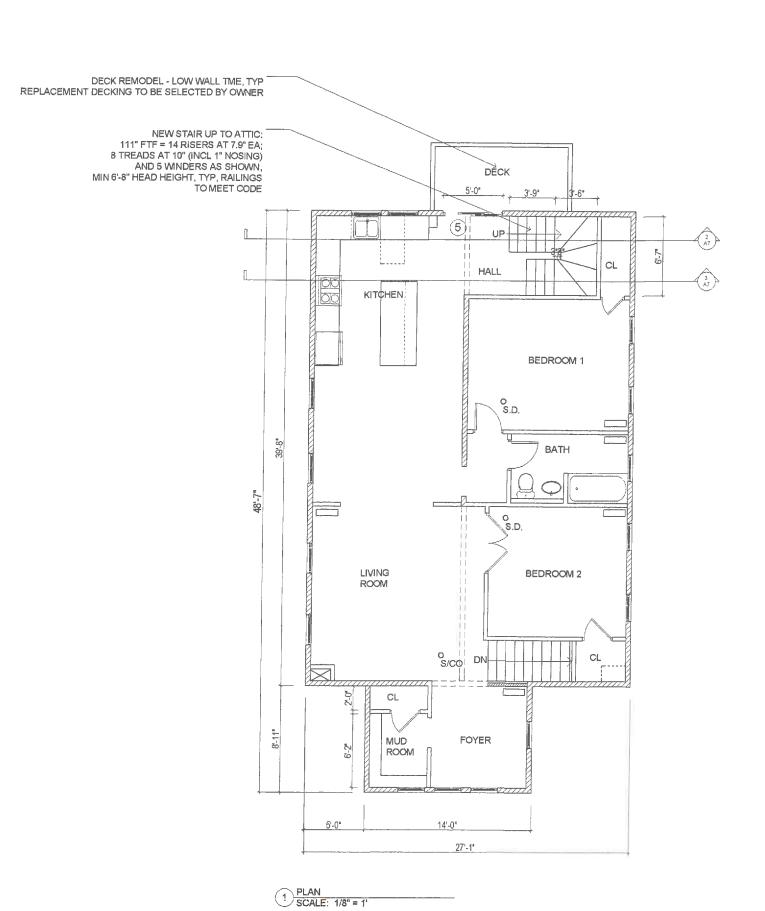
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6/6/19	REVIEW
7/24/19	PLANNING BOARD REVIEW

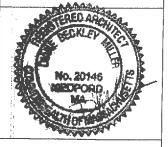



ARSENAULT RESIDENCE 30 WALNUT STREET BELMONT MA 02478

EXISTING ELEVATIONS

Sheet



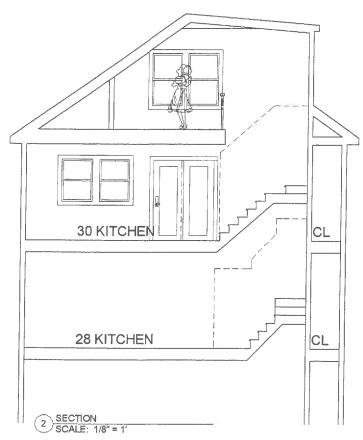

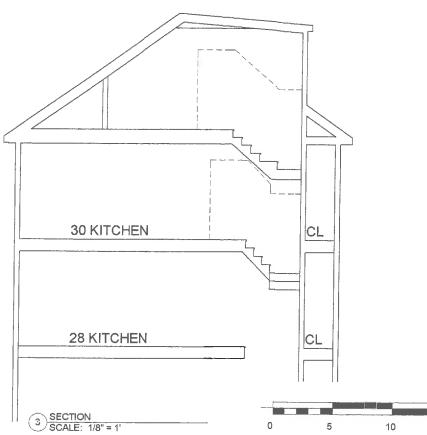



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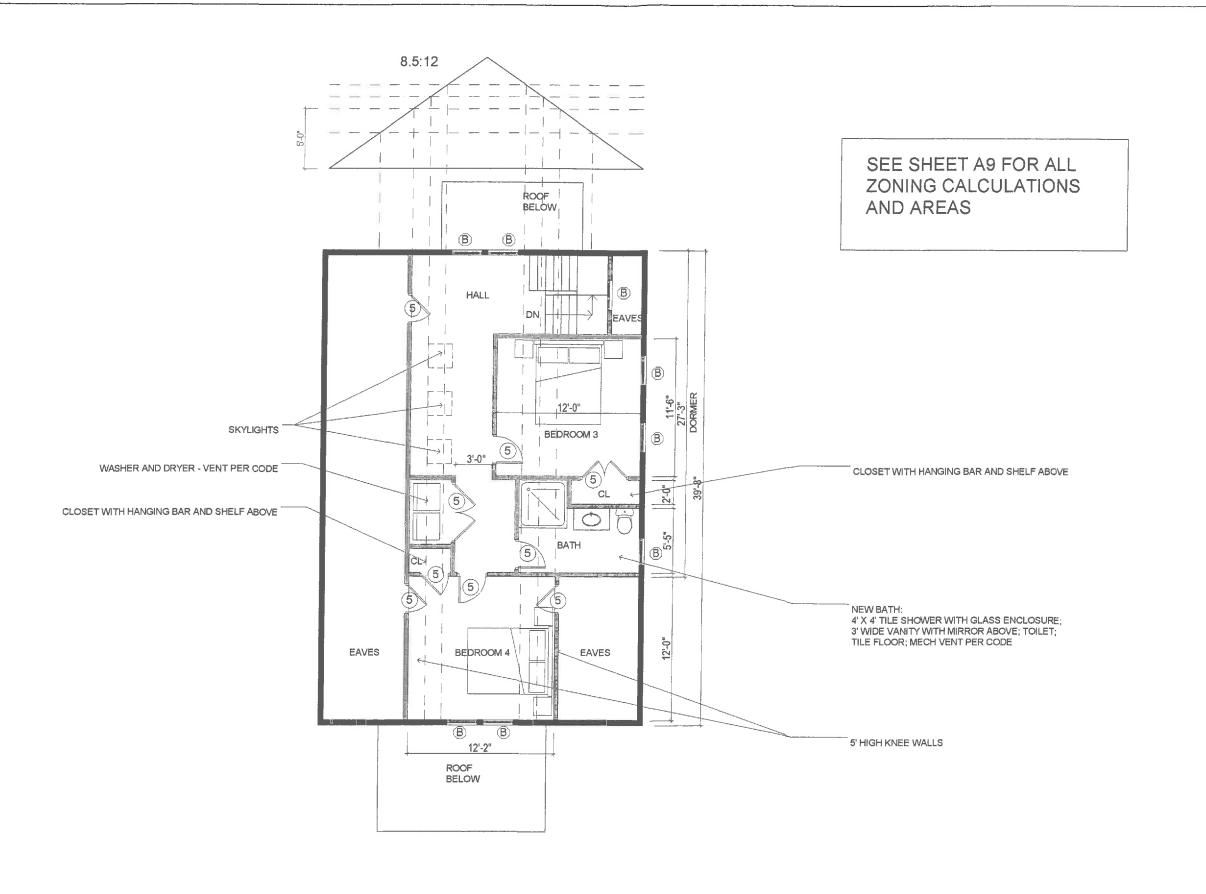
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4/15/19	SCHEMATIC DESIGN
5/15/19	DESIGN DEVELOPMENT
6/6/19	REVIEW
7/24/19	PLANNING BOARD REVIE
8/28/19	REVISIONS



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NEW SECOND FLOOR PLAN

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7/24/19 PLANNING BOARD REVIEW



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NEW ATTIC FLOOR PLAN

HALF STORY AREA CALCULATIONS:

ALLOWABLE: AREA WITH CEILING HEIGHT OF 5' OR GREATER CAN BE NO MORE THAN 60% OF SECOND FLOOR AREA

SECOND FLOOR AREA = 1199 SF 60% OF 1199 = 719.4 SF MAX ACTUAL: 664 SF, CONFORMING (PROPOSED AREA W/ CEILING HEIGHT OF 5' OR GREATER IS DESIGNATED BY TONE)

HALF STORY PERIMETER CALCULATIONS:

SECOND FLOOR PERIMETER = 151'-4" LF


ALLOWABLE: MAX 75'-8 W/ RAFTER BOTTOMS AT 3' OR GREATER (BASED ON 50% OF 151'-4" PERIMETER).

AGTUAL: 17'-9" + 17'-9" + 27'-3" = 62'-9", CONFORMING

DORMER LENGTH CALCULATIONS:

ALLOWABLE: 29'-9" MAX PER ROOF SIDE (75% OF 39'-8")

ACTUAL: 27'-3", CONFORMING

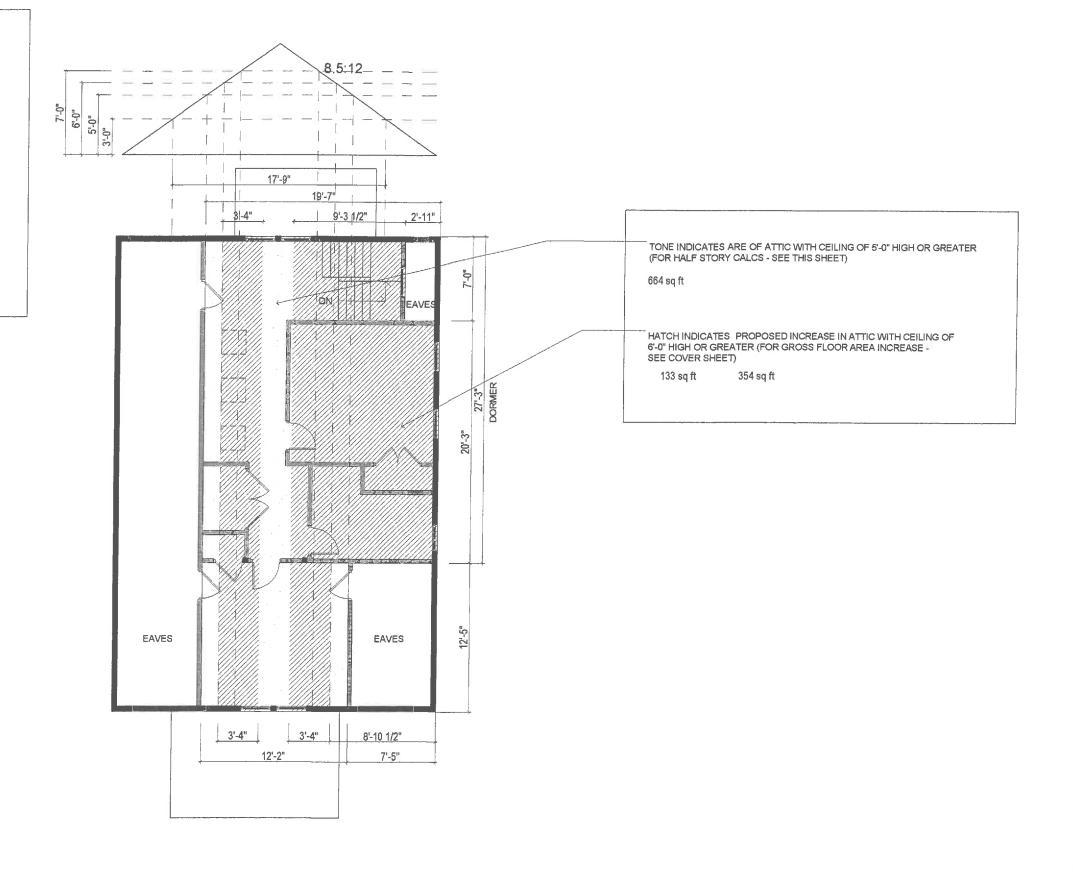



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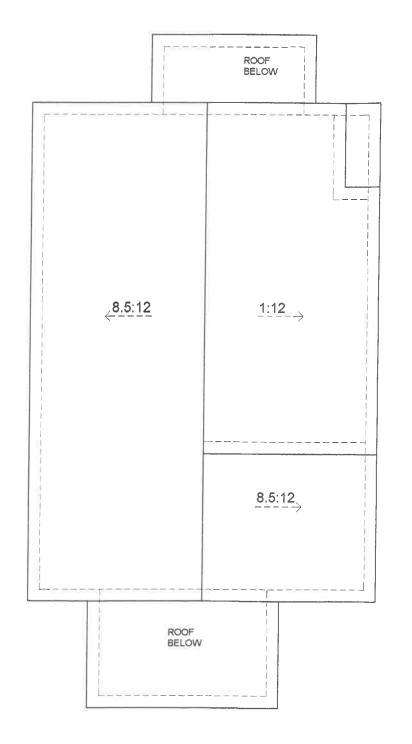
7/24/19 PLANNING BOARD REVIEW



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ATTIC CALCULATIONS

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6/6/19 REVIEW

7/24/19 PLANNING BOARD REVIEW




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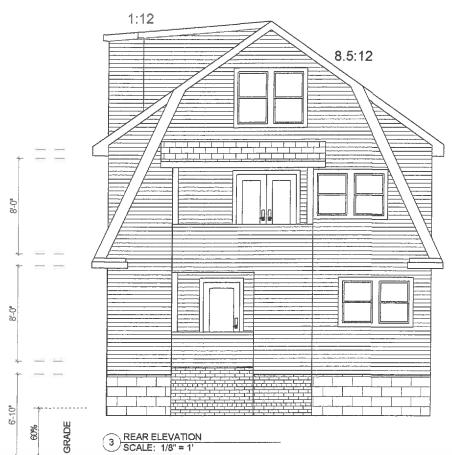
NEW ROOF PLAN


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1 PLAN SCALE: 1/8" = 0 5 10 15





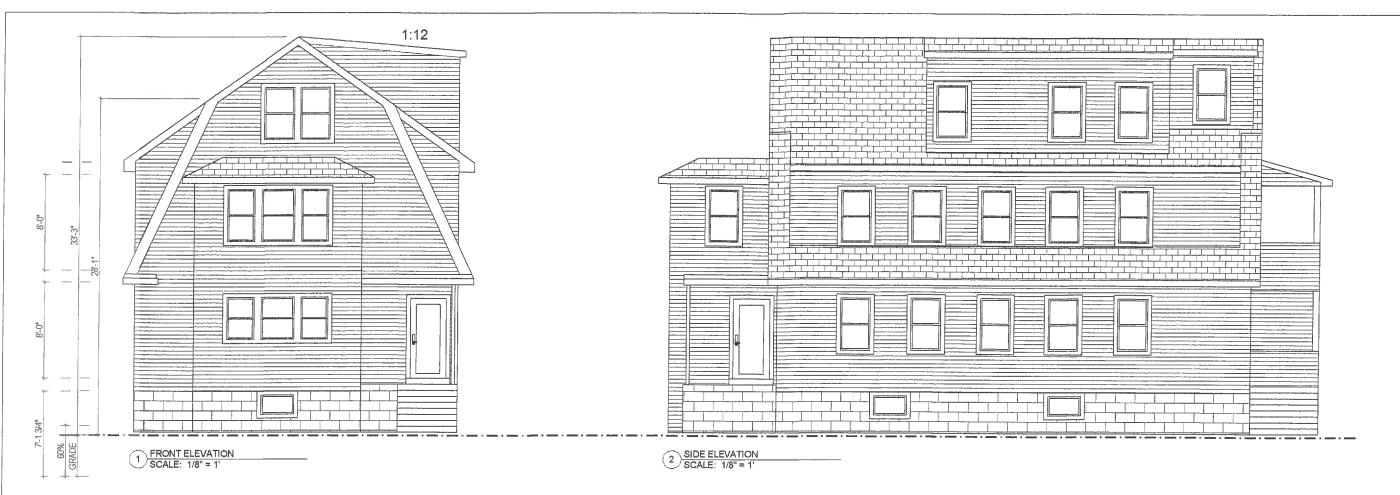

SIDE ELEVATION
SCALE: 1/8" = 1'
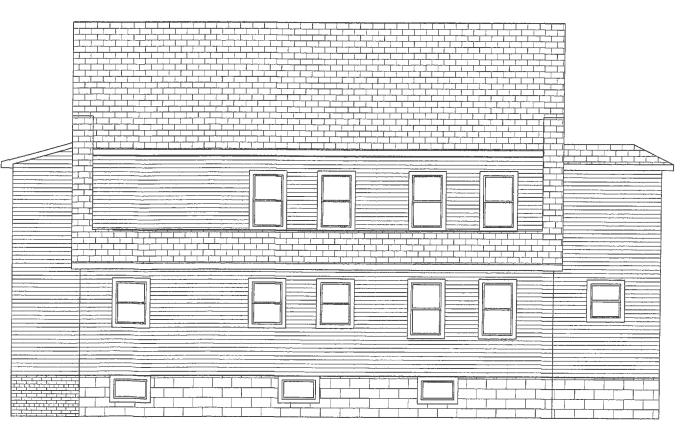
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NEW ELEVATIONS

Sheet Number,