

2018 JUL 11 PM 2: 07

CASE NO. 18-13

NOTICE OF PUBLIC HEARING BY THE PLANNING BOARD

ON APPLICATION FOR A SPECIAL PERMIT

Notice is hereby given that the Belmont Planning Board will hold a public hearing on TUESDAY, JULY 17, 2018, at 7:00 PM in the Board of Selectmen's Meeting Room, Town Hall, 455 Concord Ave., to consider the application of CRAIG GALLOWAY for A SPECIAL PERMIT under Section 4.2.2 (allowed height: 2-1/2 stories; existing: 3 stories; proposed: 3-1/2 stories) IN ORDER TO CONSTRUCT A DORMER at 45-47 CHANNING ROAD located in a General Residence Zoning District.

Planning Board



Town of Belmont Planning Board

APPLICATION FOR A SPECIAL PERMIT

Date: 6/1/18

Planning Board Homer Municipal Building 19 Moore Street Belmont, MA 02478

To Whom It May Concern:

Pursuant to the provisions of Massachuse	tts General Laws, Chapter 40A,
Section 9, as amended, and the Zoning By-Law	of the Town of Belmont, I/we the
undersigned, being the owner(s) of a certain pard	cel of land (with the buildings thereon)
situated on 45-47 Channa St	reet/Road hereby apply to your Board
for a SPECIAL PERMIT for the election or altera	tion on said premises or the use
thereof under the applicable Section of the Zoning	g By-Law of said Town for
dorner addition	
on the ground that the same will be in harmony	with the general purpose and intent of
said Zoning By-Law.	4
	11-18/1
Signature of Petitioner	fattaly
Print Name	CRAIG GALLOWAY
	45 CHANNING ROAD
	BELMONT, MA 02478
Daytime Telephone Number	617-839-3684

Request for Special Permit

Submitted by Craig Galloway – Owner of 45-47 Channing Road, Belmont, MA 02478

Introduction:

My name is Craig Galloway, owner of the 2-family home at 45-47 Channing Road in Belmont. I occupy the 2^{-1} floor unit at 45 Channing Road, which is the unit impacted by this Permit Request.

I have lived in Belmont for the past 16 years both renting and owning, purchasing this residence in January of 2017 to be closer to my two children, Collin age 13 and Aidan age 12, who also reside at 131 Cross Street with my ex-wife when they aren't with me.

The project I am proposing is for personal use as the primary residence for me and my family. It is my desire to create an environment that is safe, functional, of comparable comfort to my sons' home on Cross Street and, most importantly, to make the house more of a home for us all.

Project Description & Technical Aspects:

I am applying for special permit because my basement isn't far enough into the ground to be considered a cellar (it was calculated as 41% below grade, so it counts as a story) and to allow for a fractional increase to my presently non-conforming lot coverage.

Apart from those distinctions, everything in my proposed plans and presented here is fully compliant with current Belmont zoning criteria.

The primary element of my proposal is to convert my current half story into a safer, more livable space by raising the ridge line of the roof and adding a dormer that fully complies with Belmont zoning criteria for half story additions.

The current half story includes two existing rooms and a storage closet that we would like to reconfigure and increase slightly in area. Access to these two rooms is currently gained via an antiquated and unsafe spiral staircase. The issue with the current space, apart from the spiral stair access, is the ceiling height. It peaks at 6'6" in the center and drops with the slope of the roof leaving less than a 4-foot span side to side where a person of average height can stand fully upright (see pictures A, B, C, D & E). As such, the entire existing space and access to the space does not comply with current building code requirements for head height and is essentially unlivable for a full-sized adult (or growing teenage boys.) In addition, the windows on this level do not meet fire egress code and a lack of adequate insulation makes the space uncomfortable and expensive to heat and cool.

The main level includes 2 bedrooms and 1 full bath, along with the non-conforming spiral staircase (see Pictures F & G) that presents a major obstacle in the central transition space between the bedrooms and bathroom and the rest of the main floor. The staircase is both an eyesore and a hazard.

The proposed addition is largely the same as what exists today (2 rooms and closet storage with the addition of a full bath) in a slightly expanded layout designed to be safer and more livable by increasing the ceiling height and changing access into a walk-up staircase.

To achieve this design, we would raise the current ridge line by approximately 6 feet, which brings the midpoint elevation of the roof from 26.4' to 29', still well below the zoning allowance of 33'. We would also add a dormer to the West (driveway) side of the house, which fully conforms to the zoning allowance for side set-backs, being a full 15.8' from the property line on that side.

From an exterior standpoint, this design is fully in keeping with the look and feel of several other dormered two-family homes on Channing Road (see pictures H, I & J) and throughout Belmont. The house is also unique in that there are no neighboring homes directly behind (train tracks) or directly in front (entrance to Cross Street) of the property, so the changes to elevation and structure will have little to no impact on the sight views of my neighbors, whom I have consulted with and have support from.

As part of the work to perform this half story modification, I am also asking the Planning Board to approve a small, but functional 2nd story deck off of the back side of the house. The current nonconforming lot coverage is 31.8%, which the proposed deck would make 33.1%. The deck is proposed at the rear of the property directly facing the railroad tracks, making it completely non-invasive to neighbors and essentially equivalent to the 2nd floor outdoor spaces of my neighbors on both sides (see pictures K & L). It would have equivalent drainage implications to that of a patio with water passing through it; and it would result in zero loss of green space as it would be effectively cantilevered a full 14' above grade thus allowing the integration of outdoor space to the second floor unit without any actual loss of usable space at the ground level.

The Human Component:

I would like to note that I have spoken with and acquired signatures of support from my neighbors and that I have worked to create a design keeping in line with the planning board's stated objective, "to protect and preserve the character and quality of life that defines Belmont."

I have worked with Keith Miller of Miller Design, a local Belmont architect, to review options for creating a space more suitable to my family's needs while ensuring compliance with current zoning and building standards. In working with Keith, we believe the proposed addition is in keeping with the character of the neighborhood (as supported by photos of similar dormer projects 4 and 6 houses away) and truly represents an enhancement to the community by providing safer, more functional and more aesthetically designed space. I feel very strongly that with our thoughtful approach to design that includes considerations for building code and energy code compliance that this addition in not detrimental to the community.

I am asking the Planning Board of Appeals to grant a special permit allowing me to perform this renovation and sincerely appreciate your consideration.

Request for Special Permit

Submitted by Craig Galloway – Owner of 45-47 Channing Road, Belmont, MA 02478

Current non-conforming half story:




Picture A – Main Room




Picture B – Main Room – Facing Street



Picture C – Half Story Access / Sitting Room / Closet Door

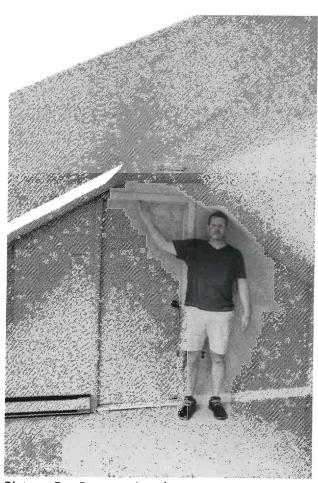

Picture D – Perspective shot

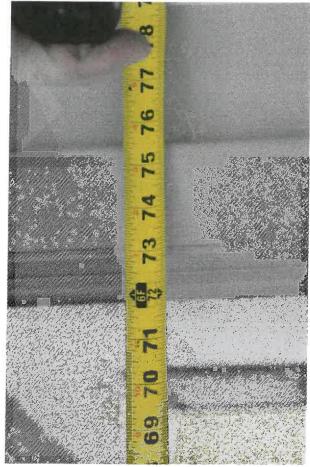


Picture E – Shows peak ceiling height of 6'6"

Current non-conforming spiral staircase:



Picture F – Non-conforming spiral stair – main level

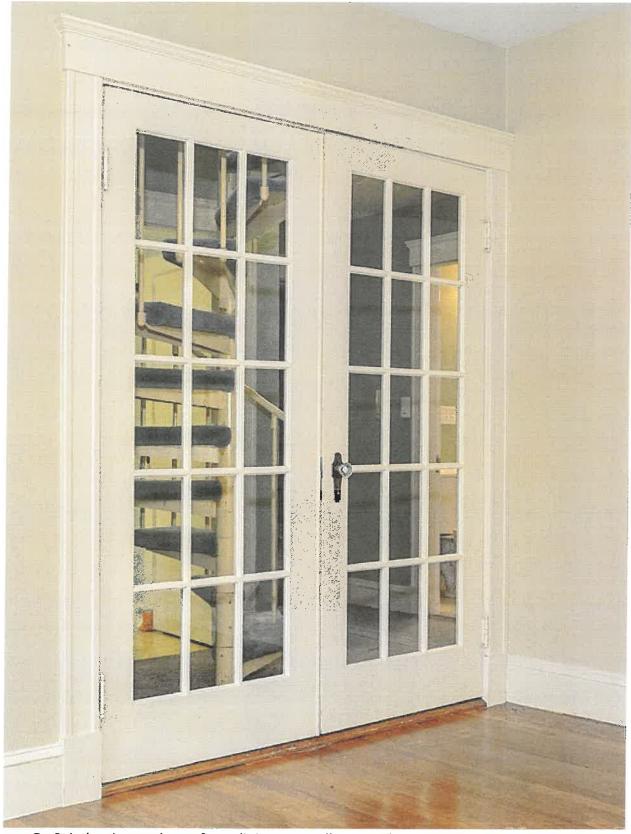

Picture G - Spiral staircase shown from dining room. Illustrates how the stairs restrict movement in the transition between dining room and kitchen and to the bedrooms and bathroom.

Existing Dormered 2 Family Homes Close By:



Picture H - 27-29 Channing Road



Picture I - 17-19 Channing Road




Picture J - 28-30 Cross Street

Existing Back Yard Outdoor Deck Space For Adjacent Neighbors:



Picture K – 39-41 Channing Road

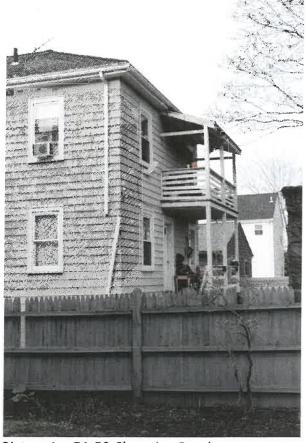

Picture L – 51-53 Channing Road

Petition For Belmont Planning Board - Request for Special Permit Craig Galloway - 45-47 Channing Road

6- 10 M

We, the neighbors of Craig Galloway of 45-47 Channing Road, Belmont MA have reviewed his plans to add a dormer and rear deck at the above-mentioned address. Furthermore, we support his petition for a special permit allowing him to proceed with this addition.

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1. Officeed And Adamyan (signature) (name) (address) (address) And Believed MA 02478
(signature) Berus Marion Bruno (name) 53 Channing Rd. (address)
(signature) (name) (address)
4. Karen Femless - KAREN FUNKEN STEIN (name) (signature) (name) (address) (address)
5. A. EunkenStein (4my) 29 manning Rd. Belmort MA 02478 (address)

6.		ALAN WHORNON
	(signature)	(name)
	33 Chauning	Ld.
	(address)	addition to the contract of the second state of the contract o
7.	(signature)	Julie Stantage Cidese
	35 Channing Road (address)	andankon, anda kan unun baringka ang ang di digang mang mang mang mang mang mang mang
8.	Ky M (signature)	KNE Guilbert
	37 Channing (address)	
9.	legit 5/	Tinho Lee
	(signature)	(name)
10.	(address) (address) (address)	Cocol Galloway (name)
*****	Jan Pasons (signature) 39 Chauning Rd	IAN PARSONS (name)
12.	(signature)	(name)
	(address)	

Zoning Compliance Check List

Properties Located within the GR Zoning Districts

(To be Completed by a Registered Land Surveyor)


Property Address: 45.47 CHANNING ROAD


Surveyor Signature and Stamp: Classification Date: 5/31/17

NO. 33(8)

gangan ann an an an ann ann ann ann ann				
Per §4.2 of the Zoning By-Laws				
* :		REQUIRED	EXISTING	PROPOSED
Lot Area (s	sq. ft.)		5,689	5,689
Lot Fronta	ge (feet)	55'		
Lot Area/U	Init (sq. ft./d.u.)		14.0 - 14	
Lot Covera	ige (% of lot)	30%	31,8 2	
Open Spac	ce (% of lot)	40%	45.5%	**************************************
	> Front	20'	15.8	25.9'
Setbacks: (feet)	> Side/Side	10' 10'	5.9 15.5	5,9 15,8
	> Rear	20'	29.8'	441
Building	> Feet			
Height:	> Stories	37,77,39,40,40,40,40,40,40,40,40,40,40,40,40,40,		And the state of t
1/2 Story	> Perimeter		~	***************************************
(feet)	> Area			
(Per §1.4)	> Length			
	Per §6D of the Zoning By-Laws			
,	- Market	REQUIRED	EXISTING	PROPOSED
Front	> Face Street		*	
Doors:	➢ Setback	7	THE RESIDENCE OF THE PROPERTY	- Material management and a second a second and a second
Curb Cut				
. 13.12 m	> Front Yard			
HVAC:	> Side/Rear Setbacks			

SUBMIT CALCULATIONS for all of the requirements listed above on a separate piece of paper(s) to verify how they were calculated

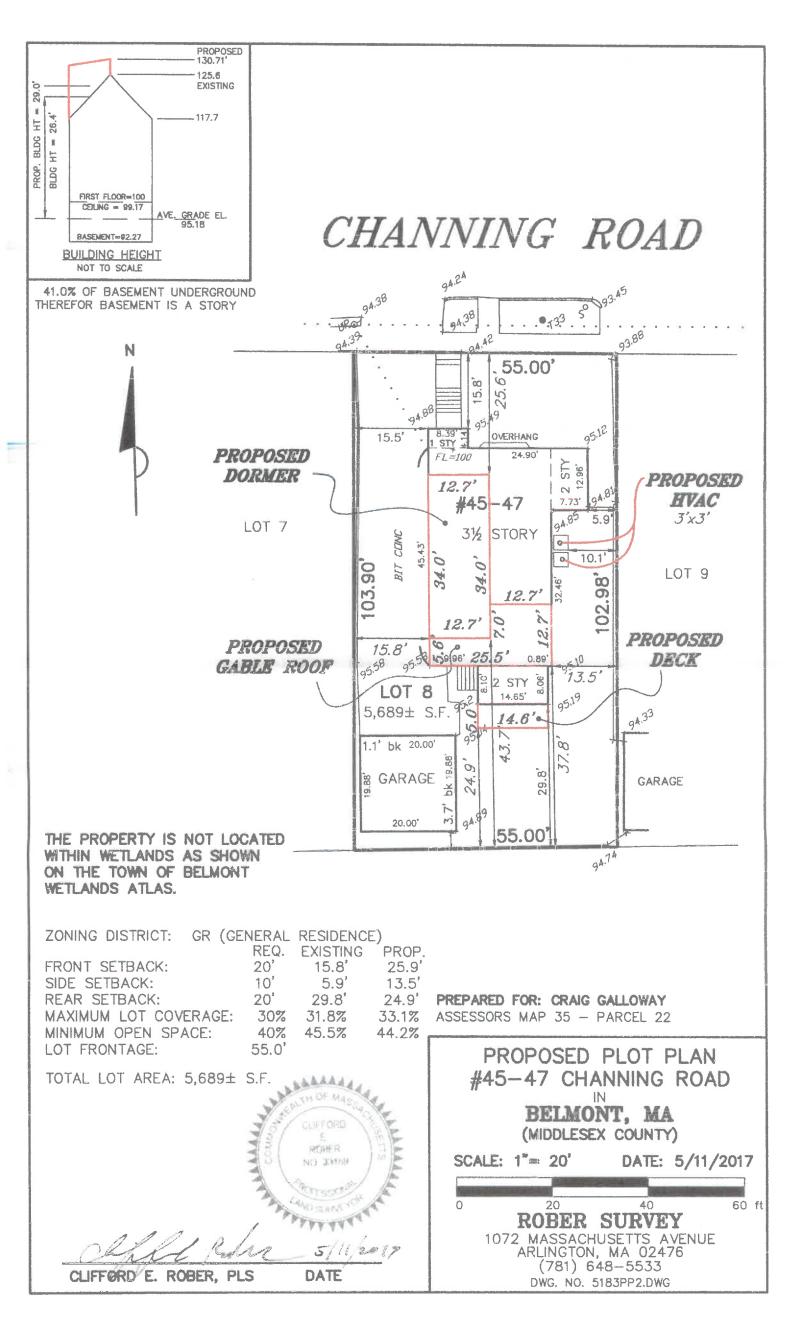

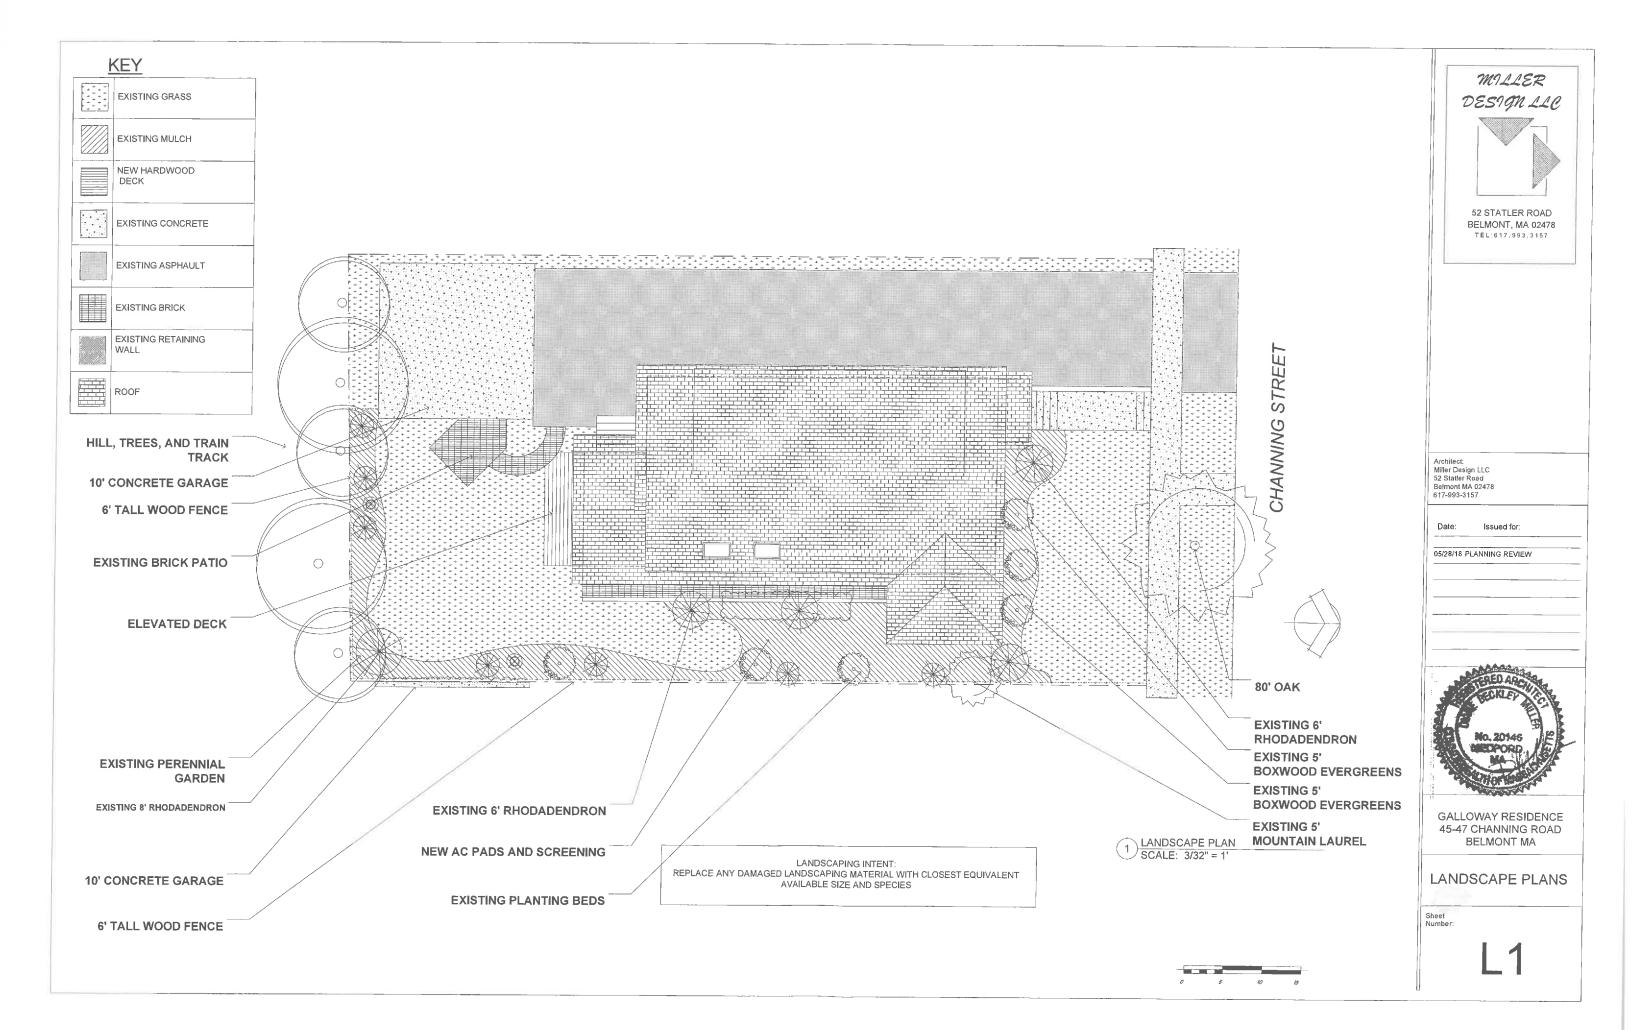

GENERAL NOTES

- COORDINATE AND BE RESPONSIBLE FOR THE PROTECTION OF PERSONS AND PROPERTY FOR THE DURATION OF CONSTRUCTION AS REQUIRED BY AGENCIES AND AUTHORITIES HAVING JURISDICTION.
- 2. DO NOT DAMAGE BUILDING ELEMENTS AND IMPROVEMENTS INDICATED TO REMAIN.
 3. DO NOT INTERRUPT UTILITIES WITHOUT THE WRITTEN PERMISSION OF THE OWNER.
 4. REMOVE SALVAGE AND DEBRIS FROM THE SITE AS IT ACCUMULATES. DO NOT STORE, SELL, BURN OR OTHERWISE DISPOSE OF THE DEBRIS ON THE SITE. KEEP ALL PAVEMENTS AND AREAS ADJACENT TO AND LEADING FROM THE SITE CLEAN AND FREE OF MUD. DIRT. AND DEBRIS AT ALL TIMES. ALL MATERIALS SHALL BE DISPOSED OF IN A LEGAL MANNER.
 5. SORT DEBRIS FOR RECYCLING TO THE EXTENT POSSIBLE. REMOVE OR ARRANGE FOR THE TRANSPORT OF SORTED MATERIALS SCHEDULED TO BE RECYCLED TO APPROPRIATI OFF-SITE FACILITIES EQUIPPED FOR THE RECYCLING OF SPECIFIC MATERIALS. PROVIDE CONTAINERIZED DUMPSTERS FOR THE SORTING OF DEMO WASTES.
- 6. CEASE OPERATIONS IF PUBLIC SAFETY OR REMAINING STRUCTURES ARE ENDANGERED. PERFORM TEMPORARILY CORRECTIVE MEASURES UNTIL OPERATIONS CAN BE CONTINUED PROPERLY.
- 7. ALL INTERIOR DIMENSIONS ARE FROM FACE OF GWB TO FACE OF GWB UNLESS SPECIFICALLY NOTED OTHERWISE. DO NOT SCALE DRAWINGS.
- CONTRACTOR TO COORDINATE THE LOCATION OF ELECTRICAL OUTLETS TO MEET CODE.
 CONTRACTOR TO UPGRADE ELECTRICAL PANEL AS NEEDED TO ACCOMMODATE NEW
- 9. PAINT AND/OR STAIN ALL EXTERIOR SIDING, DOORS, WINDOWS, AND TRIM AND INTERIOR SURFACES PER OWNERS DIRECTION.
- 10. ALL PLUMBING AND LIGHTING FIXTURES TO BE FURNISHED BY OWNER, INSTALLED BY 11. CONTRACTOR TO INSTALL AND COORDINATE ALL HVAC EXTENSIONS AND RENOVATIONS
- INTO NEW SPACE AS REQUIRED.

 12. ALL HVAC, PLUMBING, ELECTRICAL, AND FIRE PROTECTION TO BE DESIGN BUILD
- PROVIDE FIRE EXTINGUISHERS AS REQUIRED BY FIRE INSPECTOR

GENERAL CONDITIONS

- 1. G. C. MUST BUILD EXACTLY WHAT IS SHOWN ON FRAMING PLANS, ANY PROPOSED DEPARTURES FROM WHAT IS INDICATED MUST BE REVIEWED WITH THE ARCHITECT PRIOR TO CONSTRUCTION. ALL UNAUTHORIZED CHANGES TO THE APPROVED DRAWINGS MUST BE REMOVED AND REPLACED AT THE CONTRACTOR'S EXPENSE.
- 2. DESIGN IS DERIVED FROM ASSUMED FIELD CONDITIONS. ANY DISCREPANCIES
 BETWEEN WHAT IS SHOWN ON OUR DOCUMENTS AND WHAT IS FOUND IN THE FIELD MAY CHANGE THE STRUCTURAL DESIGN, AND MUST IMMEDIATELY BE BROUGHT TO THE ARCHITECT'S ATTENTION PRIOR TO ANY CONSTRUCTION.
- 3. THE CONTRACTOR SHALL CAREFULLY VERIFY ALL DIMENSIONS AND CONDITIONS SHOWN ON DRAWINGS PRIOR TO COMMENCEMENT OF THE WORK, AND SHALL NOTIFY THE ARCHITECT IMMEDIATELY OF ANY DISCREPANCIES BETWEEN DOCUMENTS,
- 4. THE CONTRACTOR IS RESPONSIBLE FOR ALL MEANS AND METHODS OF TEMPORARY SHORING, BRACING, OR OTHERWISE PROTECTING ANY PORTION OF THE STRUCTURE, SITE AND UTILITIES FROM DAMAGE DURING CONSTRUCTION. THE ARCHITECT IS SPECIFYING THE FINISHED CONDITION ONLY, WITHOUT ASSUMING KNOWLEDGE NOR RESPONSIBILITY FOR HOW THE CONTRACTOR WILL ACHIEVE THIS RESULT. 5. FOR EXACT LOCATIONS OF FLOOR AND ROOF OPENINGS, POSTS, ETC., SEE

INSULATION:

CONTRACTOR TO SPRAY APPLY ICYNENE INSULATION FORMULA APPLIED TO A THICKNESS ADEQUATE TO ACHIEVE SPECIFIED R VALUES. ALL FOUNDATION SILL PLATES AND FLOOR / WALL JUNCTION PLATES TO BE CAULKED TO AVOID AIR LEAKAGE. ALL ROUGH OPENINGS FOR EXTERIOR DOORS AND WINDOWS TO BE SIZED TO FURNISH A MINIMUM 1/2" SPACE AROUND THE PERIMETER OF FRAME TO PERMIT INSTALLATION OF FOAM INSULATION. ALL JOINTS BETWEEN EXTERIOR FRAMING MEMBERS TO BE CAULKED TO AVOID AIR LEAKAGE. CEILING VAPOR BARRIER TO BE CAULKED AND STAPLED TO THE TOP PLATES OF INTERIOR PARTITIONS AND TO THE LOWER TOP PLATES OF EXTERIOR WALLS. ROOF ASSEMBLY TO BE NON-VENTED (NO SOFFIT OR RIDGE VENTS) PER MFGR SPECS FOR ICYNENE INSULATION SYSTEM. BUILDING TO BE MECHANICALLY VENTED. ALL VERTICAL WIRING FOR ELECTRIC, CABLE, TELEPHONE, SECURITY, ETC, SHALL BE SECURED TO THE INSIDE OF STUDS EVERY 3-0" AND 1 1/2" FROM THE GWB SURFACE FOR ALL RUNS. CEILING OUTLETS SHALL BE INSTALLED USING VAPOR BARRIER PANS/ BOXES WHICH ARE CAULKED WITH ACOUSTICAL CAULKING MATERIAL PRIOR TO THE INSTALLATION OF THE ATTIC INSULATION.



PLANNING BOARD SUBMISSION **AUGUST 08, 2017**

NEW 1/2 STORY DORMER ADDITION

DRAWING LIST

- A1 COVER SHEET
- A2 EXISTING PLANS / AREA DIMENSIONS
- EXISTING FIRST /SECOND FLOOR PLANS
- A4 EXISTING ROOF & ATTIC PLANS
- A5 **EXISTING ELEVATIONS**
- A6 EXISTING ELEVATIONS
- A7 NEW 2ND FLOOR LAYOUT PLANS
- A8 NEW HALF STORY LAYOUT PLANS
- A9 NEW ROOF PLAN / SECTION A10 NEW LAYOUT ELEVATIONS
- A11 NEW LAYOUT ELEVATIONS

SYMBOL LEGEND

COMMISSION WALL TO BE DEMOLISHED

EXISTING WALL TO REMAIN

NEW WALL



(5)

DOOR TAG



RECESSED CAN LIGHT AS SELECTED BY OWNER

WALL MOUNTED SCONCES AS SELECTED BY OWNER

PROJECT INFORMATION: PER ZONING AMENDMENTS DATED 11/26/2012 BELMONT ZONING DISTRICT GR:

FRONT YARD SETBACK: 20'-0" (CHANNING STREET UNCHANGED) - 15.8' REAR YARD SETBACK: 20'-0" (UNCHANGED) - 29.8' SIDE YARD SETBACK: 10'-0" (UNCHANGED) - 15.5/13.63 (SURVEY) FRONTAGE: 50'-0" (EXISTING 55'-0" COMPLIES) LOT AREA: 5000SQFT (UNCHANGED) 5689SQFT EXISTING MAX HEIGHT: 33'/2.5 STORIES (32'-11" PROPOSED CONFORMING)

ENERGY AUDIT:

COMPLIANCE DETERMINED BY MASSACHUSETTS STRETCH ENERGY CODE (IECC 2009 W/ MASSACHUSETTS AMENDMENTS 780 CMR 115.11).

PRESCRIPTIVE OPTION FOR RESIDENTIAL ADDITION (401.3):

- 1. RENOVATION TO COMPLY WITH ENERGY STAR QUALIFIED HOMES THERMAL BYPASS INSPECTION CHECKLIST. INSULATION VALUES AS FOLLOWS: R38 ROOF R-VALUE, R20 WALL R-VALUE, R30 FLOOR R-VALUE, R10 CRAWL SPACE WALL R-VALUE.
- 2. RENOVATION TO COMPLY WITH ENERGY STAR PROGRAM REQUIREMENTS FOR RESIDENTIAL WINDOWS, DOORS, AND SKYLIGHTS - VERSION 5.0. ALL NEW WINDOW GLAZING W/ .30 U FACTOR.
- 3. HEATING / COOLING DUCTS TO BE SEALED AND TESTED TO MEET REQUIREMENTS OF 401.3.



MILLER



52 STATLER ROAD BELMONT, MA 02478 TEL:617.993,3157

Architect: Miller Design LLC 52 Statler Road Belmont MA 02478 617-993-3157

Issued for Date: SCHEMATIC DESIGN 05/08/17 PLANNING REVIEW 08/08/17 REV 1



GALLOWAY RESIDENCE 45-47 CHANNING ROAD BELMONT MA

COVER SHEET


Number

ADDITION LOCATION

SECOND FLOOR	1370 SQFT
HALF STORY OVER 5'-0"	813 SQFT
1408SQFT X 60% = 845SQF THEREFOR COMPLIES	
PERIMETER DORMER CALCULATION	<u>ON</u>
SECOND FLOOR	174'-1"
AREA WITH RAFTERS AT 3' OF GREATER	78'-3"
ALLOWABLE LENGTH OF WALLS WITH RAF GREATER = 174'-1" X 50% = 87' MAXIM	
DORMER LENGTH CALCULATION	
EXISTING ROOF LINE	45'-5"
NEW DORMER	34'-0 1/2"

GROSS AREA CALCUATIONS	
BASEMENT FLOOR AREA	1253 SQFT
FIRST FLOOR AREA	1405 SQFT
SECOND FLOOR AREA	1370 SQFT
THIRD FLOOR AREA (ABOVE 5'-0")	96 SQFT
ADDITIONAL GROSS AREA (714SQFT - 96SQFT) =	717 SQFT
EXISTING GROSS AREA (MEASURED)	4,124 SQFT
717 SQFT / 4,124 SQFT = 17% INCREAS	E (COMPLIES)

HALF STORY NET AREA INCREASE		
3RD FLOOR NET AREA EXISTING	512 SQFT	
3RD FLOOR PROPOSED NET AREA	813 SQFT	
TOTAL ADDITIONAL NET AREA = 813SQFT - 512SQFT = 201SQFT		

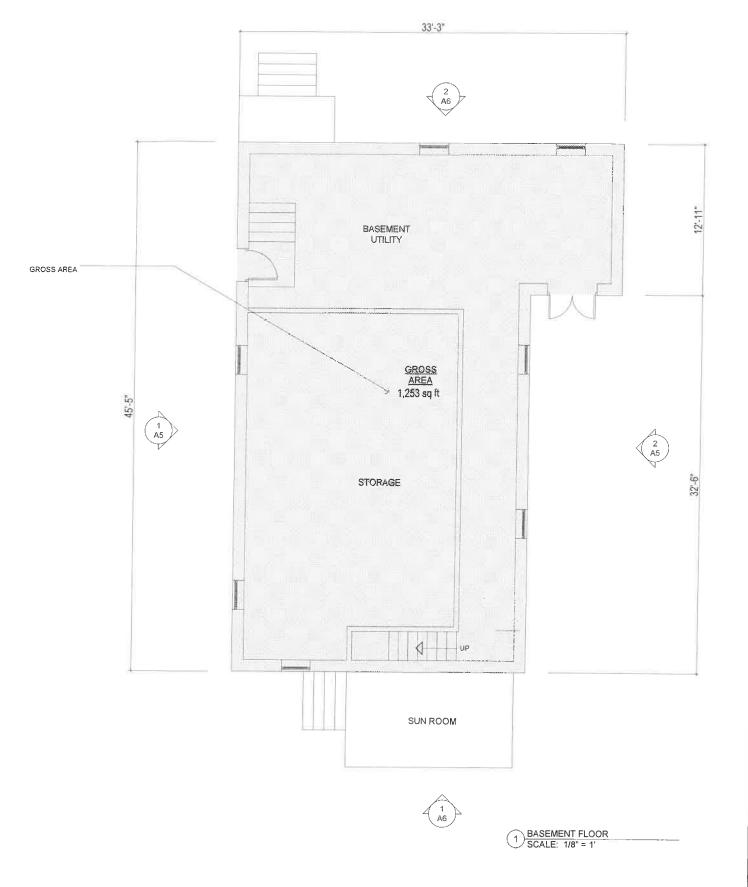



Architect: Miller Design LLC 52 Statter Road Belmont MA 02478 617-993-3157

Date: Issued for:

 05/08/17
 SCHEMATIC DESIGN

 05/26/17
 PLANNING REVIEW

08/11/17 REV 1

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GALLOWAY RESIDENCE 45-47 CHANNING ROAD BELMONT MA

FLOOR PLANS

Sheet Number:









52 STATLER ROAD BELMONT, MA 02478 TEL:617.993.3157

Architect: Miller Design LLC 52 Statler Road Belmont MA 02478 617-993-3157

Date: Issued for:

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05/26/17 PLANNING REVIEW

TRED AGE





GALLOWAY RESIDENCE 45-47 CHANNING ROAD BELMONT MA

FLOOR PLANS

Sheet Number:

10

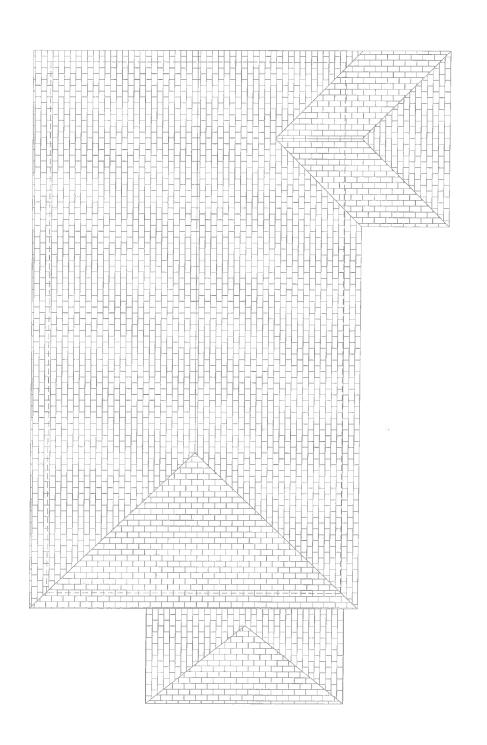

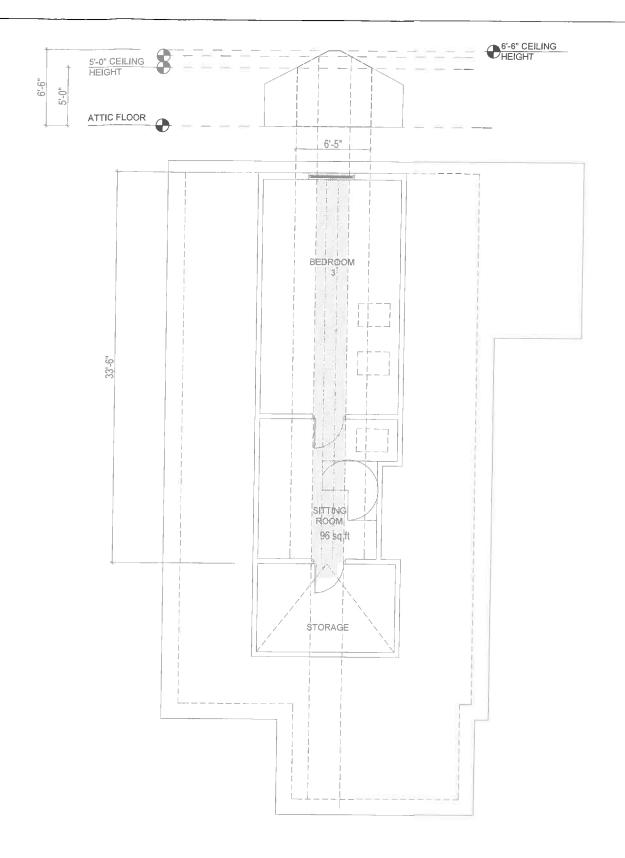

2 ROOF PLAN SCALE: 1/8" = 1'

1 ATTIC FLOOR SCALE: 1/8" = 1'



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52 STATLER ROAD BELMONT, MA 02478 TEL 617,993,3157

Architect: Miller Design LLC 52 Staller Road Belmont MA 02478 617-993-3157

Date: Issued for:


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GALLOWAY RESIDENCE 45-47 CHANNING ROAD BELMONT MA

FLOOR PLANS

Sheet Number:



2 EAST ELEVATION SCALE: 1/8" = 1'

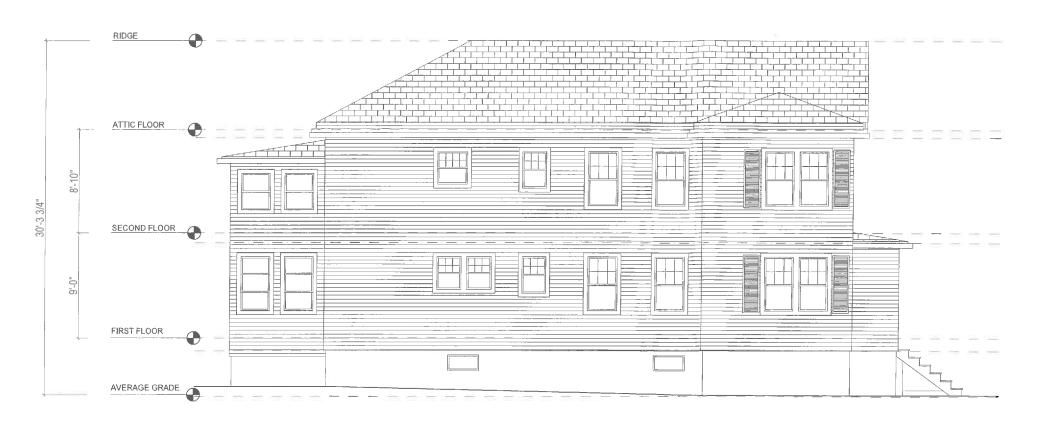

WEST ELEVATION
SCALE: 1/8" = 1'





Architect:
Miller Design LLC
52 Statler Road
Belmont MA 02478
617-993-3157

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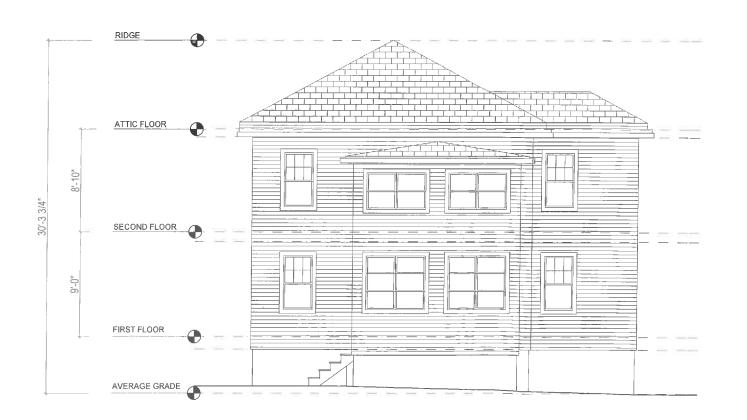


GALLOWAY RESIDENCE 45-47 CHANNING ROAD BELMONT MA

EXISTING ELEVATIONS

She







2 NORTH ELEVATION SCALE: 1/8" = 1'

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Date: Issued for:

05/08/17 SCHEMATIC DESIGN

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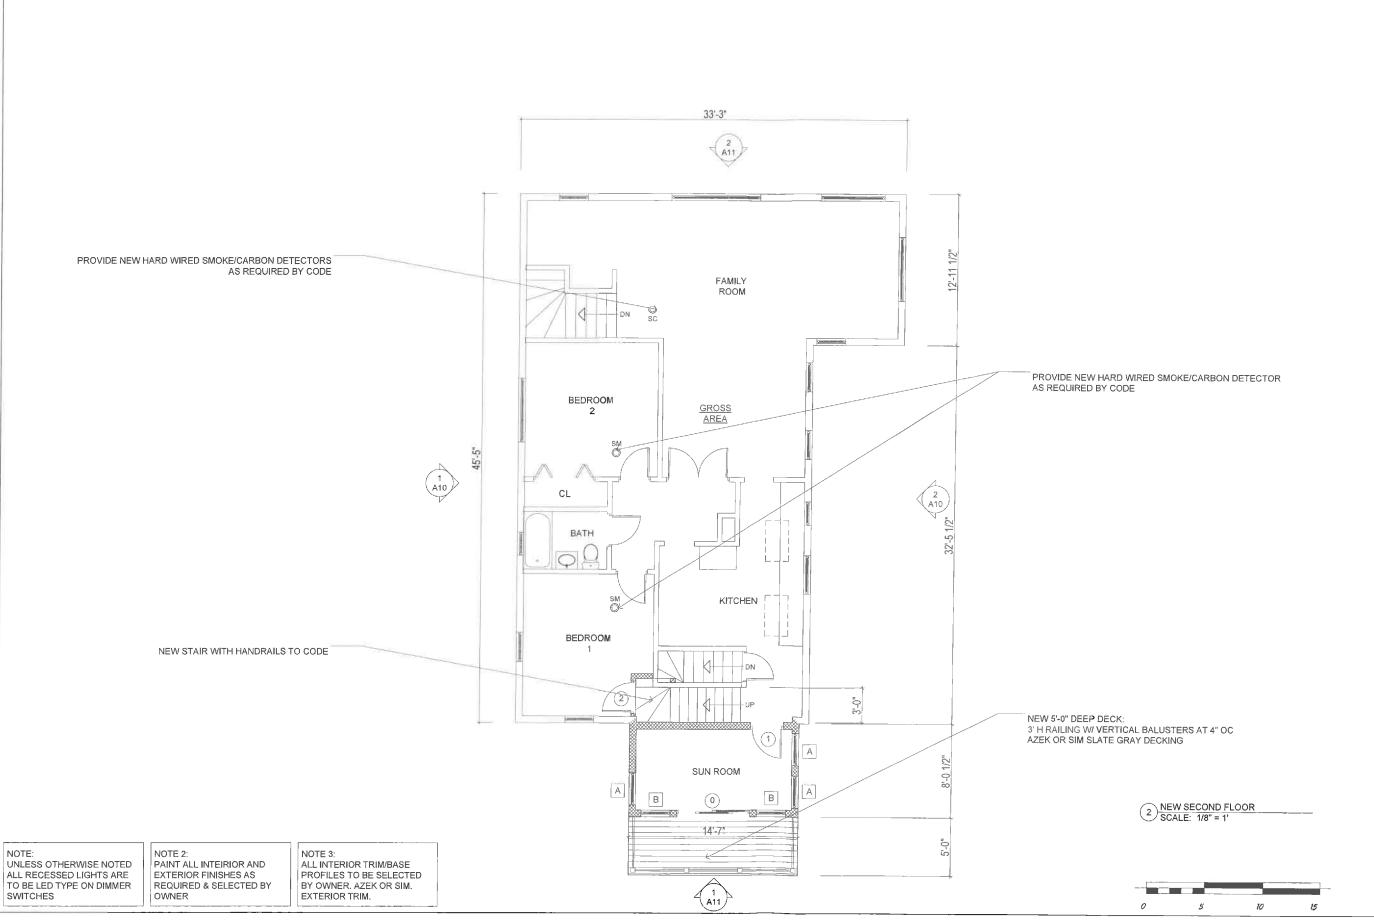
GALLOWAY RESIDENCE 45-47 CHANNING ROAD BELMONT MA

EXISTING ELEVATIONS

Sheet Number:

A6

SOUTH ELEVATION
SCALE: 1/8" = 1'



MILLER DESIGN LLC



52 STATLER ROAD BELMONT, MA 02478 TEL:617.993.3157

Architect: Miller Design LLC 52 Statler Road Belmont MA 02478 617-993-3157

Date: Issued for:

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05/26/17 PLANNING REVIEW


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GALLOWAY RESIDENCE 45-47 CHANNING ROAD BELMONT MA


FLOOR PLANS


Sheet Number:



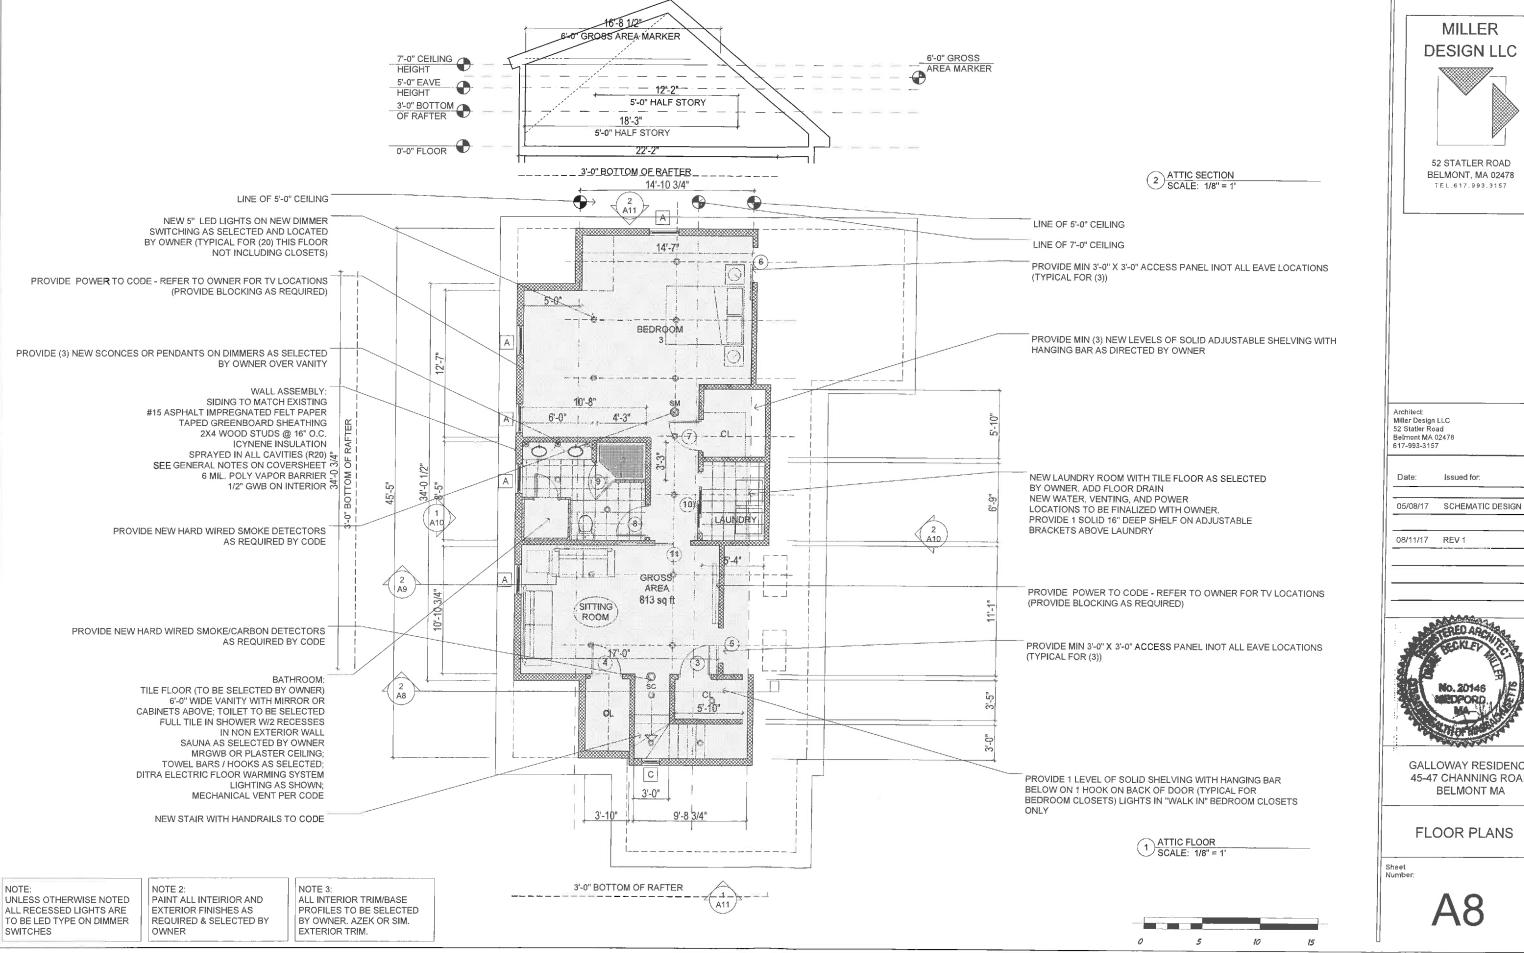

GALLOWAY RESIDENCE 45-47 CHANNING ROAD BELMONT MA

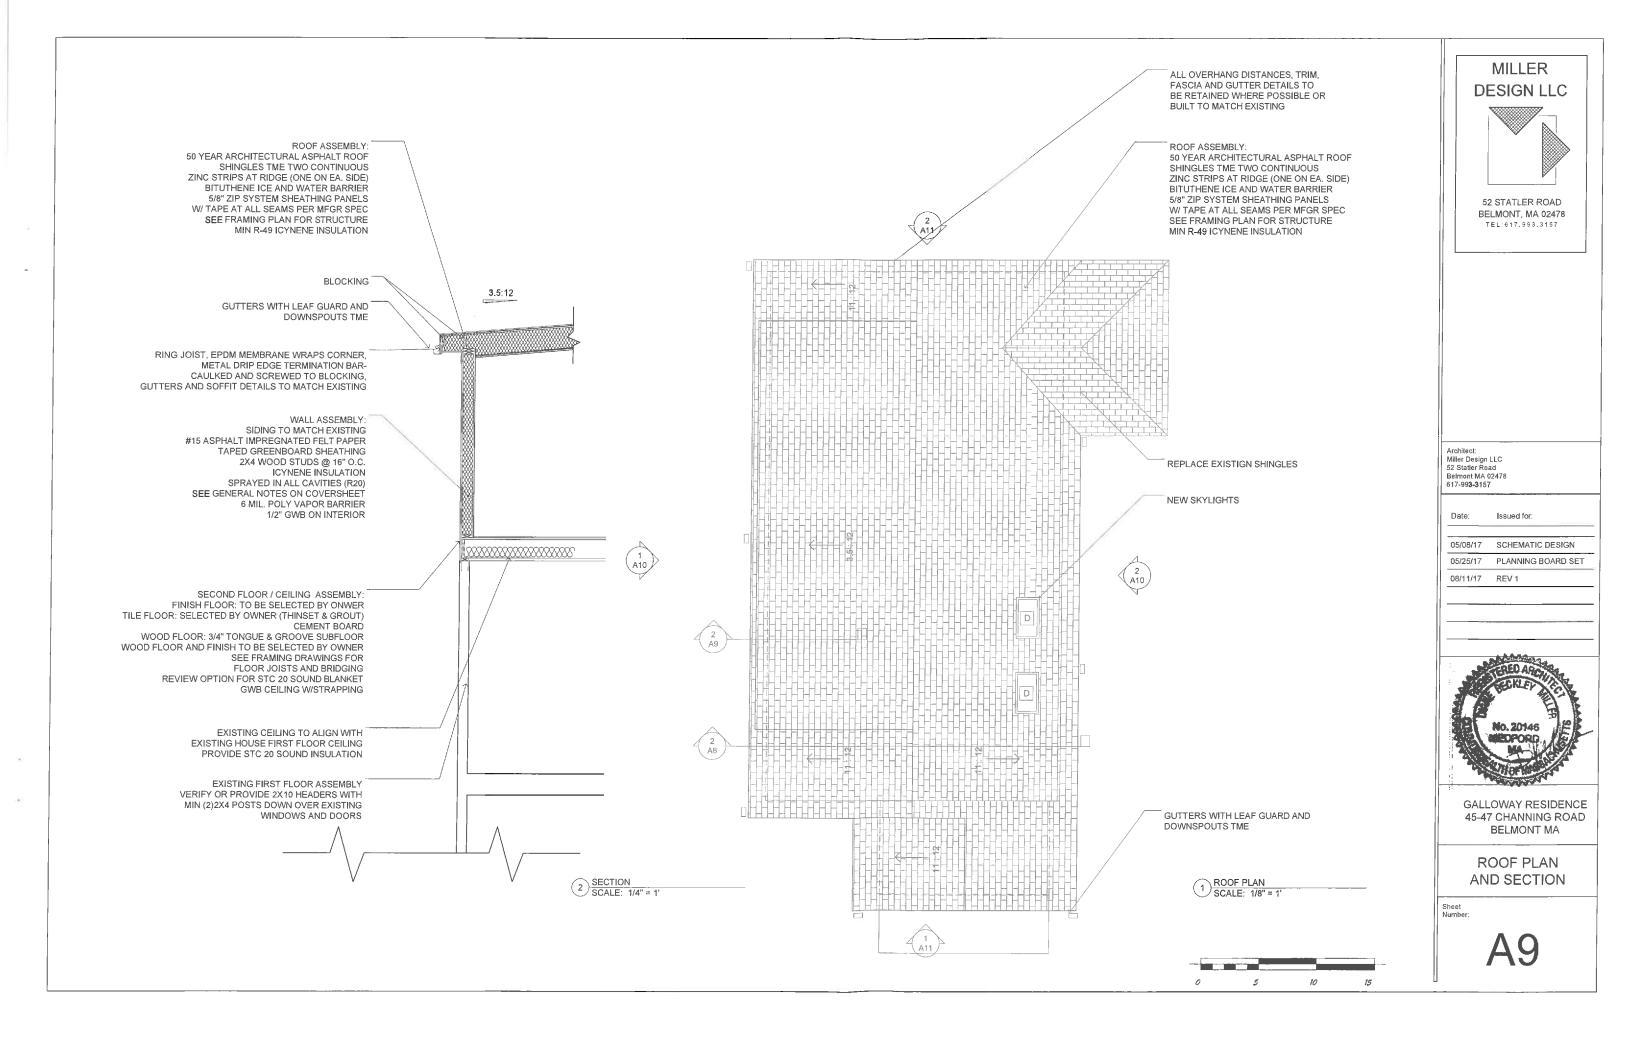

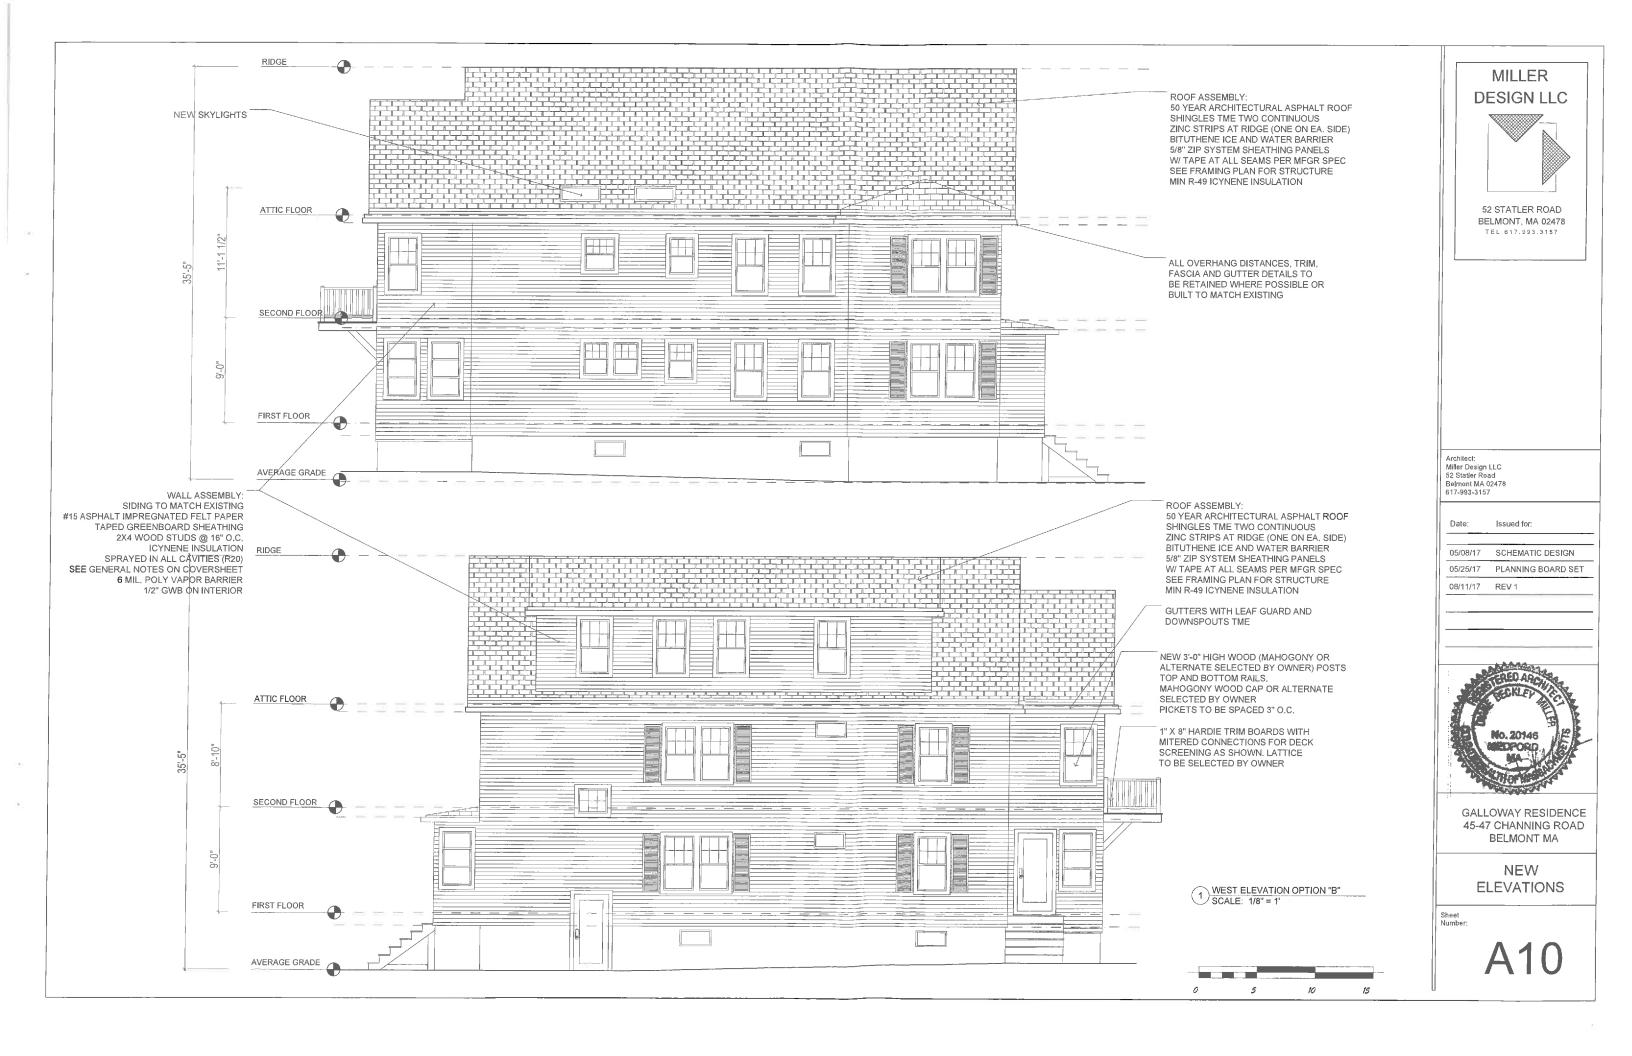



MILLER DESIGN LLC



52 STATLER ROAD BELMONT, MA 02478 TEL:617.999.3157

Architect: Miller Design LLC 52 Statler Road Belmont MA 02478 617-993-3157

Date: Issued for:

05/08/17 SCHEMATIC DESIGN

05/25/17 PLANNING BOARD SET

11/17 DEV/ 1

08/11/17 REV 1

RED ARCHES

GALLOWAY RESIDENCE 45-47 CHANNING ROAD BELMONT MA

> NEW ELEVATIONS

Sheet