Case # HDC 20-12

NOTICE OF PUBLIC HEARING BY THE HISTORIC DISTRICT COMMISSION

APPLICATION FOR A CERTIFICATE OF APPROPRIATENESS

Notice is hereby given that the Belmont Historic District Commission will hold a public hearing on **THURSDAY**, **November 12**, **2020 at 7:00 PM** via remote access*, to consider the application of Matt and Steph Schonewald for a **CERTIFICATE OF APPROPRIATENESS** in order to move and replace a rear facing window at 548 Pleasant Street, located in the Pleasant Street Historic District.

Belmont Historic District Commission

* Application submittals, meeting agenda and instructions on remote access can be found on the Town's website <u>https://www.belmont-ma.gov/historic-district-</u> <u>commission</u>

I.WOL	OFFICE USE			
Town Belmont Historic District Commission	Case Number: HDC –			
Historic District Commission Homer Municipal Building, 2nd F	oor			
19 Moore Street				
Belmont, MA 02478				
APPLICATIO	<u>ــــــــــــــــــــــــــــــــــــ</u>			
In accordance with the Historic Districts Act, MGL Ch 40C,	•			
§40-315, the undersigned applies to the Belmont Histori				
X Appropriateness Non-Applicabili	ty 🔄 Hardship			
1. PRELIMINARY INFORMATION:				
Address of Property: 548 Pleasant St, Belmont,				
Property Owner's Name: <u>Matt and Steph Schonewald</u> Address: <u>548 Pleasant St</u> , Belmont, MA 02478				
Email: Enohcs@gmail.com	Phone: 303-884-8261			
Agent Name:				
Address: Email:	Phone:			
I am the : X Property Owner Agen				
Property is Owned by a Corporation, LLC, or Trust (Submit auth	prization to sign as owner)			
Property is a Condominium or Cooperative Association (submit	authorization to sign as trustee)			
If applicable: Architect: Miller Design Contra	ictor:			
2. BRIEF DESCRIPTION OF PROPOSED WORK:				
Second floor bathroom renovation that wil	l result in a rear facing window			
moving approximately 5 ft	rebuit in a rear racing window			
3. <u>SIGNATURES</u> :				
As Owner, I make the following representations:				
 A. I hereby certify that I am the Owner of the Property at: <u>5</u> B. I hereby certify that if an Agent is listed on this Application 				
Application before the Belmont Historic District Commissio				
Owner:	Date : <u>10/15/20</u>			
As Applicant/Agent, I make the following representations:				
1. The information supplied on and in this Application is accu	rate to the best of my knowledge;			
 I will make no changes to the approved plans without prior approval from the Belmont Historic District 				
Commission.	D .1.			
Applicant/Agent:	Date:			
st Incomplete applications and Insufficient documentation will not be accepted. st				
	Approved March 23, 2017			

Pella Architect Series[®] Traditional – Hung Windows

Aluminum EnduraClad® Exterior — LX and SE Double-, Single- and Simulated-Hung

Detailed Product Descriptions

Frame

- Select softwood, immersion treated with Pella's EnduraGuard® wood protection formula in accordance with WDMA I.S.-4. The EnduraGuard formula includes three active ingredients for protection against the effects of moisture, decay, stains from mold and mildew. Plus, an additional ingredient adds protection against termite damage.
- Interior exposed surfaces are [LX: [clear pine] [mahogany] [douglas fir]] [SE: clear pine].
- Exterior surfaces are clad with aluminum.
- Components are assembled with screws, staples and concealed corner locks.
- Overall frame depth is 5" (127 mm) for a wall depth of 3-11/16" (94 mm).
- Optional factory applied jamb extensions available between 4-9/16" (116 mm) and 7-3/16" (183 mm) wall depths.
- Vinyl jamb liner [LX includes wood / clad inserts].
- Optional factory installed fold-out installation fins with flexible fin corners.
- Optional factory-applied EnduraClad® exterior trim.

Sash

- Select softwood, immersion treated with Pella's EnduraGuard® wood protection formula in accordance with WDMA I.S.-4. The EnduraGuard formula includes three active ingredients for protection against the effects of moisture, decay, stains from mold and mildew. Plus, an additional ingredient adds protection against termite damage.
- Interior exposed surfaces are [LX: [clear pine] [mahogany] [douglas fir]] [SE: clear pine].
- Exterior surfaces are clad with aluminum and sealed.
- Corners mortised and tenoned, glued and secured with metal fasteners.
- Sash thickness is 1-7/8" (47 mm).
- Sash exterior and interior profile is ogee.
- Double-Hung: Upper sash has surface-mounted wash locks] [Single-Hung: Fixed upper sash has surface-mounted wash locks] [Arch Head units have no wash locks].
- Lower sash has concealed wash locks in lower check rail.
- Sashes tilt for easy cleaning.
- Simulated-Hung units have non-operable upper and lower sashes.

Weatherstripping

- Water-stop santoprene-wrapped foam at head and sill.
- Thermoplastic elastomer bulb with slip-coating set into lower sash for tight contact at check rail.
- Vinyl-wrapped foam inserted into jamb liner to seal against sides of sash.

Glazing System

- Quality float glass complying with ASTM C 1036.
- Custom and high altitude glazing available.
- Silicone-glazed 11/16" dual-seal insulating glass [[annealed] [tempered]] [[clear] [[Advanced Low-E] [SunDefense[™] Low-E] [AdvancedComfort] [NaturalSun Low-E] with argon]] [[bronze] [gray] [green] Advanced Low-E with argon].

Exterior

- Aluminum-clad exteriors shall be finished with EnduraClad® protective finish, in a multi-step, baked-on finish.
 - Color is [standard] [custom]1.

- Aluminum-clad exteriors shall be finished with EnduraClad Plus protective finish with 70% fluoropolymer resin in a multi-step, baked-on finish.
 - Color is [standard] [custom]₁.

Interior

• [Unfinished, ready for site finishing] [factory primed with one coat acrylic latex] [factory prefinished [paint] [stain] 1].

Hardware

- Galvanized block-and-tackle balances are connected to self-locking balance shoes which are connected to the sashes using zinc die cast terminals and concealed within the frame.
- Sash lock is [standard (cam-action)] [historic spoon-style] [air-conditioner lock] [simulated lock (Single-piece lock ties upper and lower sash together. When removed, lower sash becomes operable)]. Two sash locks on units with frame width 37" and greater.
- Optional sash lift furnished for field installation. Two lifts on units with frame width 37" and greater.
- Hardware finish is [baked enamel [Champagne] [White] [Brown] [Matte Black]] [Bright Brass] [Satin Nickel] [Oil-rubbed Bronze] [Antique Brass] [Distressed Bronze] [Distressed Nickel].

Optional Products

Grilles

- Integral Light Technology[®] grilles
 - Interior grilles are [5/8"] [7/8"] [1-1/4"] [2"] ogee profile that are solid [LX: [pine] [mahogany] [douglas fir]] [SE: pine]. Interior surfaces are [unfinished, ready for site finishing] [factory primed] [pine: factory prefinished [paint] [stain] 1].
 - Exterior grilles are [5/8" putty glaze profile] [7/8" [putty glaze] [ogee] profile] [1-1/4" [putty glaze] [ogee] profile] [2" ogee profile] that are extruded aluminum.
 - Patterns are [Traditional] [Prairie] [Top Row] [New England] [Victorian].
 - Insulating glass contains non-glare spacer between the panes of glass.
 - Grilles are adhered to both sides of the insulating glass with VHB acrylic adhesive tape and aligned with the non-glare spacer.
- Grilles-Between-the-Glass₂
 - Insulating glass contains 3/4" contoured aluminum grilles permanently installed between two panes of glass.
 - Patterns are [Traditional] [9-Lite Prairie] [Cross] [Top Row]
 - Interior color is [White] [Tan₃] [Brown₃] [Putty₃] [Black] [Morning Sky Gray] [Ivory] [Sand Dune] [Harvest] [Cordovan] [Brickstone].
 - Exterior color₅ is [standard₁].

– or –

– or –

- Roomside Removable grilles
 - [[3/4"] [1-1/4"] [2"] regular] [[1-1/4"] [2"] colonial] profile, with [Traditional] [Prairie] patterns that are removable solid pine wood bars steelpinned at joints and fitted to sash with steel clips and tacks.
 - Interior [unfinished, ready for site finishing] [factory primed] [pine: factory prefinished [paint] [stain] 1].
 - Exterior [unfinished, ready for site finishing] [factory primed] [finish color matched to exterior cladding₅].

Screens

- InView[™] screens
 - [Half-Size] [Full-Size₄] black vinyl-coated 18/18 mesh fiberglass screen cloth complying with the performance requirements of SMA 1201, set in aluminum frame fitted to outside of window, supplied complete with all necessary hardware.
 - Full screen spreader bar placed on units > 37" width or > 65" height.
 - Insect screen frame finish is baked enamel, color to match window cladding.

– or –


- Vivid View[®] screens
 - [Half-Size] [Full-Size₄] PVDF 21 / 17 mesh, minimum 78 percent light transmissive screen, set in aluminum frame fitted to outside of window, supplied complete with all necessary hardware.
 - Full screen spreader bar placed on units > 37" width or > 65" height.
 - Insect screen frame finish is baked enamel, color to match window cladding.

Hardware

- Optional factory applied limited opening device available for vent units in stainless steel; nominal 3-3/4" opening. Limiting device concealed from view.
- Optional factory applied window opening control device available. Device allows window to open less than 4" with normal operation, with a release mechanism that allows the sash to open completely. Complies with ASTM F2090-10.
- (1) Contact your local Pella sales representative for current designs and color options.
- (2) Available in clear or Low-E insulating glass with argon, and obscure insulated glass.
- (3) Tan, Brown and Putty Interior GBG colors are available in single-tone (Brown/Brown, Tan/Tan or Putty/Putty). Other interior colors are also available with Tan or Brown exterior.
- (4) Full screens are available on units \leq 96" height.
- (5) Appearance of exterior grille color will vary depending on Low-E coating on glass.




LX Unit Sections - Aluminum-Clad Ogee Exterior Glazing Profile

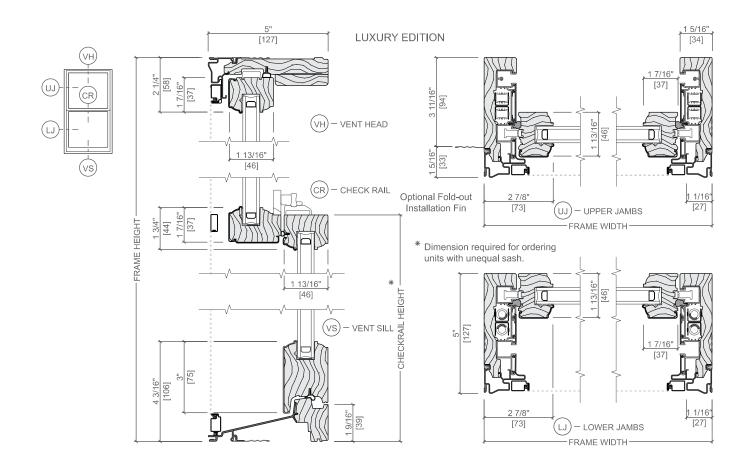

Customer Approval Form:

Signature:

Date:

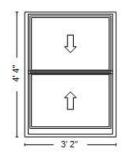


Viewed from the Exterior

Quote Number: 13286306 Line Number: 10 Quote Qty: 1 Description: Architect, Traditional, Double Hung, 38 X 52, White Rough Opening: 3' 2 3/4" X 4' 4 3/4"


Scaling: 1/2" = 1'


These drawings are based on our interpretation of the information provided to us. They are submitted for final approval of the individual^{**} responsible for the project and are not intended to create any warranty or other liability. The user^{**} is responsible for compliance with applicable building codes or other regulations and determining the suitability of the suggestions for the particular application, including the final design of reinforcement, flashing, and sealant systems for all window and door installations. ** building owner, architect, contractor, installer and/or consumer

	Quote Name: 548 Pleasant St, Belmont	Project Name: 548 Pleasant St, Belmont
Pella	Jobsite Location: BELMONT, MA	
®	Room Location: None Assigned	
Sales Branch Location: 18500 Pella Boston Windows & Doors		

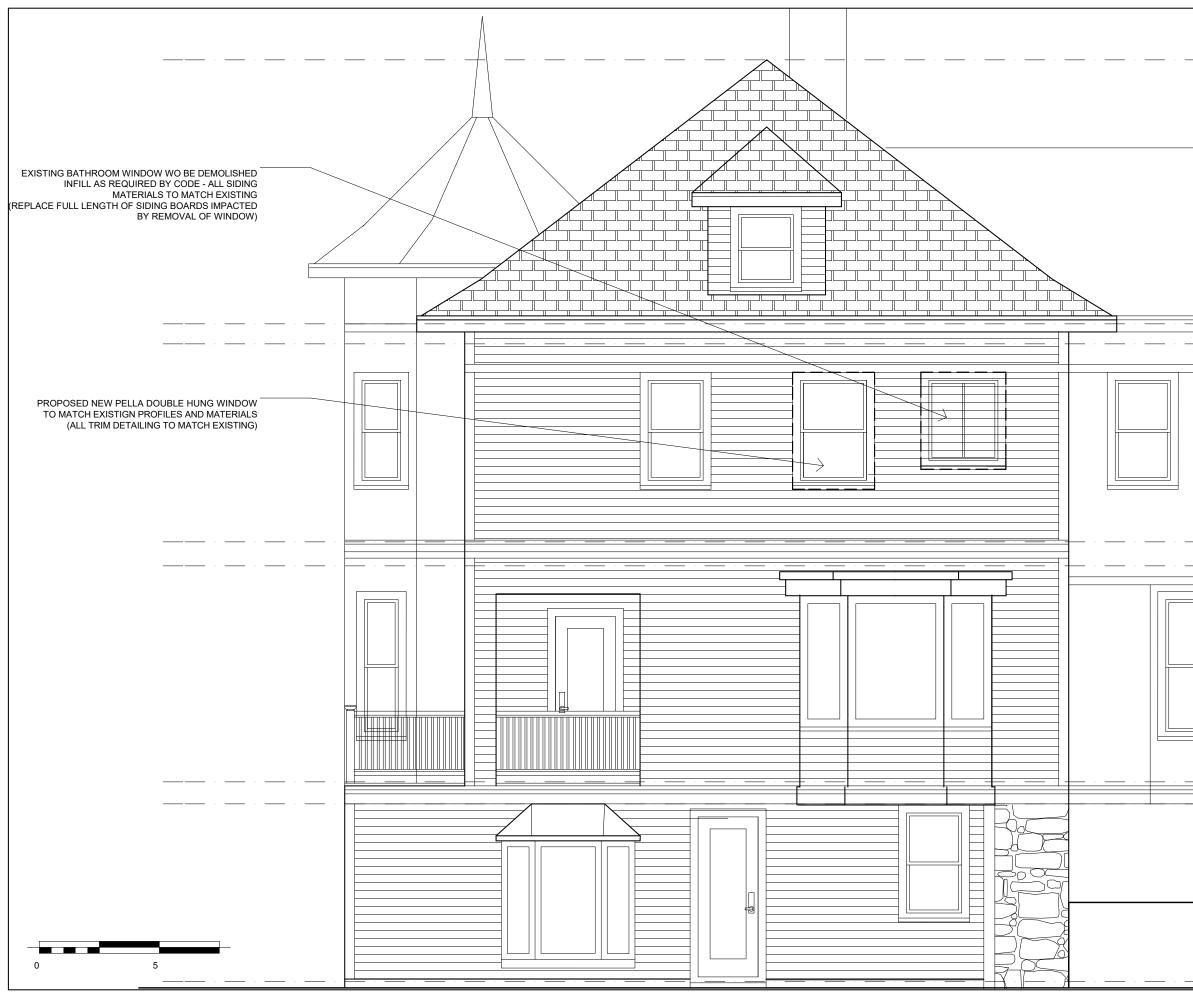

	MILLER DESIGN LLC
	80 CLARK STREET BELMONT, MA 02478 TEL:617.993.3157
	PLEASANT STREET PLEASANT STREET LOCUS PLAN Architect: Miller Design LLC 80 Clark Street Belmont MA 02478 617-993-3157 Date: Issued for:
	08/17/20 BATHROOM
	SCHONEWALD RESIDENCE
· · · · · · · ·	SCHONEWALD RESIDENCE 548 PLEASANT STREET BELMONT, MA HISTORIC ELEVATION SUBMISSION Sheet Number:
1 SOUTH ELEVATION SCALE: 1/4" = 1'	H01

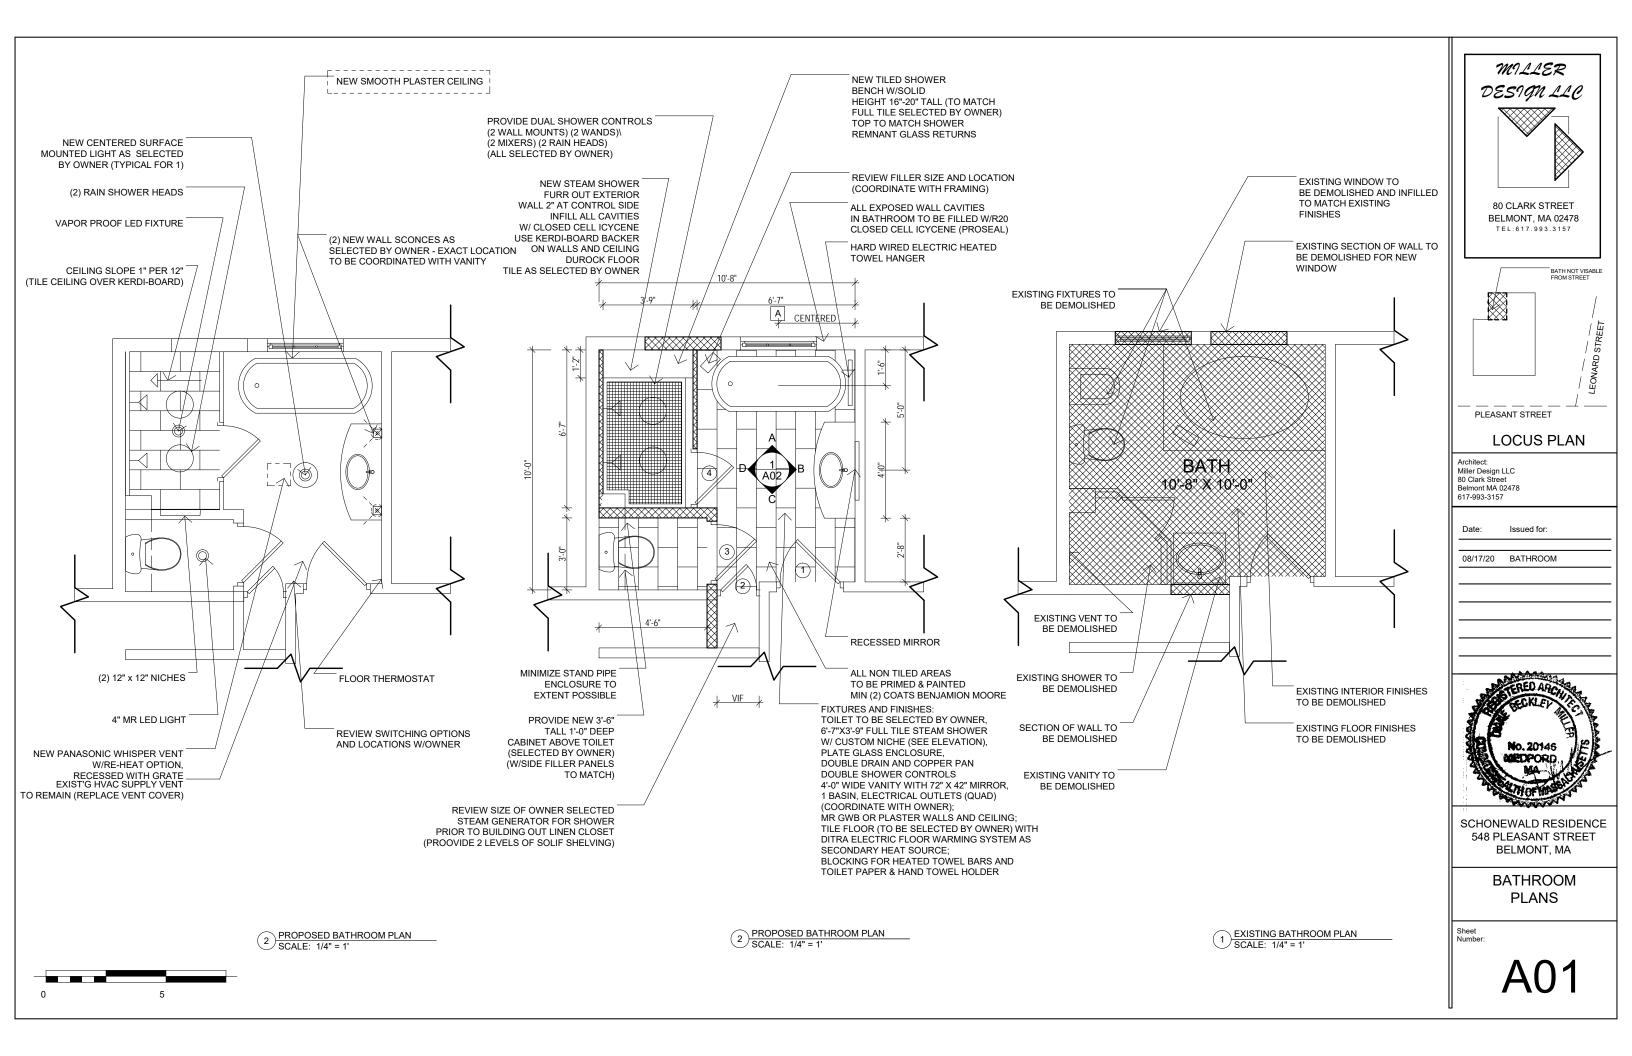

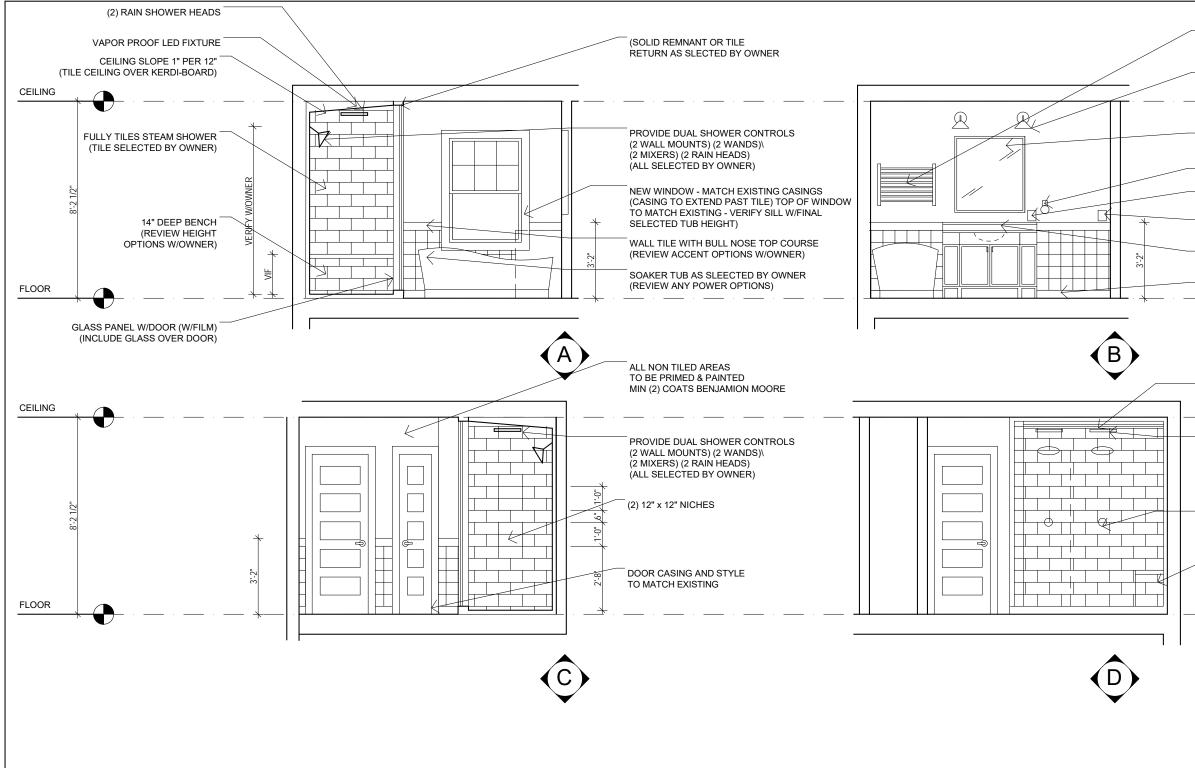

WINDOW SCHEDULE NEW PELLA 350 OR EQUAL AS SELECTED BY OWNER TOP TO ALIGN			
KEY	SIZE	DISCRIPTION	
Α	3'-2" X 4'-4"	NEW DOUBLE HUNG WINDOW (TOP TO ALIGN W/EXISTING)	
TEMPERED GLASS (GAS FILLED)			
PATCH AND MATCH ALL EXTERIOR FINISHES			

DOOR SCHEDULE DOORS TO BE SOLID WOOD DOORS TO MATCH PRIMARY EXISTING INTERIOR DOORS		
KEY	SIZE	DISCRIPTION(PROFILES TO BE SELECTED BY OWNER
1	2'-6" X 6'-8"	EXISTING DOOR TO REMAIN
2	1'-4" X 6'-8"	INTERIOR PANEL DOOR W/VENT (AS REQUIRED)
3	2'-4" X 6'-8"	NEW INTERIOR PANEL DOOR AS S.B.O.
4	2'-4" X 6'-6"	GLASS SHOWER DOOR W/FILM (FILLER PANEL ABOV
INERIOR DOORS TO BE SOLID WOOD W/PROFILES TO MATCH EXISTING		



HARD WIRED ELECTRIC HEATED TOWEL HANGER LIGHTING AS SELECTED BY OWNER RECESSED MIRROR REVIEW INTEGRAL LIGHTING OPTION WITH OWNER HAND TOWEL HOLDER AS SELECTED BY OWNER GFCI POWER FOR CODE (OUTLET W/USB PORTS) FLOOR THERMOSTAT REVIEW VANITY VS TILE BACK SPLASH OPTION W/OWNER TILE BASE AS SELECTED BY OWNER	MILLER DESIGN LLC DESIGN LLC WWW LLC BOCLARK STREET BELMONT, MA 02478 TEL: 617.993.3157
(2) RAIN SHOWER HEADS	/ Lu / So / So / So / So / So / So / So / So
(ALL SELECTED BY OWNER) CONTROLS - REVIEW OPTIONS FOR DIGITAL CONTROLS W/OWNER & COORDINATE POWER REQ.) 14" DEEP BENCH (REVIEW HEIGHT OPTIONS W/OWNER)	Date: Issued for: 08/17/20 BATHROOM
1 EXISTING BATHROOM PLAN SCALE: 1/4" = 1'	RECKLED ARCS
H ER) VE)	SCHONEWALD RESIDENCE 548 PLEASANT STREET BELMONT, MA INTERIOR ELEVATIONS SCHEDULES Sheet Number: A02













