



**Stantec Consulting Services Inc.**  
65 Network Drive, 2nd Floor, Burlington MA 01803-2767

July 31, 2021

**Attention: Todd Borci, Enforcement Officer**

US EPA Region I – New England  
5 Post Office Square – Suite 100  
Boston, MA 02109-3912

**Subject:** Town of Belmont  
ORDER ON CONSENT Docket No. CWA-AO-R01-FY17-11  
Report On Compliance

Dear Mr. Borci,

In accordance with the above referenced Order On Consent, we are submitting the following Report On Compliance (ROC) dated July 31, 2021, which describes activities conducted from January 1, 2021 through June 30, 2021 associated with the Wellington Brook and Winn's Brook tributary areas in the Town of Belmont. These two areas are designated as Sub-catchments 8 and 10, respectively. This report also includes activities associated with all sub-catchments in the Mystic River Watershed including, 1, 2, 3, 4, 5, 6, 8, 9, 9A, 10, 11, 11A, 12, 13, 15 and 15A. Refer to the November 2017 Investigation of the Winn's Brook and Wellington Brook Tributary Areas report and the January 2018 Report On Compliance for complete figures of each sub-catchment area.

A comprehensive Sewer System Rehabilitation Construction project, which includes removal of suspected and confirmed illicit sources of contamination to the storm drain and inflow and infiltration within the sewer, is completed. The project included all identified required rehabilitation work from the previous ROC dated January 31, 2020. A Private Sector Sump Pump Removal & Sewer System Rehabilitation Construction project, which includes disconnection of sump pumps and associated plumbing and continued removal storm drain illicit and contamination sources, started on July 21, 2021. Refer the contract drawings in **Attachment 1**. Several sub-catchments discharging to the Mystic River Watershed were resampled during this reporting period for *E. coli* and select locations for Ammonia.

**V.1.a ILLICIT DISCHARGES IDENTIFIED**

**Charles River Watershed Sub-catchments 16-31**

**Completed**

No work was conducted in the Charles River Watershed sub-catchments.

**Planned**

The Charles River Watershed sub-catchments will have comprehensive follow-up sampling completed during the next reporting period.



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### **Mystic River Watershed Sub-catchments 1-15A**

#### **Completed**

Follow-up dry weather samples were collected for several sub-catchment areas in March 2021, after the majority of the rehabilitation, within areas 8 (8-2, 8-3, 8-5, 8-5,8-6), 10 (10-1 and 10-2), 11, 11A, 12, and 13 to evaluate the status of each sub-catchment. Refer to **Figure 1**. As shown in **Table 1**, Sub-catchments 8-2, 8-5, 11A, 12, and 13 were below the *E. coli* reportable threshold of 235 MPN/100mL. Sub-catchment 8-4 showed a significant improvement but is still above the threshold for *E. coli*. Sub-catchments 11 and 8-3 showed an increase in *E. coli* levels. Sub-catchments 8 and 10 are large tributaries and were broken down into smaller catchment areas to identify any masked contamination upstream. Refer to **Attachment 2**. Additional upstream tributary sampling is detailed below in sub-catchments where it was necessary.

#### **Planned**

Comprehensive investigations will continue in the Mystic River Watershed sub-catchments as described below.

#### Sub-catchments 1, 3, 4, 5, 6, 9, 9A, 13 and 15A

#### **Completed**

Sub-catchment 1 was further investigated as described below. From the previous report, Sub-catchments 3, 4, 5, 6, 9, and 9A were cleared as contamination sources. Sub-catchment 13 was sampled for *E. coli* and was below the threshold. Refer to **Table 1** and **Figure 1**.

#### **Planned**

Sub-catchment 15A will continue to be monitored due to previously tested elevated levels of ammonia.

#### Sub-catchment 1

#### **Completed**

Sub-catchment 1 had been previously cleared as a contamination source. However, follow up sampling, during last reporting period, within the tributary indicated an increased level of *E. Coli* from a 6" pipe from an easement at Fairview Ave and Van Ness Rd. Dyed water testing concluded that 58 Van Ness Road's sewer is illegally connected to drain. CCTV inspections were performed of the drain, however incomplete and so far, ranked as priority 2. Refer to **Figure 2**, and **Table 2**.

#### **Planned**

The identified illicit connection will be repaired as a change order in the ongoing Sump Pump Removal and Sewer System Rehabilitation Contract.



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Sub-catchment 2

**Completed**

The CCTV inspections on Hartley Rd, Herbert Rd, Houghton Rd, and Shaw Rd were conducted. Defects and recommended rehabilitation are shown in **Table 2** and **Figure 3**.

**Planned**

Outfall and tributary sampling will be conducted upon completion of the sewer and storm drain rehabilitation work in Sub-catchment Area 2.

Sub-catchment 8-1

**Completed**

The CCTV inspection on Lincoln Rd was conducted. Defects and recommended rehabilitation are shown in **Table 2**. A majority of the remaining houses that have not been rehabilitated or dyed-water tested/inspected were investigated as part of this reporting period. Refer to **Figure 4**.

**Planned**

The remaining houses suggested for dyed-water testing will be inspected. This sub-catchment area will be further sampled upstream to identify target areas for investigations.

Sub-catchment 8-2

**Completed**

Sub-catchment 8-2 sample had an *E. coli* concentration of 100 MPN/100 mL. This was a significant decrease from previous samples taken after rehabilitation was conducted upstream to remove contamination sources. Sub-tributary samples concluded a decrease in *E.coli* concentrations upstream, as well. Refer to **Figure 5**.

**Planned**

This sub-catchment area will be further monitored.

Sub-catchment 8-3

**Completed**

Sub-catchment 8-3 was sampled for *E. coli* that was elevated at 1,400 MPN/100 mL. *E. coli* was only 500 MPN/100 mL in the previous sample. Refer to **Attachment 2**.

**Planned**

This sub-catchment area will be further sampled upstream to identify target areas for investigations.



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Sub-catchment 8-4

**Completed**

Sub-catchment 8-4 sample had an *E. coli* concentration of 1,900 MPN/100 mL. This was a significant improvement from previous sample where *E. coli* was 22,000 MPN/100mL.

**Planned**

This sub-catchment area will be further sampled upstream to identify target areas for investigations.

Sub-catchment 8-5

**Completed**

Sub-catchment 8-5 sample had an *E. coli* concentration of 200 MPN/100 mL. This was a significant improvement from the previous sample where the *E. coli* was 4,800 MPN/100 mL

**Planned**

This sub-catchment area will be further sampled upstream to identify target areas for investigations.

Sub-catchment 8-6

**Completed**

Maple St, Bartlett Ave and Trapelo Rd

Select locations were sampled within the sub-catchment which showed vast improvements in the *E. coli* concentrations resulting below the threshold. One area in particular (8-6-22) had a significant decrease in *E. coli* concentration, although still above the threshold. Refer to **Figure 6** and **Attachment 2**.

**Planned**

This sub-catchment area will be monitored and further sampled upstream to identify target areas for investigations.

Sub-catchment 10-1

**Completed**

Sub-catchment 10-1 has notable improvements in the *E. coli* concentration resulting in <100 MPN/100mL. Previous sample results showed an *E. coli* concentration of 7,900 MPN/100mL.

Additional samples were taken upstream, and the results are shown on **Figure 7** and **Attachment 2**.



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**Planned**

This sub-catchment area will be further monitored.

Sub-catchment 10-2

**Completed**

Select locations were sampled within the sub-catchment which showed an overall decrease in the *E. coli* concentrations, although still above the threshold. Refer to **Figure 8** and **Attachment 1**.

**Planned**

This sub-catchment area will be monitored and further sampled upstream to identify target areas for investigations.

Sub-catchments 11, 11A & 12

**Completed**

Outfall 11 showed an elevated level of *E. coli*, 4,900 MPN/100mL from the last reporting period. Outfall 11A had significant improvements of *E. coli* resulting below the threshold. However, both areas, 11 and 11A, carried higher concentrations of ammonia. Outfall 12 concluded *E. coli* and ammonia levels below the threshold. Refer to **Figure 9** and **Attachment 2**.

**Planned**

Follow-up outfall and tributary sampling will be conducted in outfall 11 and monitored in outfalls 11A and 12.

Spy Pond Outfalls – Outfall Areas 15 & 15A

**Completed**

No outfall samples were conducted in outfalls 15 and 15A.

**Planned**

Both Sub-catchments 15 and 15A will continue to be monitored.

**V.1.b SSO EVENTS**

See attached **Table 3**, which displays a list of blockages reported to the Town and removed.



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#### **V.1.c ILLICIT DISCHARGE AND SSO EVENT MAP**

The Illicit Discharge and SSO Event Maps have been updated through June 26, 2021 and are included in this **Report (Figures 10 & 11)**.

#### **V.1.d CMOM-PROGRAM SELF-ASSESSMENT & CORRECTIVE ACTION PLAN ACTIVITIES**

Activities undertaken this period include:

Section II. Continuing Sewer Assessment Plan: Item 9 - The Town is required to identify the origin of each load to be disposed of at the DPW Yard. As of November 2018, the Town is no longer allowing septic haulers to access the Town yard.

Section III. B. Collection System Management: Training, and Section IV. C. Collection System Operation: Safety - The Department of Public Works provides operations and equipment training to department staff. DPW is actively working to identify outside facilities and instructors in order to implement a safety training program.

Section III. E. Collection System Management: SSO Notification Program, Items 1 and 2 - The Department of Public Works is in receipt of the Massachusetts Department of Environmental Protection Sanitary Sewer Overflow (SSO)/Bypass Notification Form and the department is prepared to meet all reporting requirements when required to do so.

Section IV. D. Collection System Management: SSO Notification Program, Item 3 - The Department of Public Works provides to all sewer department staff an emergency response plan for SSO events. Regular staff training sessions are being programmed to ensure that new hires and current staff are prepared to respond to an SSO event.

#### **V.1.e ADDITIONAL ACTIVITIES FOR ACHIEVING COMPLIANCE**

Refer to the Part V.1.a.

#### **V.1.f PROPOSED CHANGES TO REMEDIAL MEASURES**

None.

#### **V.1.g IDENTIFICATION OF ALL PLANS, REPORTS, AND OTHER SUBMISSIONS REQUIRED**

No additional reports required for submission.



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#### **V.1.h PLANS FOLLOWING THE REPORTING DEADLINES**

Refer to the Part V.1.a.

#### **V.1.i IDENTIFICATION OF NONCOMPLIANCE OF THE ORDER**

None.

Below is a summary of rehabilitation work completed to date:

##### **Completed this reporting period**


All rehabilitation work as described in the Sanitary Sewer Rehabilitation contract drawings, have been completed. A detailed list and updated Record Drawings will be included in the next reporting period.

Please contact me if you have any questions regarding the information contained in this report.


Regards,  
**STANTEC CONSULTING SERVICES INC.**

Robert H. Descheneau, P.E.  
Senior Design Engineer  
Phone: (781) 221-1083  
Bobby.Descheneau@stantec.com


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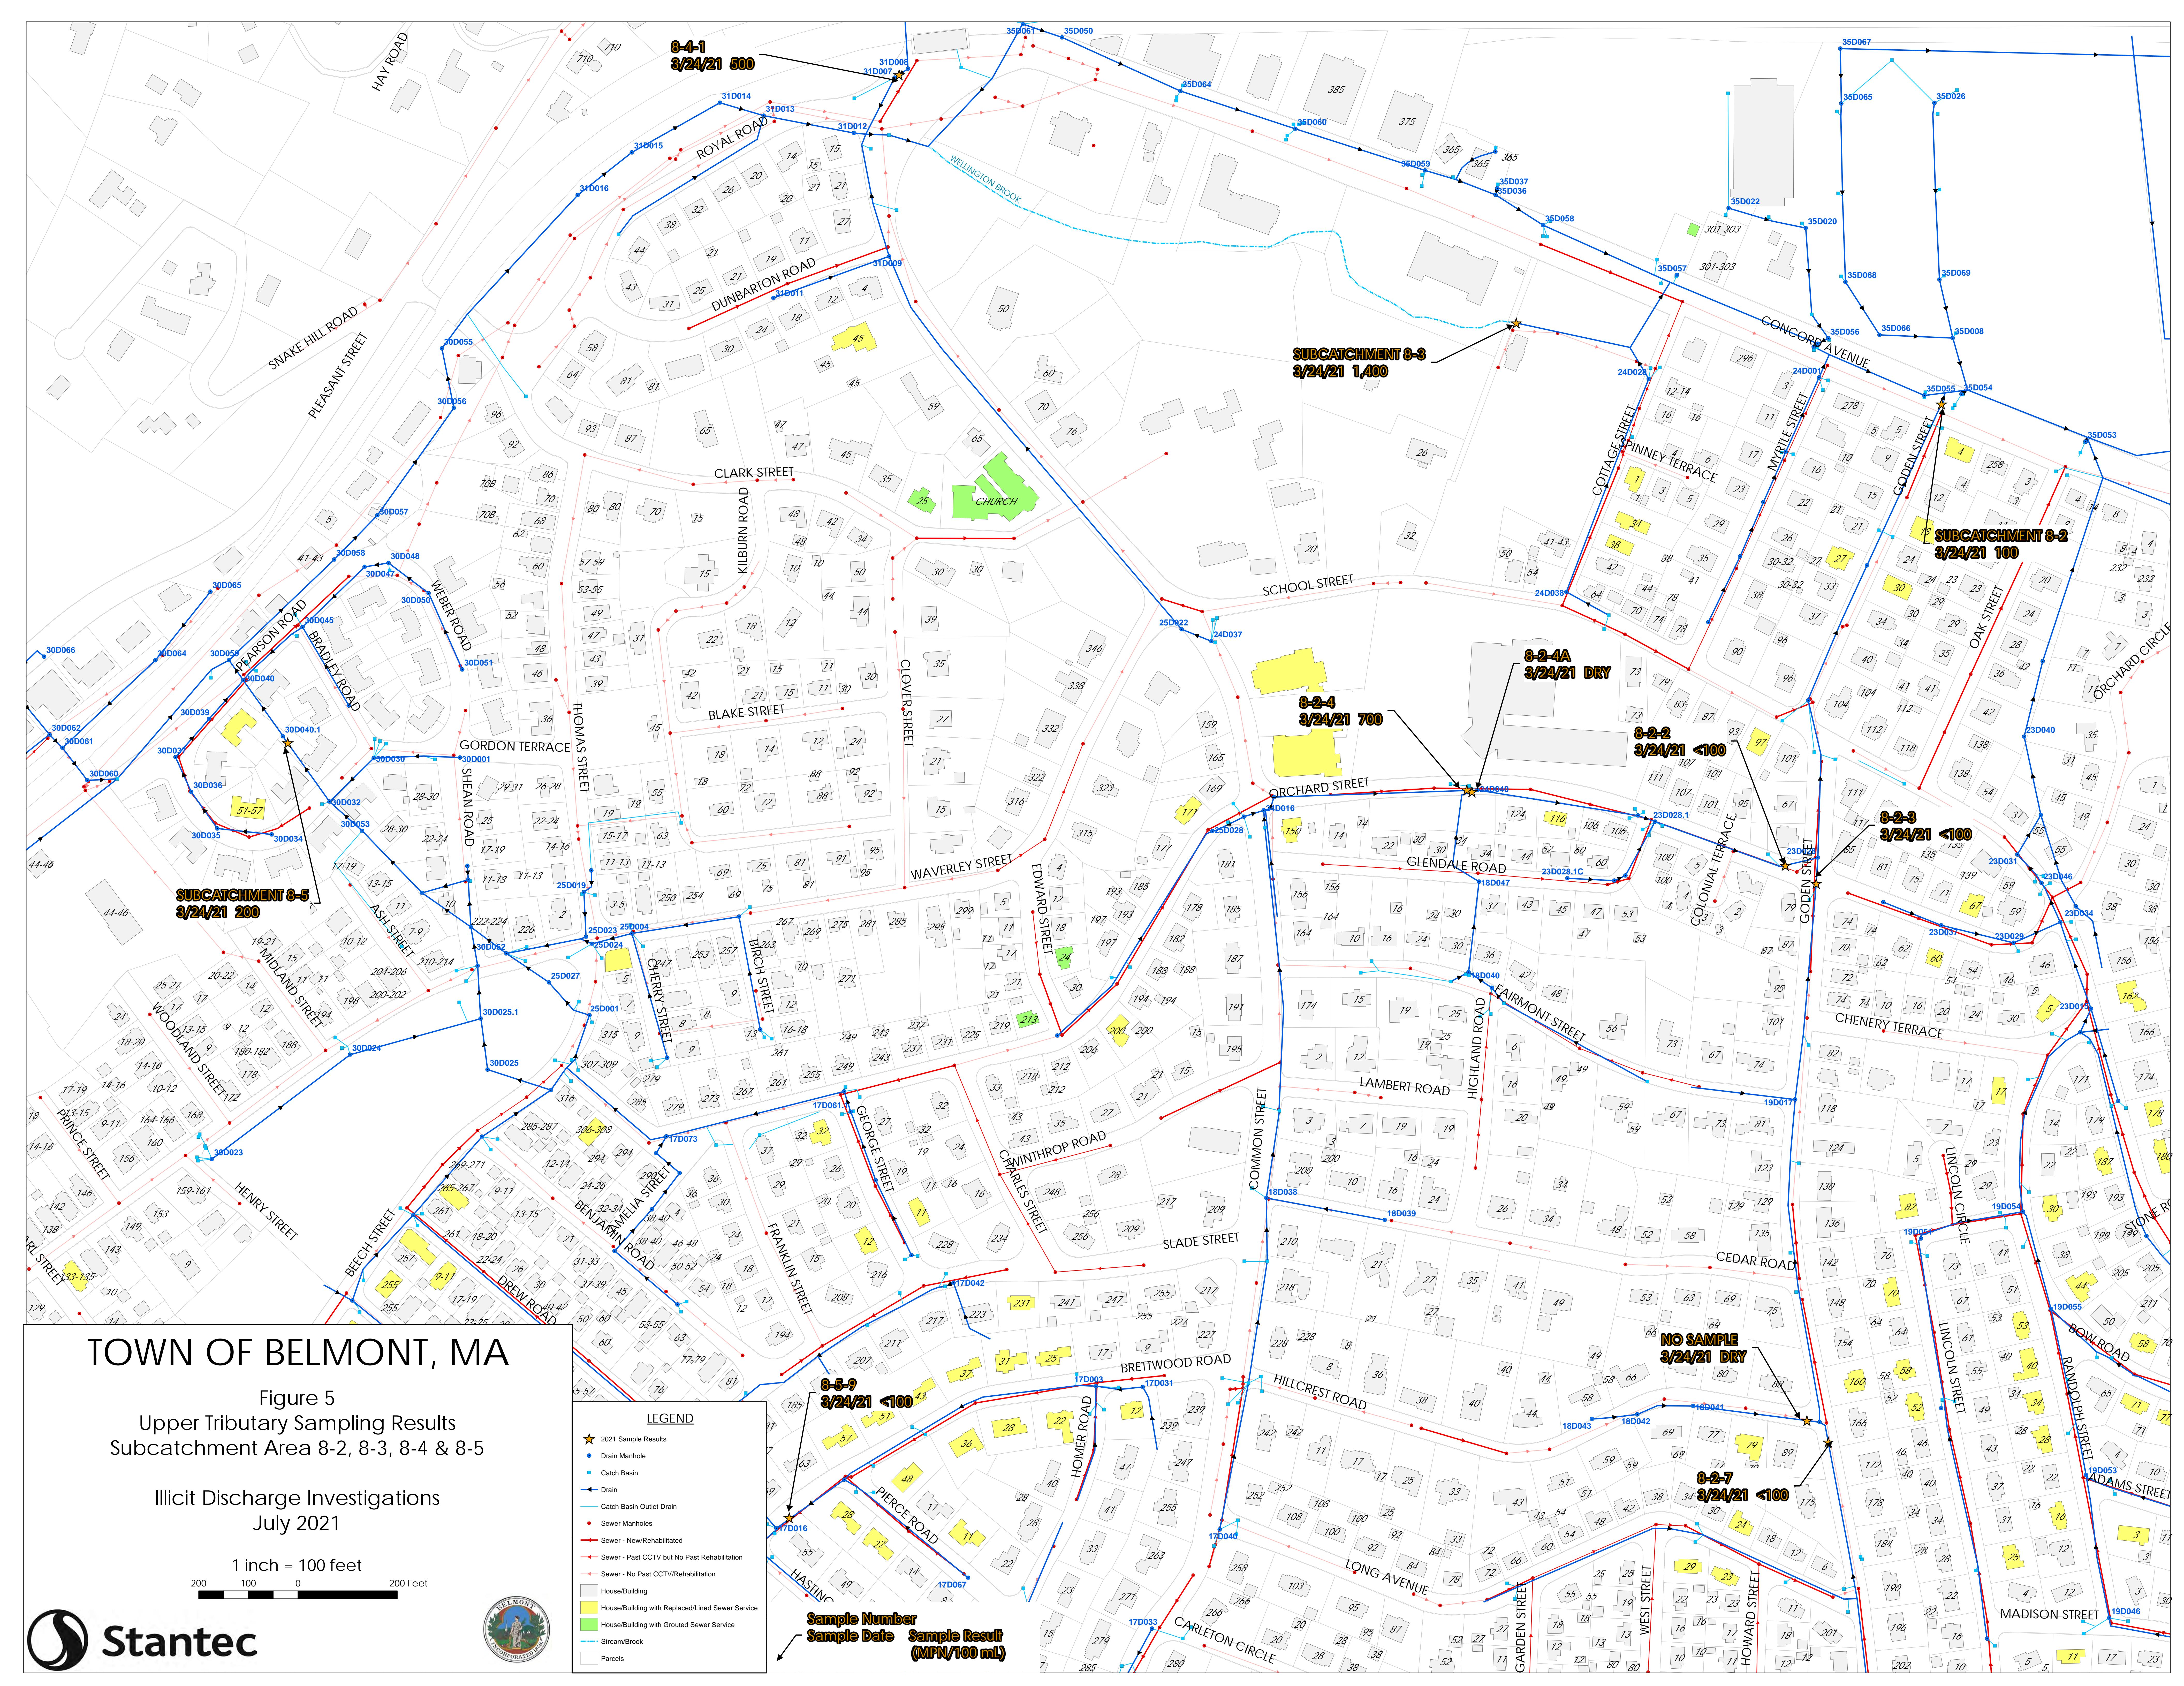


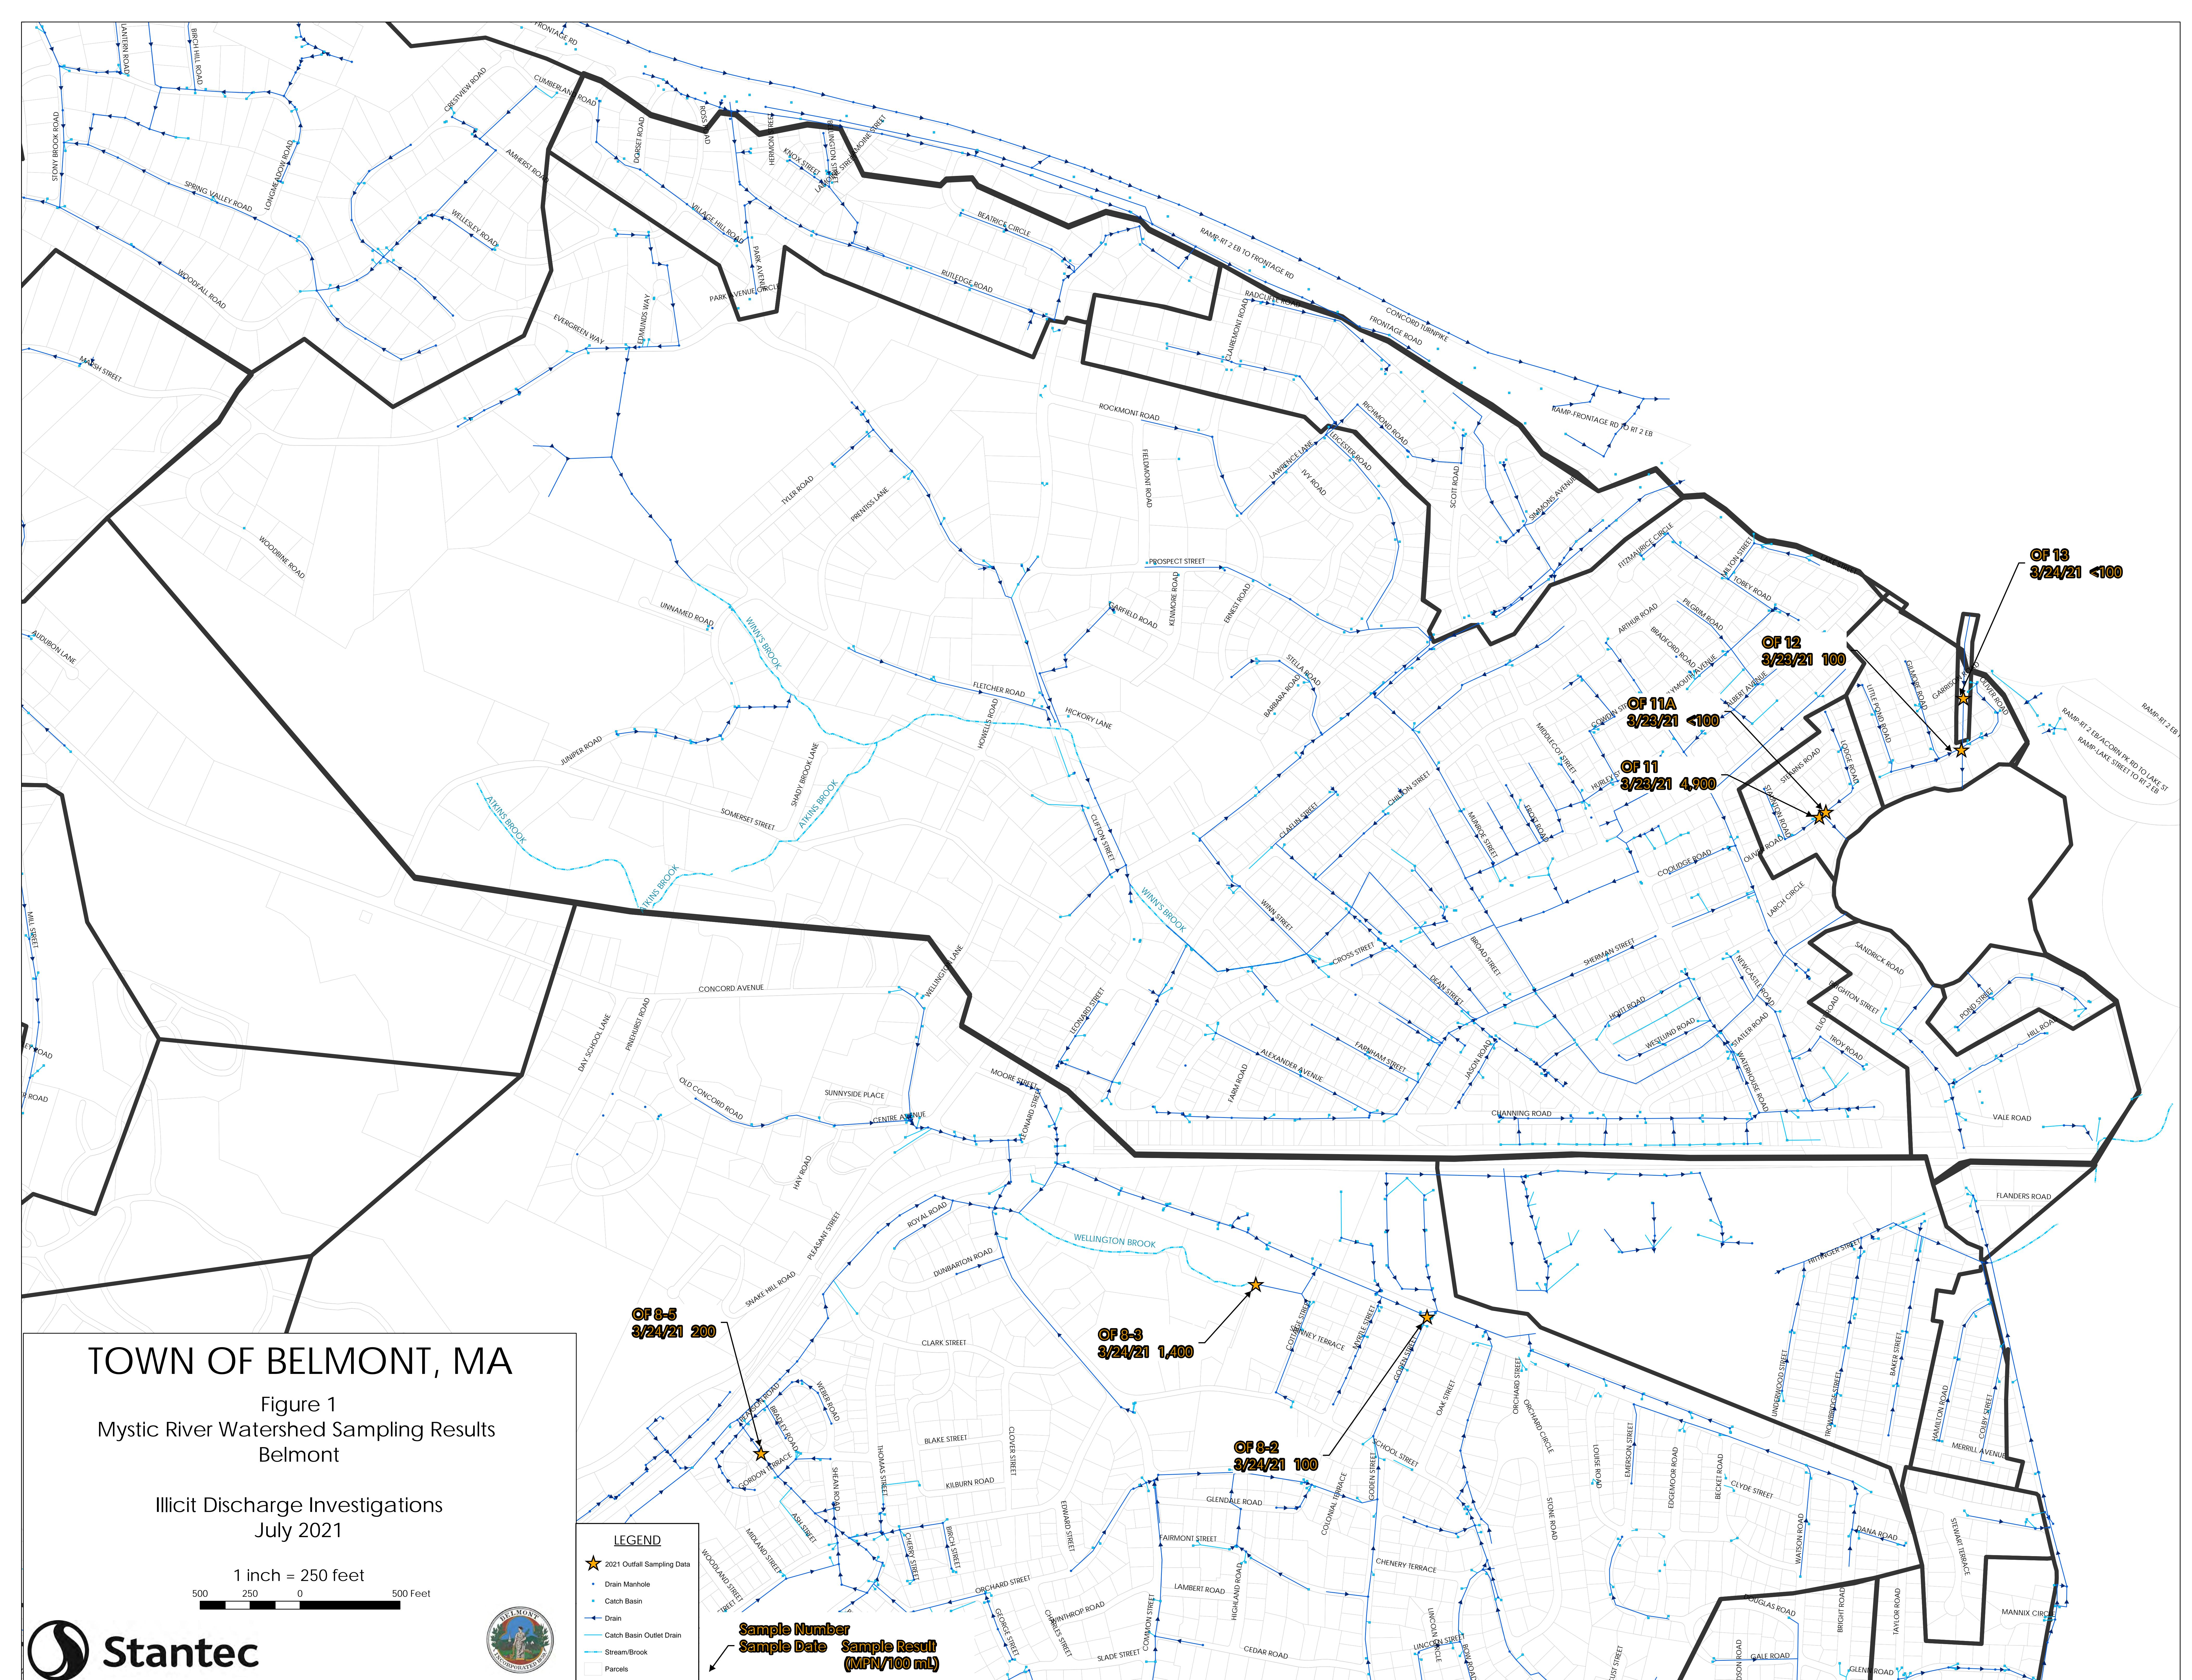
**Stantec**



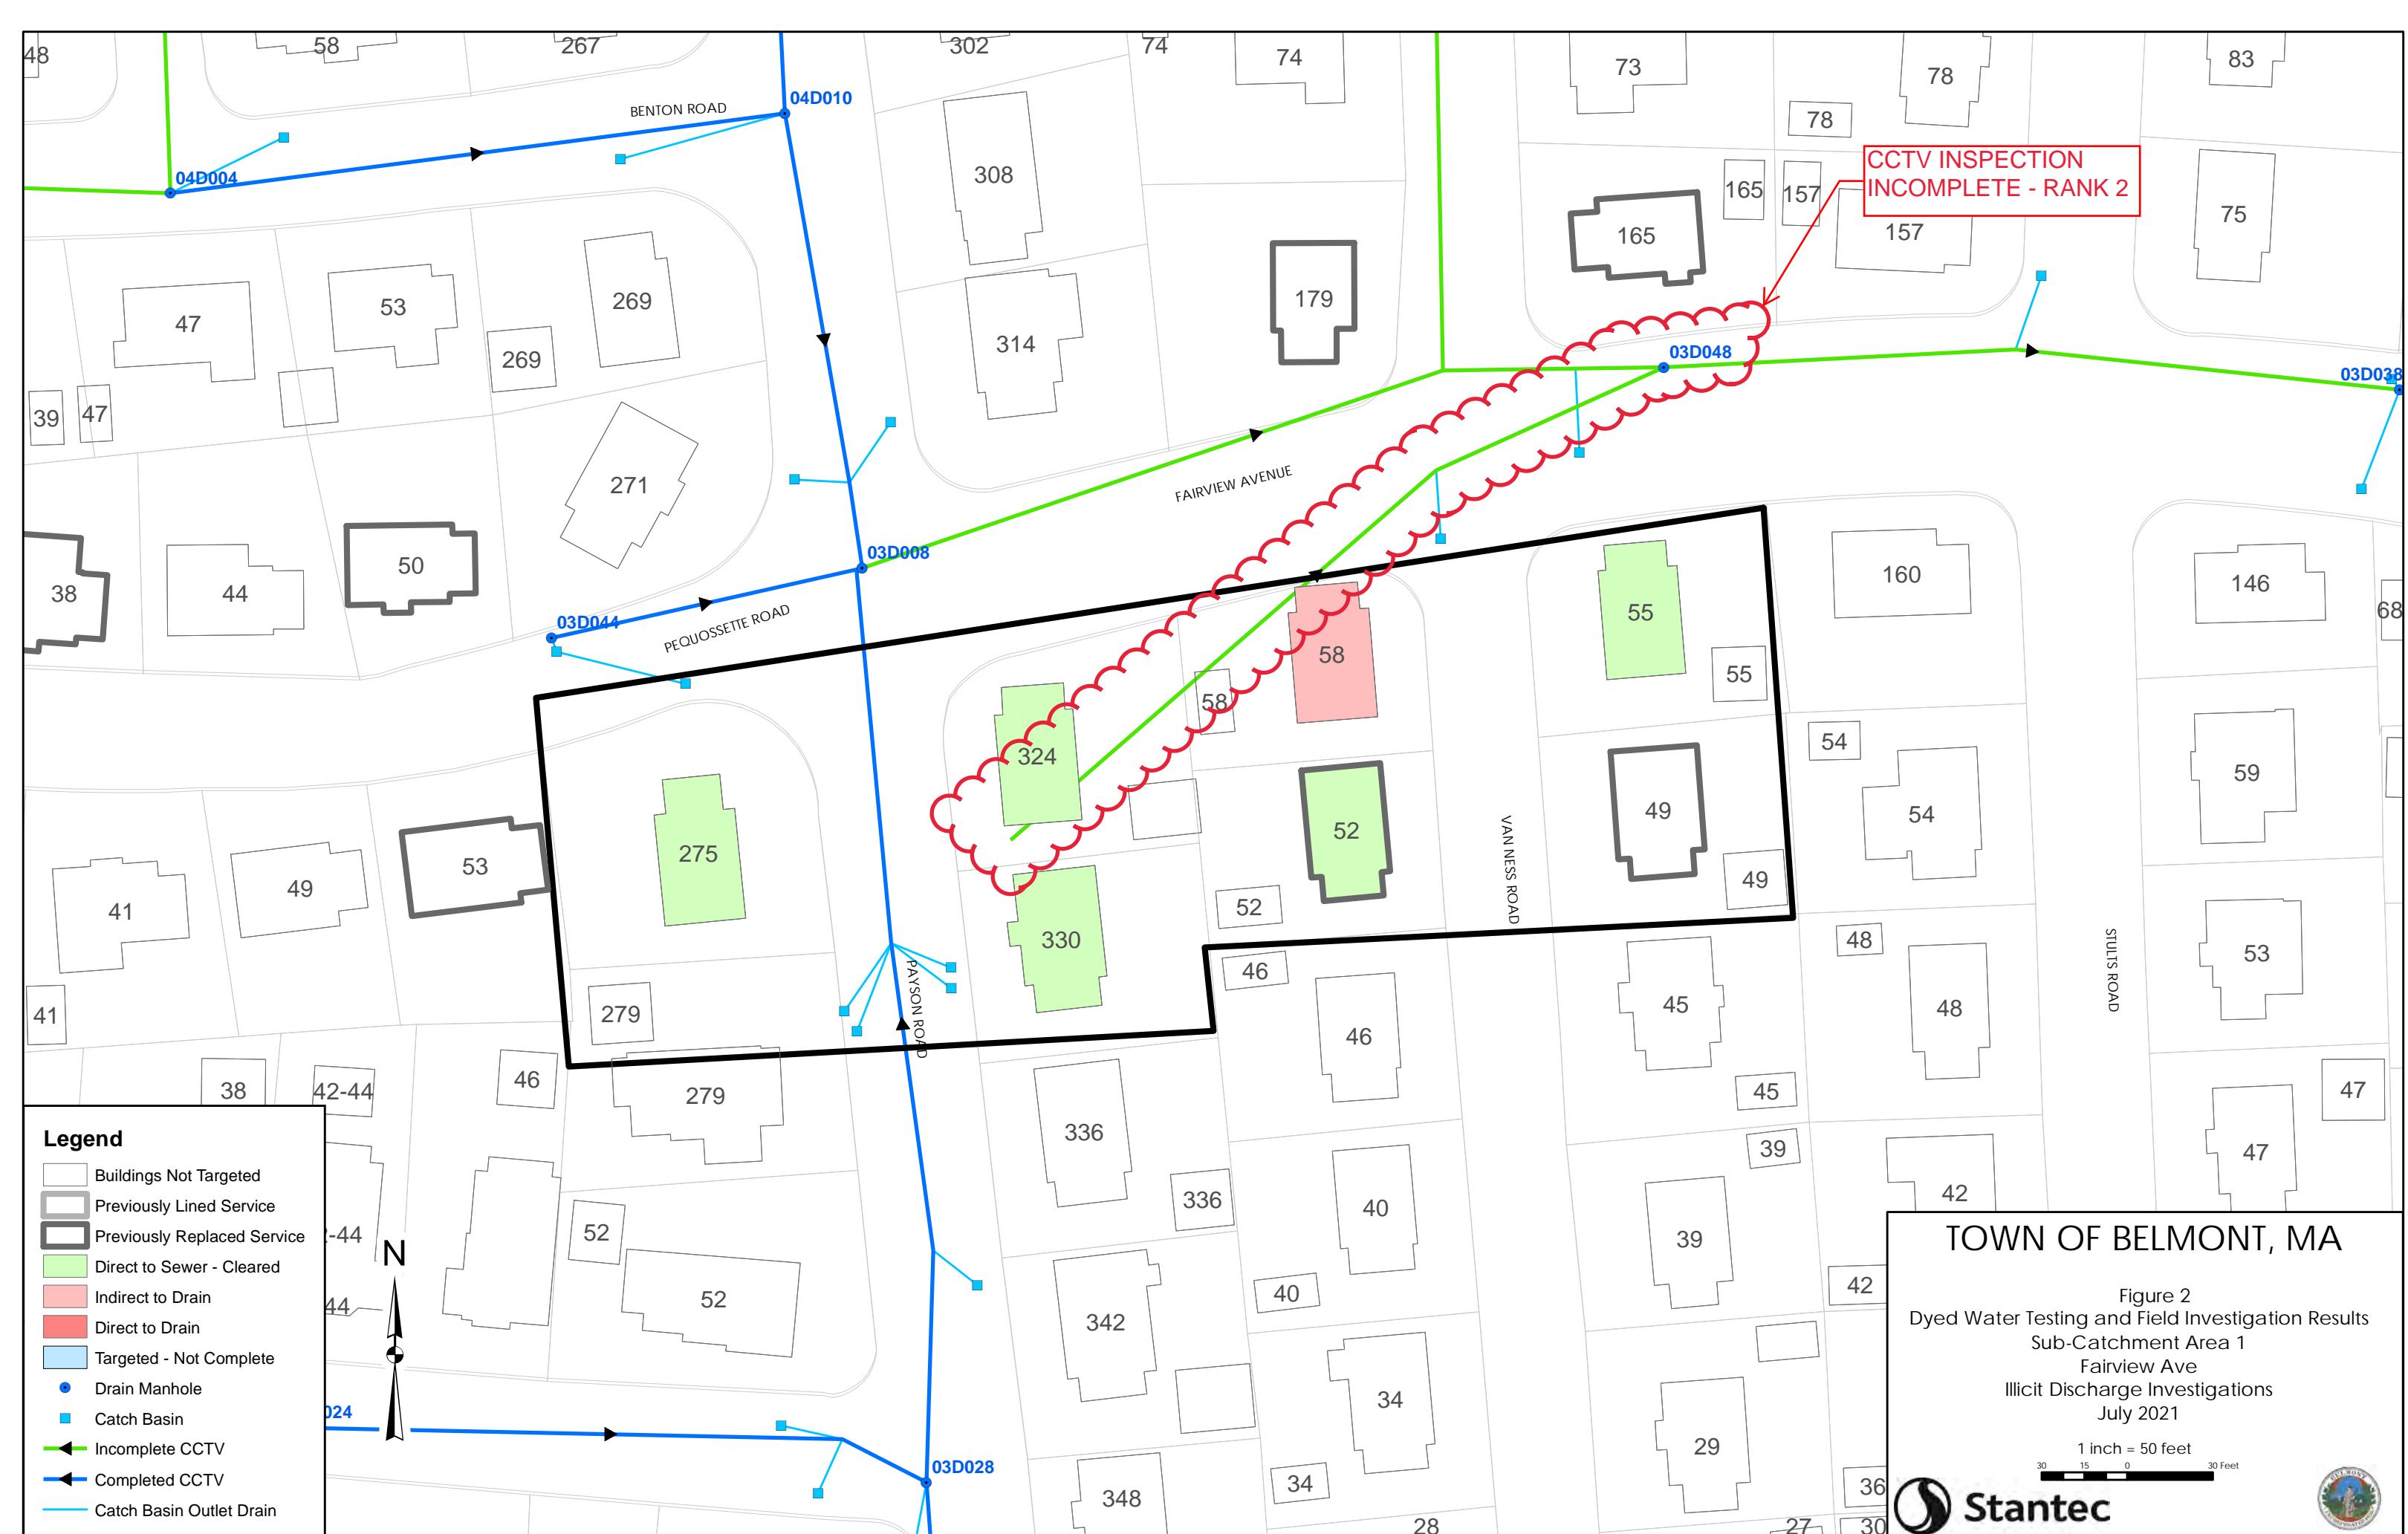



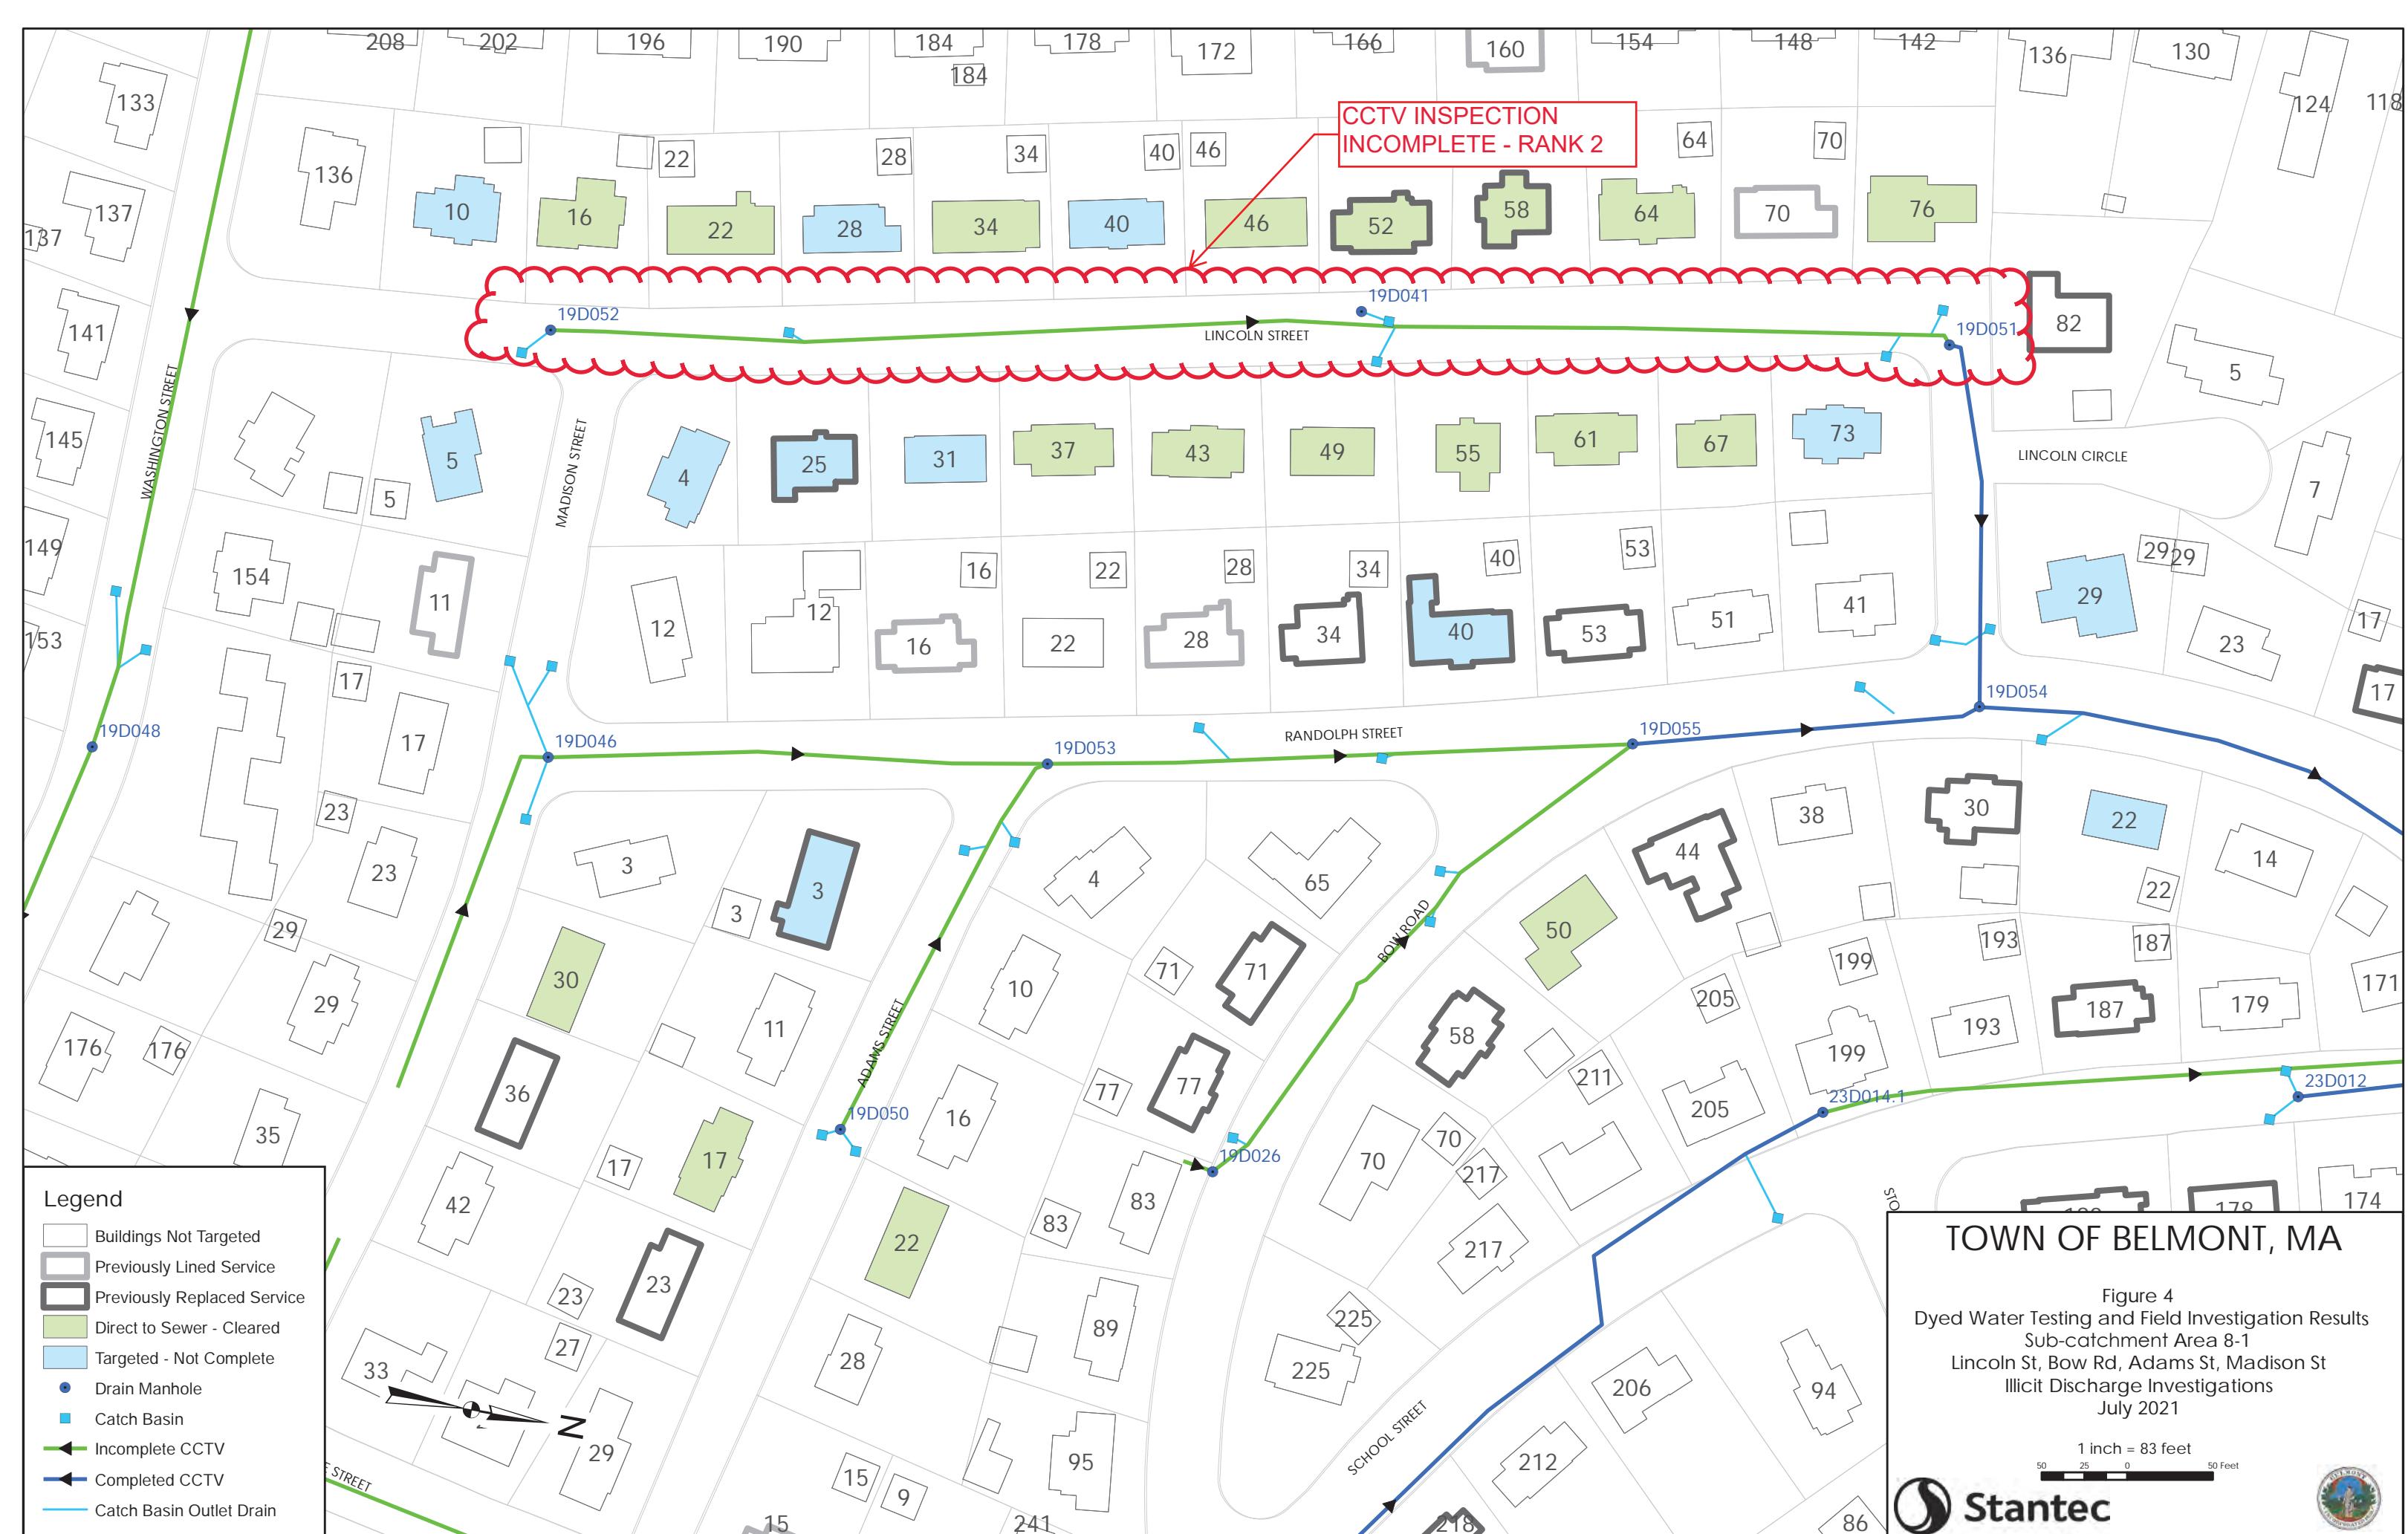

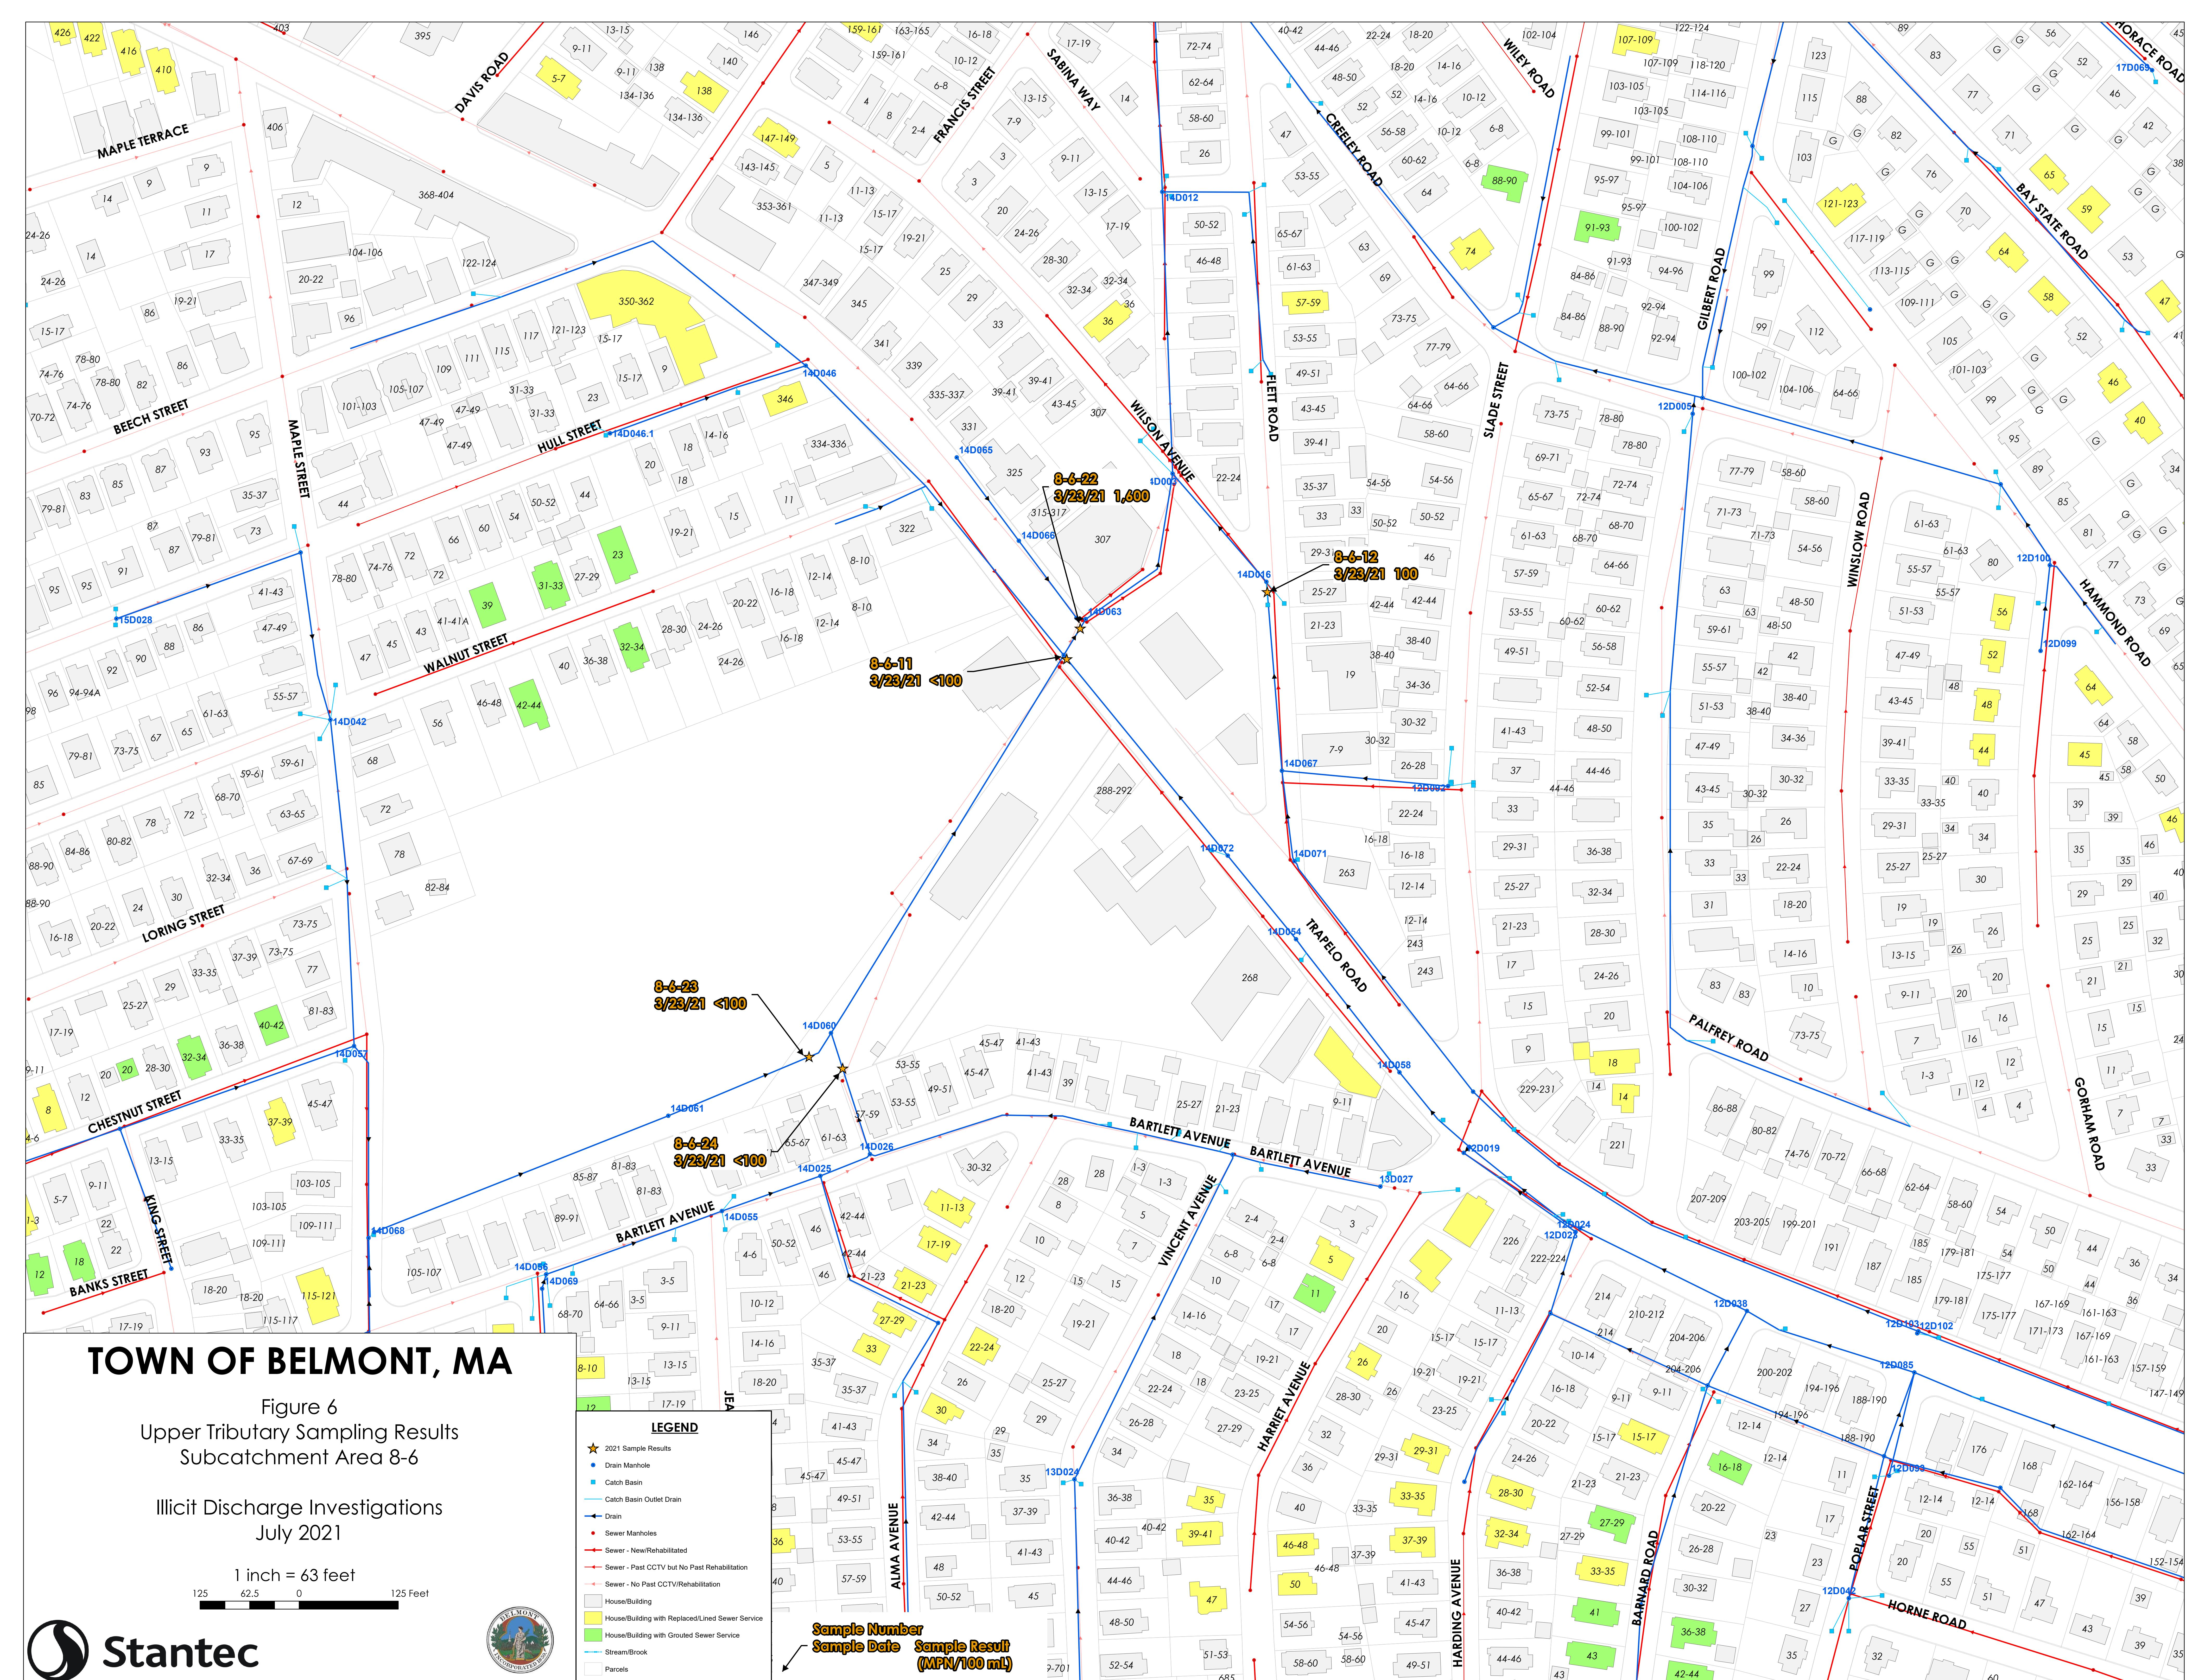

# **TOWN OF BELMONT, MA**

# Figure 6


## Upper Tributary Sampling Results Subcatchment Area 8-6


# Illicit Discharge Investigations

## July 2021

1 inch = 63 feet



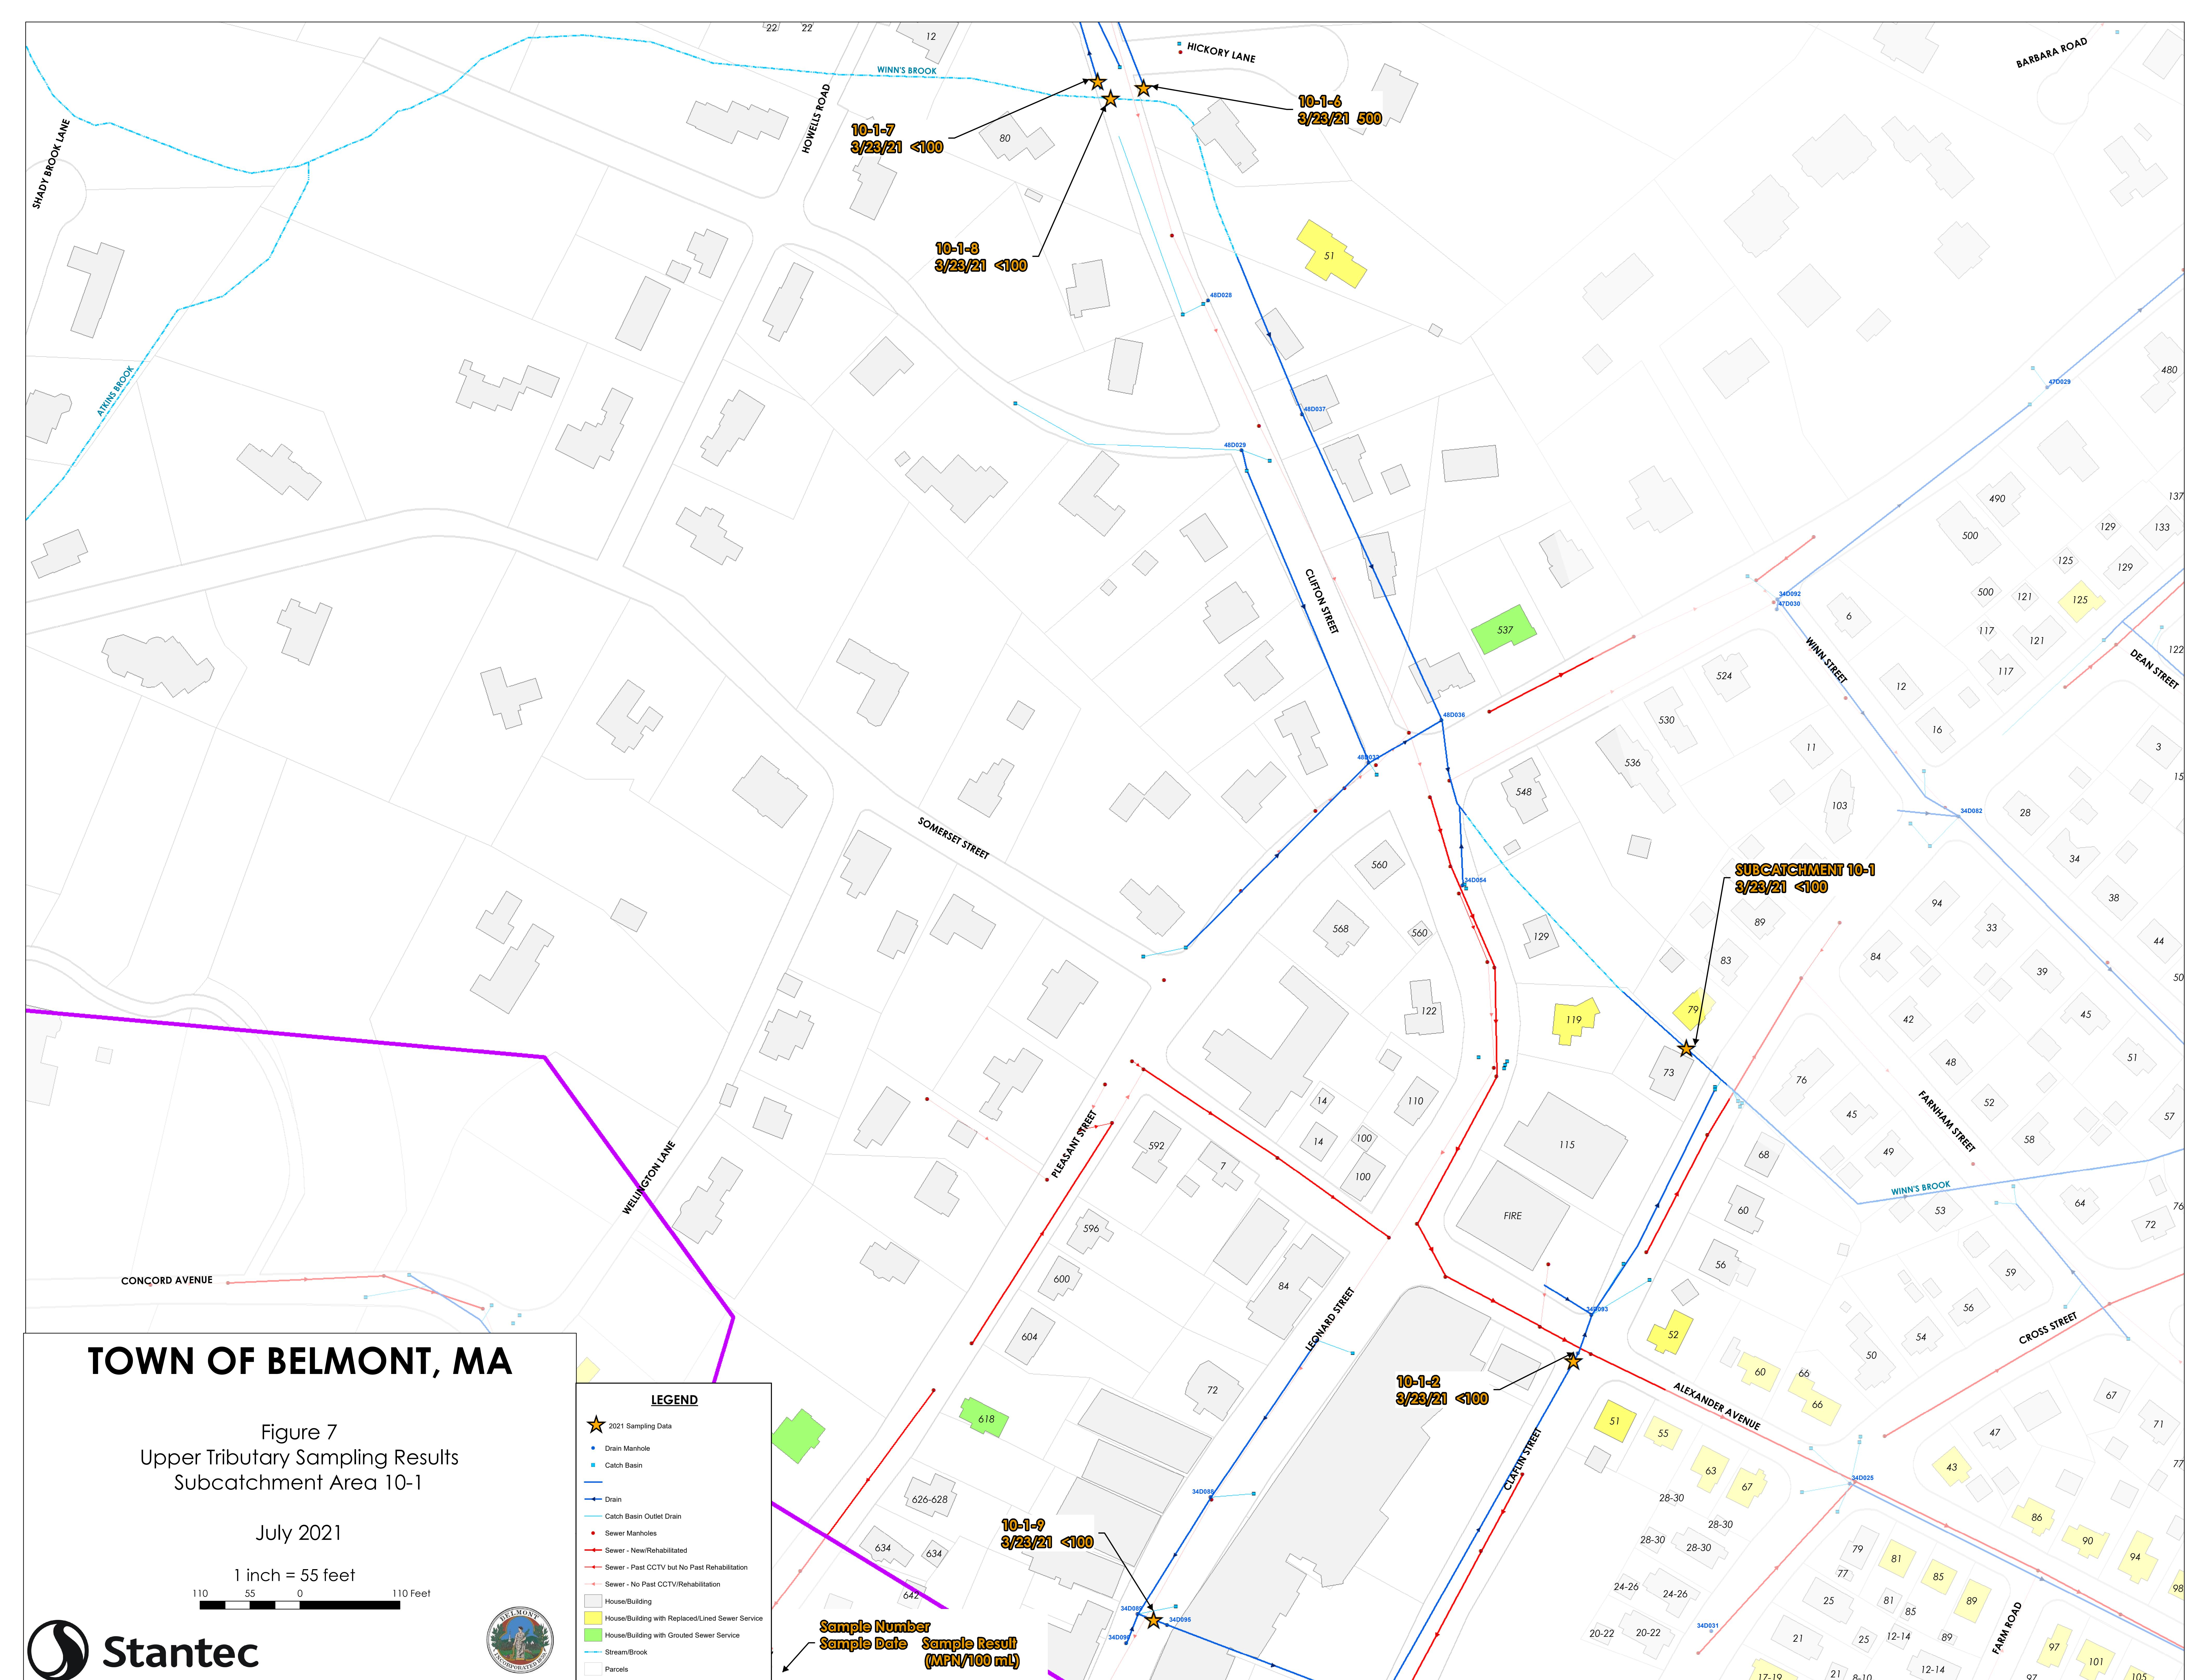

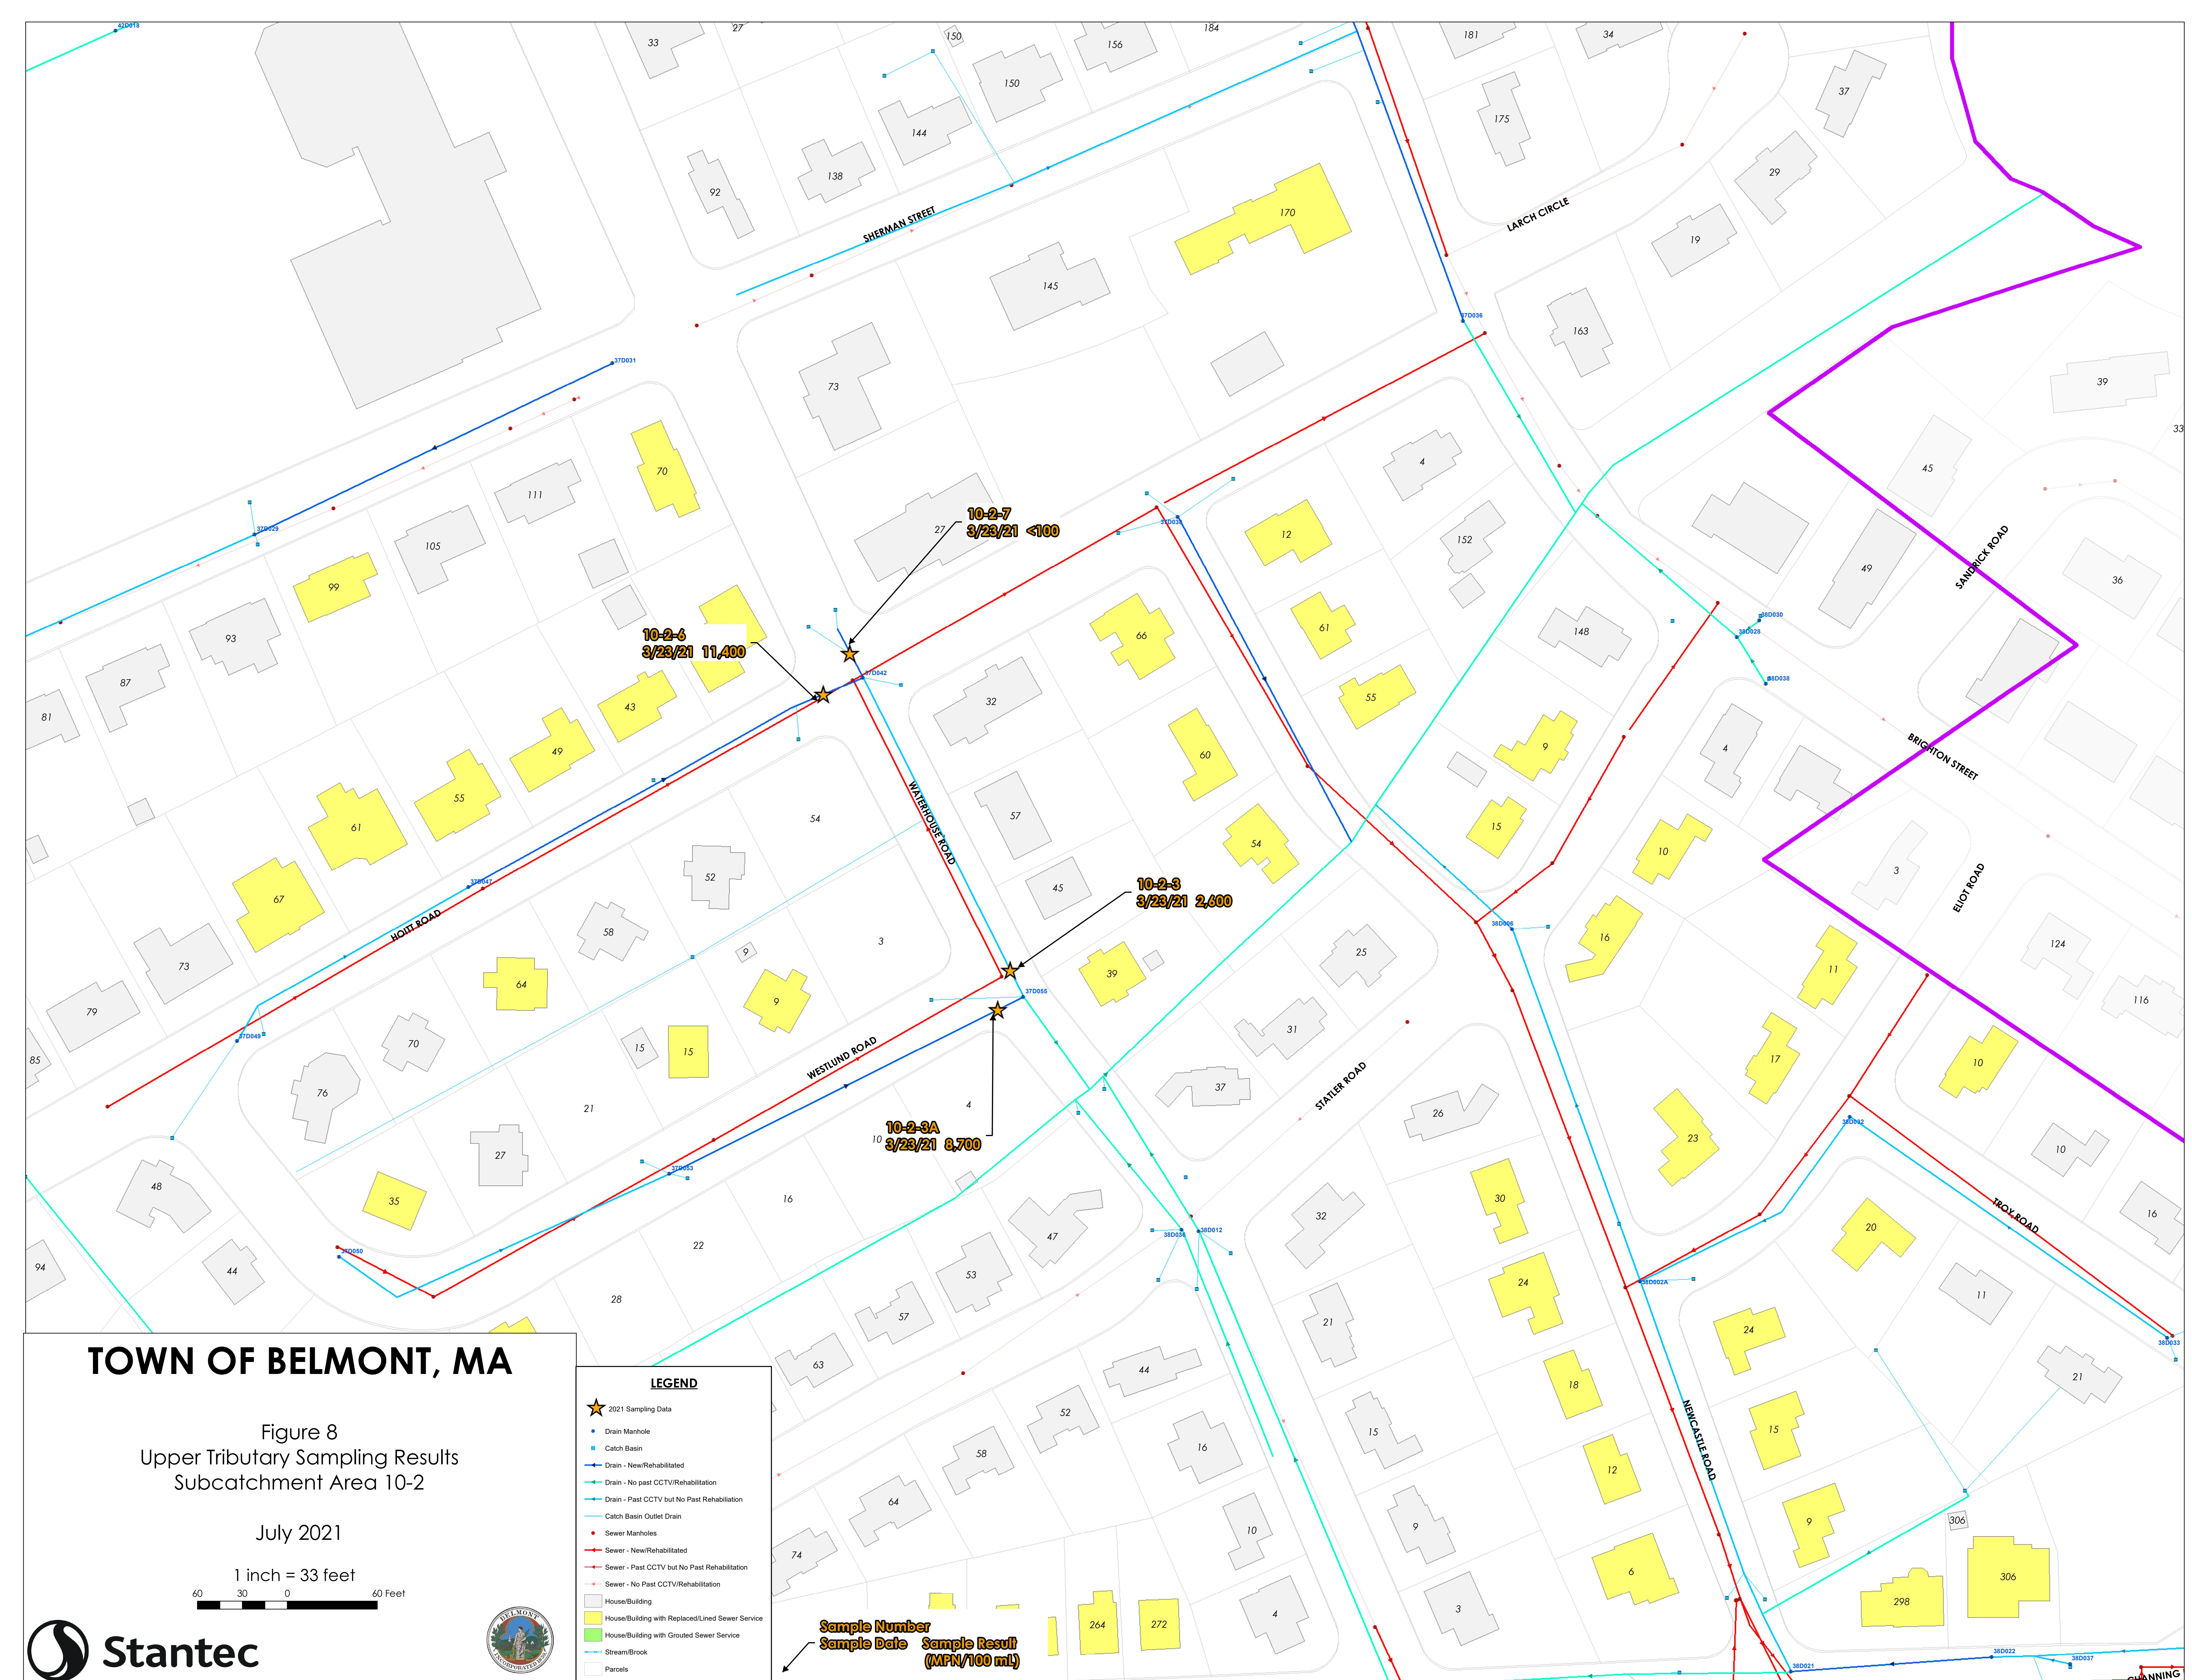



## TOWN OF BELMONT, MA

Figure 9  
Upper Tributary Sampling Results  
Subcatchment Area 11, 11A & 12

July 2021

1 inch = 50 feet


100 50 0 100 Feet



### LEGEND

- ★ 2021 Sampling Data
- Drain Manhole
- Catch Basin
- Drain - New/Rehabilitated
- Drain - No past CCTV/Rehabilitation
- Drain - Past CCTV but No Past Rehabilitation
- Catch Basin Outlet Drain
- Sewer Manholes
- Sewer - New/Rehabilitated
- Sewer - Past CCTV but No Past Rehabilitation
- Sewer - No past CCTV/Rehabilitation
- House/Building
- House/Building with Replaced/Lined Sewer Service
- House/Building with Grouted Sewer Service
- Stream/Brook
- Parcels

Sample Number  
Sample Date  
Sample Result  
(MPN/100 mL)

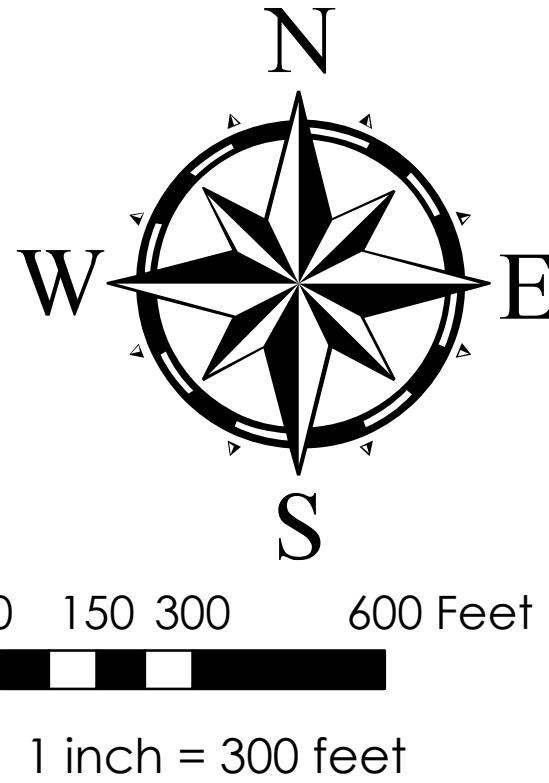


## ILICIT DISCHARGE DETECTION AND ELIMINATION

The

information on this map has been compiled  
by Stantec staff from a variety of sources and is  
subject to change without notice. Stantec makes  
no representations or warranties, express or implied,  
as to the accuracy, completeness, or timeliness of such information,  
or rights  
to the use of such information.


**Figure 10**  
**North Belmont**  
**Illicit Discharge and SSO Event Map**  
July 2021

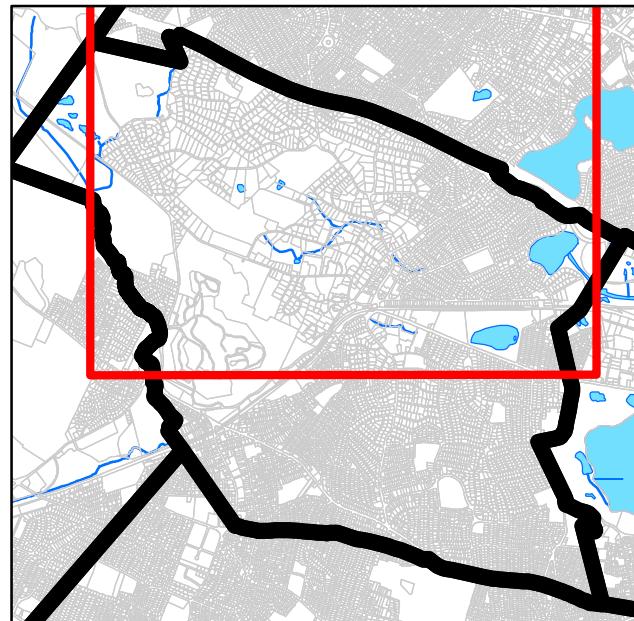


Index Map

### LEGEND

- Matchline
- Stream/Brook
- Water
- Building
- Parcel
- Rehabilitated Potential Indirect Sources
- Blockage Reported
- Illicit Connections

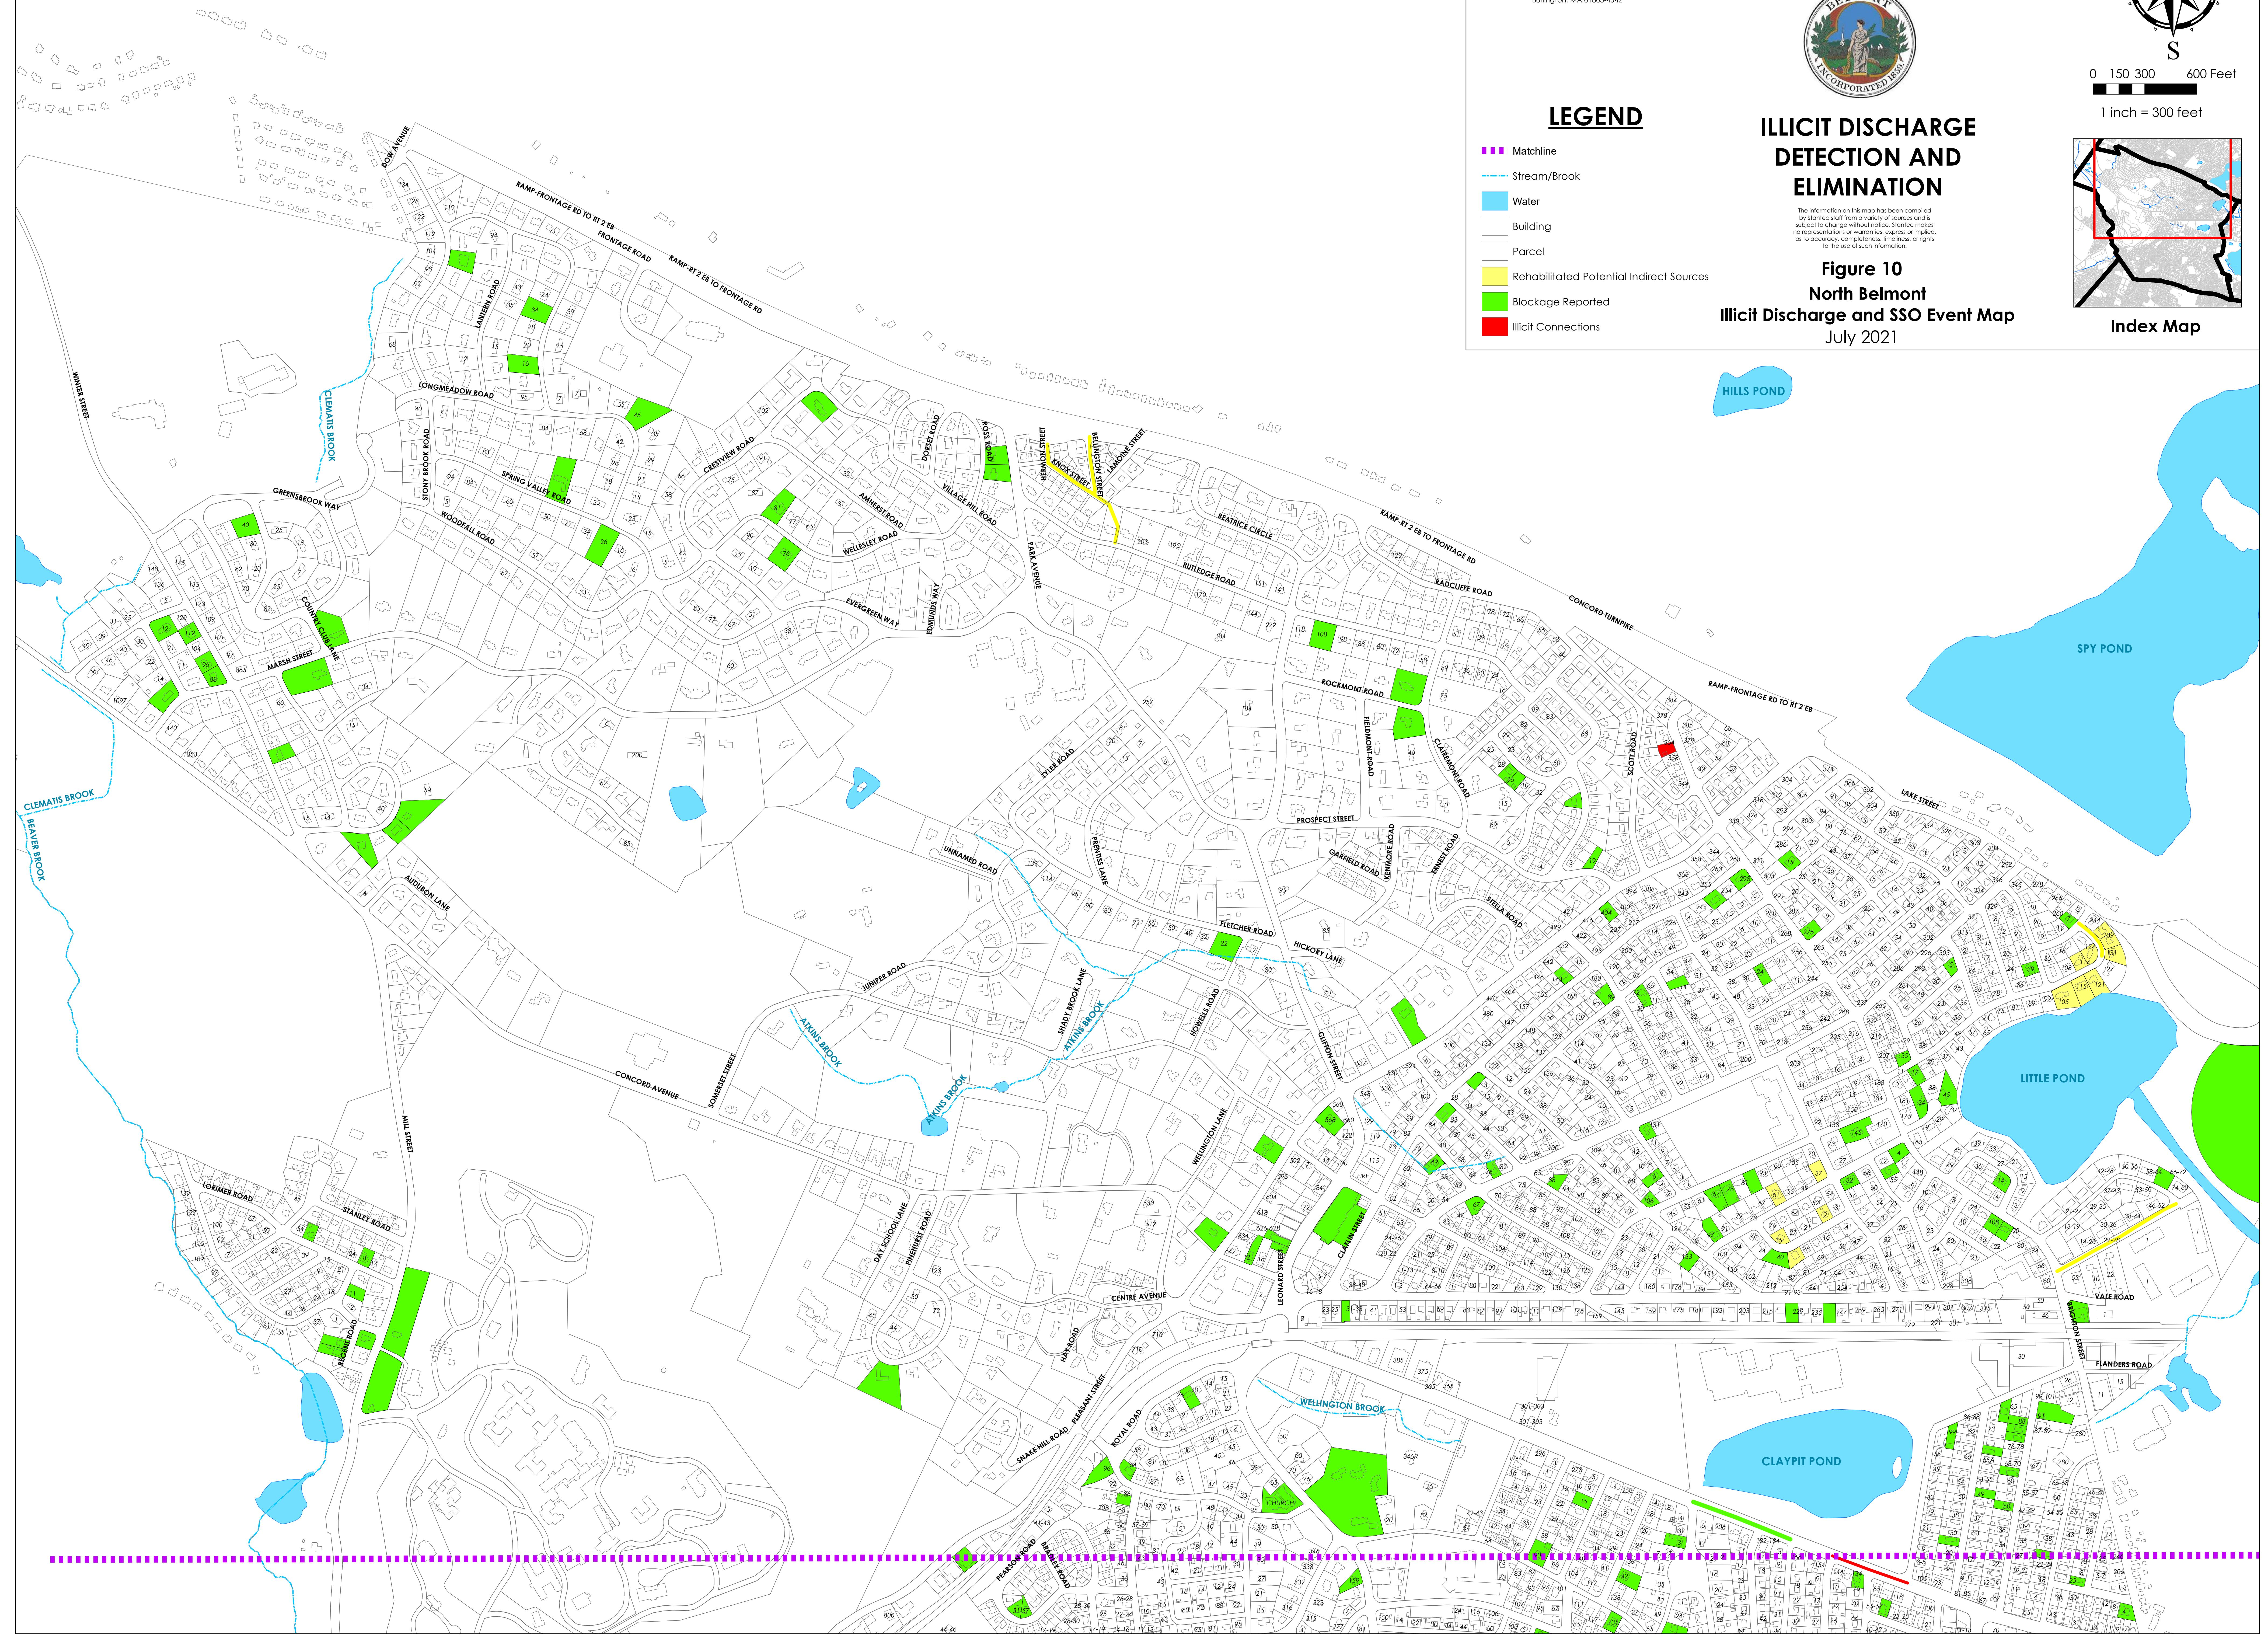


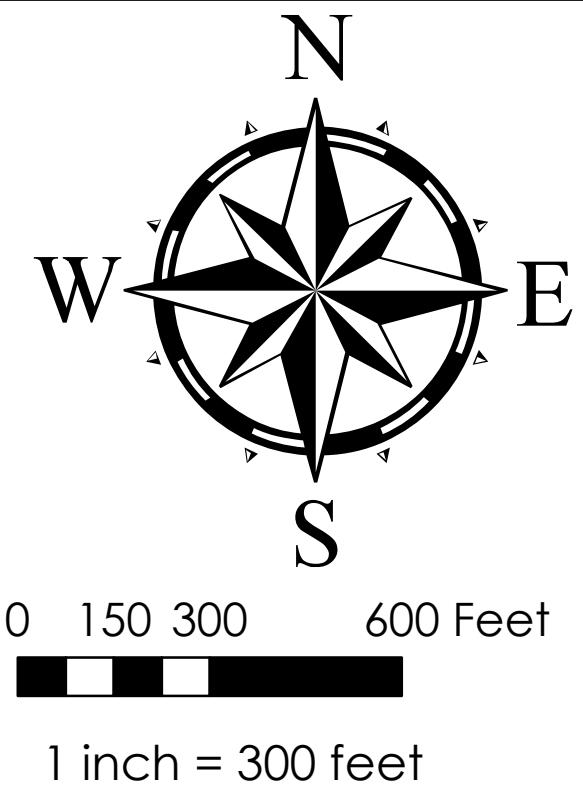

## ILLEGAL DISCHARGE DETECTION AND ELIMINATION

The information on this map has been compiled by Stantec staff from a variety of sources and is subject to change without notice. Stantec makes no representations or warranties, express or implied, as to the accuracy, completeness, or reliability of such information.


**Figure 11**  
**South Belmont**  
**Illicit Discharge and SSO Event Map**  
July 2021

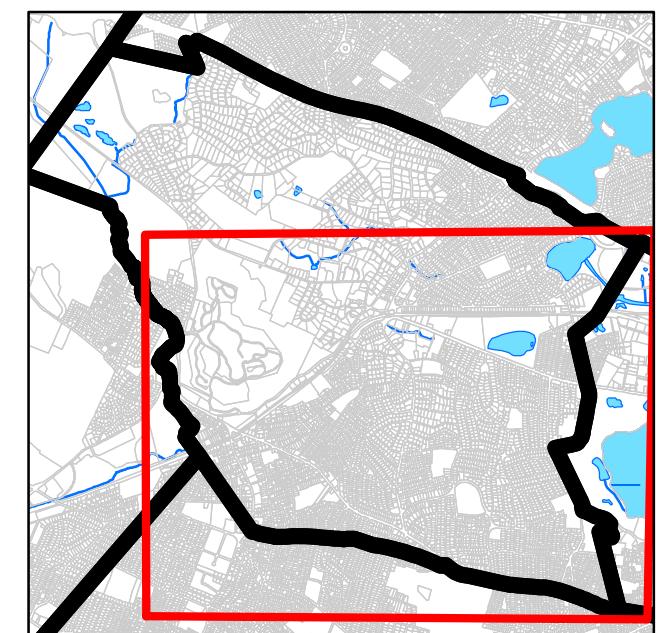

**Index Map**

### LEGEND

- Matchline
- Stream/Brook
- Water
- Building
- Parcel
- Rehabilitated Potential Indirect Sources
- Blockage Reported
- Illicit Connections

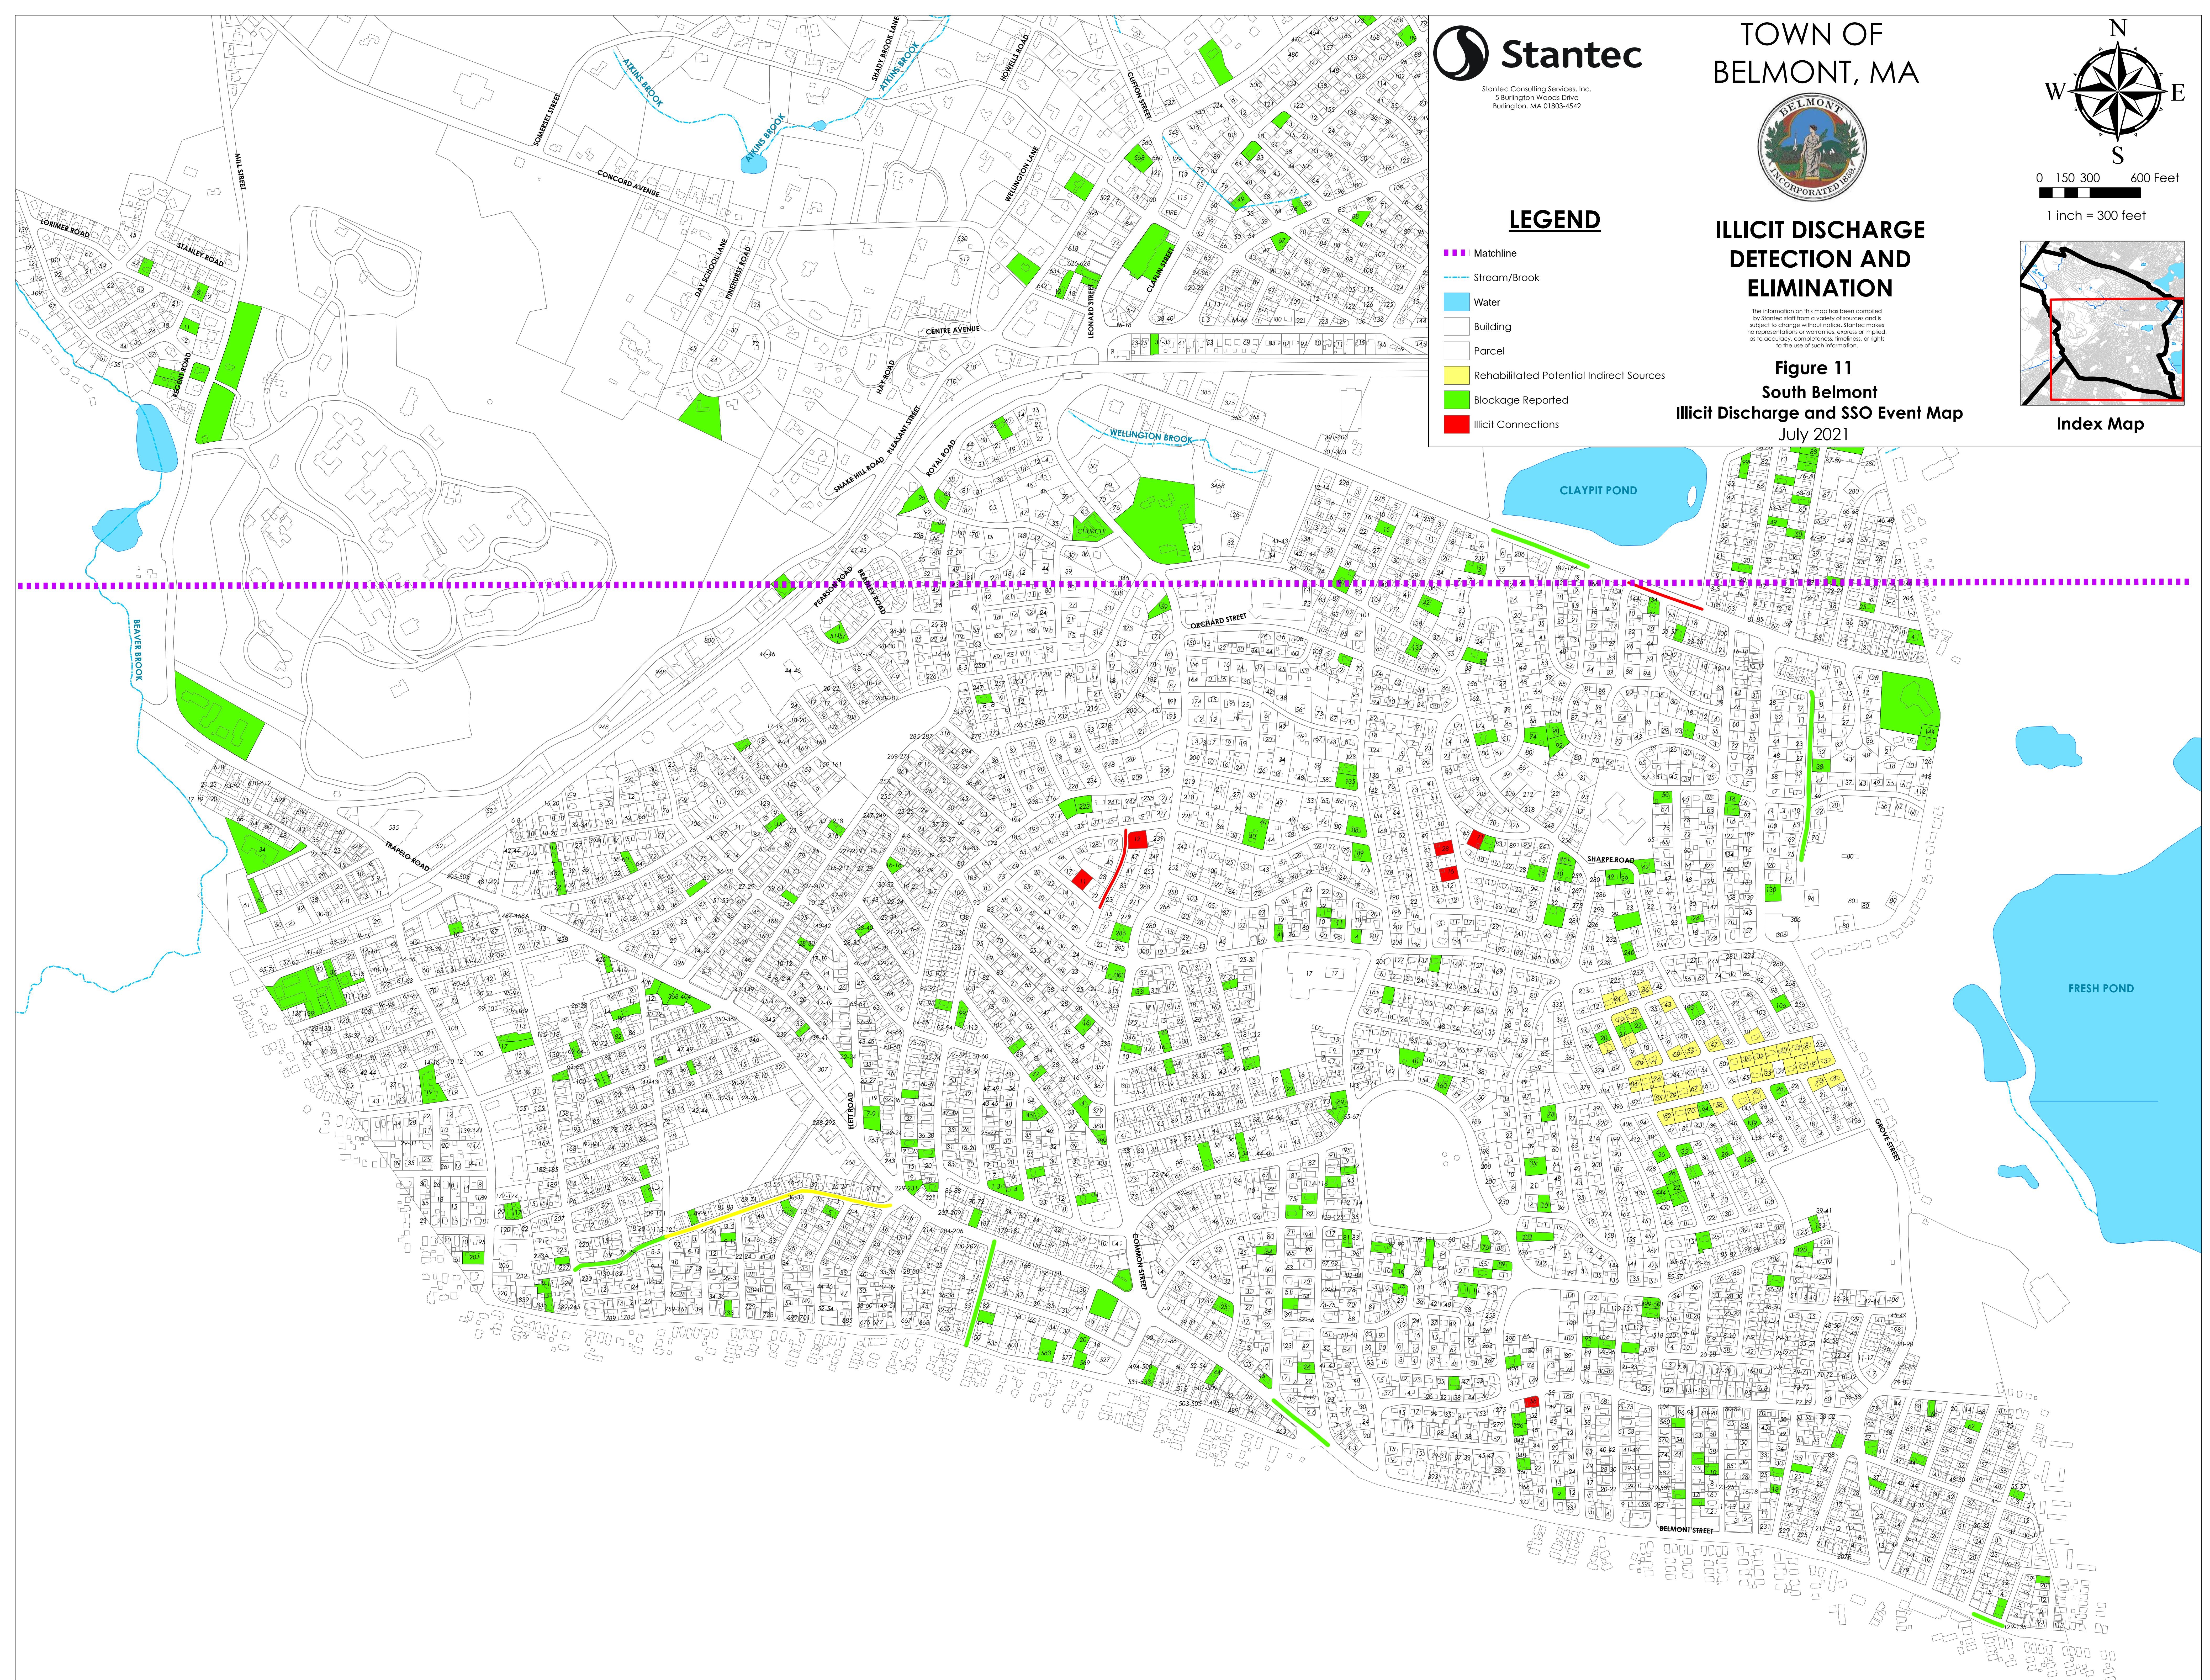

BELMONT, MA  
2021 IDDE INVESTIGATIONS - EPA Compliance Report July 2021

**TABLE 1**  
**Sub-catchment Areas - Reporting Period Sampling Results**

Dry Weather Sub-catchment Sampling																														
Sampling Parameter	Unit	Threshold Value	Sampling I										Sampling II										Sampling III		Sampling IV					
			OF-11A					OF-11B					OF-11C					OF-12A					OF-12B							
11/08/2016					06/23/2017					11/09/2020					03/23/2021					11/08/2016					11/08/2016		06/27/2017			
11/08/2016					06/23/2017					11/09/2020					03/23/2021					11/08/2016					11/08/2016		06/27/2017			
E-Coli	MPN/100mL	235	>10,000	13,800	1,200	4,900	8,600	>20,000	2,600	<100	>10,000	16,000	200	700	100	50	100	<100	DRY	10,200	3,000	1,900	700	1,050	14,900	12,600	<10			
Enterococci	MPN/100mL	61	2700	N.T.	N.T.	3200	N.T.	N.T.	N.T.	300	N.T.	N.T.	N.T.	N.T.	N.T.	50	N.T.	N.T.	DRY	N.T.	N.T.	N.T.	N.T.	900	N.T.	N.T.	N.T.			
Ammonia (NH <sub>3</sub> )	mg/L	0.5	0.35	0.6	0.45	1	0.5	>6	0.6	1	0.35	0.6	0.45	0.5	0.4	0.5	0.4	0.4	DRY	0.25	0.5	0.25	0	0.80	3.00	0.75	6.00			
Chlorine (Cl <sub>2</sub> )	mg/L	0.25	0.20	0.30	0.25	0.35	0.20	0.20	0.25	0.20	0.20	0.25	0.20	0.20	0.20	0.20	0.20	0.20	DRY	N.T.	N.T.	N.T.	N.T.	0.12	N.T.	N.T.	N.T.			
Salinity	ppt	0	0	N.T.	N.T.	N.T.	N.T.	0	N.T.	N.T.	0	N.T.	N.T.	N.T.	N.T.	0	N.T.	N.T.	DRY	N.T.	N.T.	N.T.	N.T.	0	N.T.	N.T.	N.T.			
Conductivity	µS	0	0	N.T.	N.T.	N.T.	N.T.	0	N.T.	N.T.	0	N.T.	N.T.	N.T.	N.T.	0	N.T.	N.T.	DRY	N.T.	N.T.	N.T.	N.T.	0	N.T.	N.T.	N.T.			
Temperature	°C	11.5	10.5	N.T.	N.T.	N.T.	N.T.	10.1	N.T.	N.T.	17.9	N.T.	N.T.	N.T.	N.T.	15.6	N.T.	N.T.	DRY	N.T.	N.T.	N.T.	N.T.	17.6	N.T.	N.T.	N.T.			
pH	-	7.46	7.01	N.T.	N.T.	N.T.	N.T.	7.55	N.T.	N.T.	7.85	N.T.	N.T.	N.T.	N.T.	7.08	N.T.	N.T.	DRY	N.T.	N.T.	N.T.	N.T.	7.71	N.T.	N.T.	N.T.			

Dry Weather Sub-catchment Sampling																													
Sampling Parameter	Unit	Threshold Value	Sampling Location, Sampling Date, and Measured Value																										
			S-1			S-2			S-3			S-4			S-5			S-6			S-7								
E-Coli	MPN/100mL	235	ND	1,700	800	1,350	1,950	1,100	1,300	19,700	100	ND	500	1,400	ND	22,000	1,900	1,100	220	4,800	200	1,550	14,400	1,200	10,600	1,300	1,250	ND	7,900
Enterococci	MPN/100mL	61	50	N.T.	N.T.	N.T.	300	N.T.	N.T.	N.T.	N.T.	ND	N.T.	N.T.	ND	N.T.	N.T.	260	N.T.	N.T.	N.T.	N.T.	150	N.T.	N.T.	N.T.	450	N.T.	N.T.
Ammonia (NH <sub>3</sub> )	mg/L	0.5	0.3	0.3	0.3	0	2.0	0.3	0.1	0.25	N.T.	0.1	0.25	0.4	0.3	0	N.T.	0.6	0.25	2	N.T.	0.1	0.2	N.T.	0.25	0	0	0.25	N.T.
pH	0.25	0.25	0.25	0.25	0.25	0.25	0.25	0.25	0.25	0.25	0.25	0.25	0.25	0.25	0.25	0.25	0.25	0.25	0.25	0.25	0.25	0.25	0.25	0.25	0.25	0.25	0.25	0.25	
Chlorine (Cl <sub>2</sub> )	mg/L	0.37	N.T.	N.T.	N.T.	N.T.	0.17	N.T.	N.T.	N.T.	N.T.	0.24	N.T.	N.T.	0.63	N.T.	N.T.	0.10	N.T.	N.T.	0.08	N.T.	N.T.	N.T.	N.T.	0.21	N.T.	N.T.	N.T.
Salinity	ppt	0	0	N.T.	N.T.	N.T.	0	N.T.	N.T.	N.T.	N.T.	0	N.T.	N.T.	0	N.T.	N.T.	0	N.T.	N.T.	0	N.T.	N.T.	N.T.	N.T.	0	N.T.	N.T.	N.T.
Conductivity	µs	0	N.T.	N.T.	N.T.	N.T.	0	N.T.	N.T.	N.T.	N.T.	0	N.T.	N.T.	1.9	N.T.	N.T.	0	N.T.	N.T.	0	N.T.	N.T.	N.T.	N.T.	0	N.T.	N.T.	N.T.
Temperature	°C	6.7	N.T.	N.T.	N.T.	N.T.	10.4	N.T.	N.T.	N.T.	N.T.	14.9	N.T.	N.T.	13.1	N.T.	N.T.	12.1	N.T.	N.T.	N.T.	4.8	N.T.	N.T.	N.T.	5.6	N.T.	N.T.	N.T.
UV254	µM	2.4	N.T.	N.T.	N.T.	N.T.	2.1	N.T.	N.T.	N.T.	N.T.	2.5	N.T.	N.T.	2.3	N.T.	N.T.	2.0	N.T.	N.T.	N.T.	2.8	N.T.	N.T.	N.T.	2.6	N.T.	N.T.	N.T.

Most Recent Reporting Period  
Sampled - None Detected  
Not Tested  
Not Sampled - Very little flow or wet but no flow  
System was dry

**BELMONT, MASSACHUSETTS**  
**2021 IDDE INVESTIGATIONS - EPA Compliance Report July 2021**

**TABLE 2**  
**MYSTIC RIVER WATERSHED TRIBUTARY AREAS**  
**SANITARY SEWER AND STORM DRAIN MAINLINE - RECOMMENDED REHABILITATION**

Street	Outfall Area	Priority*	Type	Manhole No.			Pipe Diameter (inches)	Pipe Material	Length Surveyed (feet)	Recommended Rehabilitation		No. of Service Connections	No. of Protruding Services	Location of Protruding Services	Notes
				Direction	Start	End				Line	Replace				
<b>OUTFALL 1</b>															
Fairview Ave	1	2-INC	Drain	Upstream	03D048	Upstream	6	VC	58	NRR	NRR	0			Incomplete Inspection - Pipe in good condition up to 58' moderate rootball
<b>OUTFALL 2</b>															
Houghton Rd	2	INC	Drain	Downstream	09D035	09D038	12	VC	142	NRR	NRR	3			3 services (20'(3:00), 73'(9:00), 90'(3:00))
Houghton Rd	2	2-INC	Drain	Downstream	09D038	09D035	12	VC	13	NRR	NRR	0			Incomplete Inspection - Heavy roots at 13'
Herbert Rd	2	2	Drain	Downstream	09D058	09D059	12	VC	295	NRR	NRR	9	3	146'(2"), 169'(2"), 268'(1")	minor to moderate roots at joints throughout; heavy roots in service at 62'; no cracks in pipe
Hartley Rd	2	2-INC	Drain	Downstream	09D067	09D064	12	VC	166	NRR	NRR	6	1	166'(3")	Incomplete Inspection - minor to moderate roots at joints throughout; minor to severe roots in service at 33', 42, 67', 115'; no cracks in pipe
Hartley Rd	2	INC	Drain	Upstream	09D064	09D067	12	VC	0	NRR	NRR				Incomplete Inspection - Heavy Rootball at start of pipe
Shaw Rd	2	3	Drain	Downstream	09D103	09D029	12	VC	332	332	NRR	6			several locations with minor longitudinal cracks
<b>OUTFALL 8-1</b>															
Lincoln Rd	8-1	2-INC	Drain	Upstream	19D051	19D052	12	VC	78	NRR	NRR	1			Incomplete Inspection - Utilize push camera due to bend at MH; pipe in good condition up to 78'
Lincoln Rd	8-1	2-INC	Drain	Downstream	19D052	19D051	12	VC	227	NRR	NRR	2			Incomplete Inspection - could not inspect beyond 227' due to bend at MH; pipe in good condition with one location with minor cracks
<b>TOTALS</b>									1,311	332	0	27	4		

\* 1 (Excellent Condition) - 5 (Severe Deterioration)

\*\* Distance from Starting Manhole in feet (Orientation of Service Lateral)

**Table 3****01-02-2021 to 06-26-2021 Total Stoppage**

Date	Address	Results
2021-01-02	15 GODEN ST	Rodded roots @ 12', 18', & 24'
2021-01-03	141 WASHINGTON ST	No Access
2021-01-05	17 ROSS RD	Rodded house service mega roots 42'
2021-01-05	26 AUDREY RD	Flushed house service from manhole roots & grease
2021-01-06	26 SPRING VALLEY RD	6' grease & 36' roots
2021-01-07	92 DOUGLAS RD	No Access
2021-01-08	275 BRIGHTON ST	18' roots
2021-01-12	2 YORK RD	There wasn't a sewer back up rodded anyways
2021-01-14	64-66 BAKER ST	No Stoppage rodded anyways
2021-01-14	48 LORIMER RD	Roots at 30' & 36'
2021-01-17	75 LEONARD ST	Flushed line in the Claflin St parking lot
2021-01-19	15 GORHAM RD	18' roots and pushed paper out
2021-01-20	135 SYCAMORE ST	Main line
2021-01-21	16 RUSSELL TER	No Access
2021-01-24	86 BAKER ST	Main line
2021-01-26	57 MORAINA ST	Flushed mainline and house service
2021-01-26	89 CHILTON ST	Roots @ 30ft
2021-01-30	47 UNITY AVE	Main line
2021-01-31	40 WESTLUND RD	Flushed House Service
2021-01-31	105 TRAPELO RD	Flushed House Service
2021-02-09	35 AUDREY RD	Flushed main line
2021-02-04	389 COMMON ST	Internal Problem
2021-02-05	6 BROAD ST	No Access Flushed from manhole in street
2021-02-10	134 CONCORD AVE	Flushed main line
2021-02-13	531 BELMONT ST	Rodded service pushed out @ 42'
2021-02-15	39 GILMORE RD	Rodded service & flushed line
2021-02-12	191 TRAPELO RD	Pushed out paper 6' cleared
2021-02-17	36 AUDREY RD	Flushed main- wipes & disposable diapers
2021-02-21	43 OAK AVE	Flushed line
2021-02-22	60-62 PAYSON RD	Pushed Out
2021-02-24	1 COLONIAL TER	36' Roots
2021-02-24	24 PINE ST	Push out 42' wipes
2021-02-25	36 AUDREY RD	Flushed main
2021-02-26	593 PLEASANT ST	Main line-flushed
2021-02-28	45 LARCH CIR	Paper @ 45'
2021-03-26	18 NEWTON ST	a pair of underwear
2021-03-01	16 PREBLE GARDENS RD	12' pushed out - light roots
2021-03-03	50 BAKER ST	No access the clean out was covered by hardwood floors
2021-03-07	63 CARLETON RD	No Access
2021-03-09	35 AUDREY RD	Wipes & adult diapers
2021-03-09	115 WHITE ST	Flushed line
2021-03-10	35 HILLSIDE TER	Internal
2021-03-10	90 SCHOOL ST	12', 50', & 60' Roots

2021-03-10	180 BEECH ST	Pushed out 60'
2021-03-13	115 MILL ST	Flushed main line
2021-03-15	15 ARTHUR RD	Flushed from manhole-went out 26'
2021-03-19	40 WESTLUND RD	Flushed main
2021-03-24	21 HERBERT RD	Rodded line-30' roots
2021-03-22	4 HOWARD ST	18' roots & 36' mega roots
2021-03-19	112 PAYSON RD	18' pushed out
2021-03-27	14 GILBERT RD	No entry-cap stuck
2021-03-29	39 BENTON RD	Rodded line 80'-Internal
2021-04-02	13 ALMA AVE	12' Pushed out
2021-04-06	25 MERRILL AVE	Roots at 10', 12', 48' and flushed main
2021-04-07	354 PAYSON RD	Mainline
2021-04-09	18 FALMOUTH ST	30' roots
2021-04-09	6 BROAD ST	Flushed from manhole on street to house
2021-04-10	50 GALE RD	No Access
2021-04-11	21 HERBERT RD	36' roots
2021-04-11	232 PAYSON RD	12-18' roots
2021-04-12	4 GORHAM RD	Resident's lateral pipe is broken
2021-04-15	75 SHERMAN ST	Flushed main
2021-04-15	130 BRIGHT RD	36' & 48' roots
2021-04-15	11 TOWNSEND RD	18' roots
2021-04-16	14 GALE RD	Rod line 12' roots
2021-04-17	388 TRAPELO RD	Flushed main - grease
2021-04-18	10 THAYER ST	Flushed main
2021-04-19	69 PINEHURST RD	No Access
2021-04-19	40 PAYSON RD	Roots @ 24'
2021-04-16	17 DOUGLAS RD	12-20' Pushed out
2021-04-20	336 PAYSON RD	Rodded and Flushed house service
2021-04-20	37 WILSON AVE	No backup-no access
2021-04-21	110 WATSON RD	Rodded line-internal problem
2021-04-21	36 THAYER RD	12' pushout
2021-04-22	26 CUMBERLAND RD	Flushed from MH to house (baby wipes)
2021-04-22	285 COMMON ST	No Access
2021-04-22	22 HARTLEY RD	Rodded line-clear-internal problem-upstairs toilet backed up
2021-04-22	51 SPRING VALLEY RD	cleared line
2021-04-22	78 ELIZABETH RD	Main line flushed and cleared-grease
2021-04-25	21 HERBERT RD	Rodded 36' paper & roots - cleared
2021-04-26	17 GRANT AVE	Flushed main
2021-04-29	303 COMMON ST	No Backup found
2021-04-30	23 PARTRIDGE LN	Flushed from manhole to house
2021-05-03	91 BAKER ST	Rodded 48' paper and roots
2021-05-01	148 OAKLEY RD	Flushed main line-pine @ oakley
2021-05-03	14 GILBERT RD	No Access
2021-05-04	148 OAKLEY RD	Mainline flushed grease
2021-05-05	14 GILBERT RD	36' pushout
2021-05-07	330 PAYSON RD	Flushed House Service
2021-05-09	81 CUSHING AVE	Main line


2021-05-10	43 OAK AVE	No Backup-flushed house service
2021-05-10	75 SHERMAN ST	Main line flushed
2021-05-10	10 JACOB RD	Flushed from manhole
2021-05-11	159 COMMON ST	Rodded-Roots@30'
2021-05-11	26 ROYAL RD	36' Roots
2021-05-14	336 PAYSON RD	Main line flushed
2021-05-17	12-14 WORCESTER ST	Line flushed & rodded (clear) Note: pipe is flat and holds water
2021-05-22	35 AUDREY RD	Flushed and Cleared Main
2021-05-25	5 LODGE RD	Flushed from manhole in driveway to street, lots of paper and roots
2021-05-25	2 CONCORD AVE	Sewer backup at temple, main line blocked, 145ft block between Merrill Ave & Colby St off Blanchard Rd.
2021-05-26	108 RUTLEDGE RD	Bagged twice-roots & paper at 72'
2021-05-29	139 DALTON RD	Rodded 66' bagged line
2021-05-29	44 MAPLE ST	Pushed out at 6'
2021-06-01	45 LONGMEADOW RD	36' Roots
2021-06-01	503 SCHOOL ST	12-18' Roots
2021-06-03	35 HILLSIDE TER	Flushed from Manhole in driveway - clear
2021-06-08	25 MERRILL AVE	12 ft roots
2021-06-08	LESLIE RD	18-24' push out
2021-06-10	28 TEMPLE ST	No Backup
2021-06-10	74 STONE RD	Roots at 15ft, 20ft, & 66ft
2021-06-10	569 BELMONT ST	Flushed from manhole, checked with owner, cleared
2021-06-13	106 DEAN ST	Owner resolved issue
2021-06-17	137 BELMONT ST	Roots @ 12' & 24"
2021-06-21	42 OAK ST	45' push out
2021-06-26	77 BOW RD	No Access

**Attachment 1**

**Private Sector Sump Pump Removal & Sewer System**

**Rehabilitation**

**Contract Drawings**

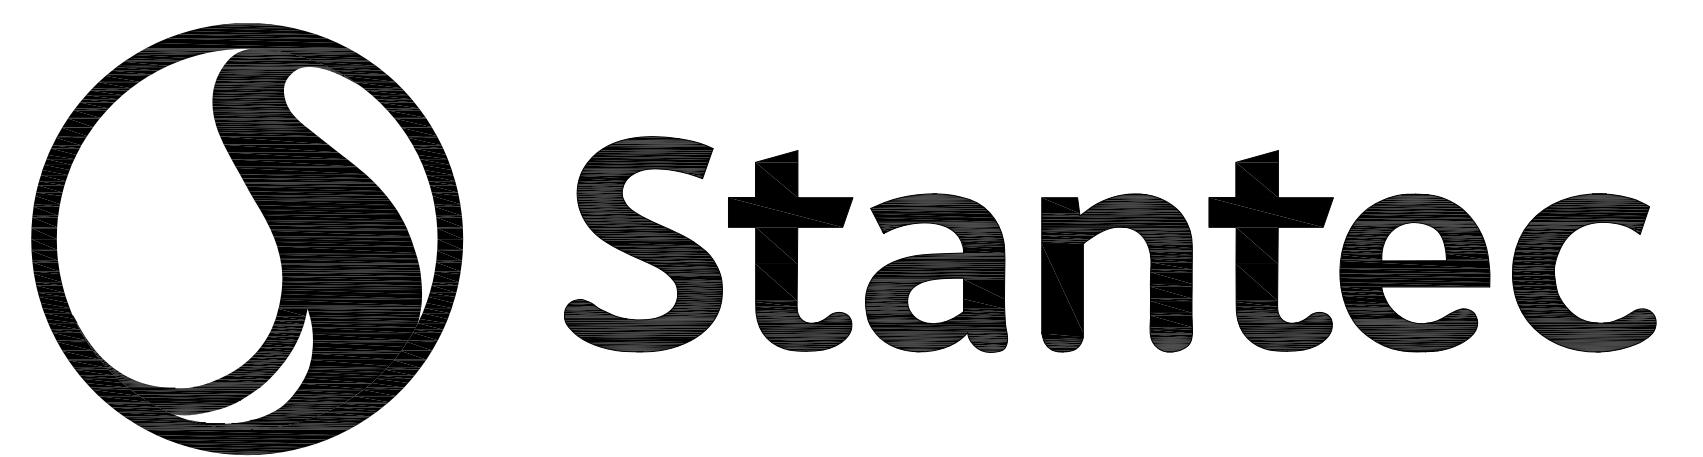



TOWN OF BELMONT, MASSACHUSETTS

PRIVATE SECTOR SUMP PUMP  
REMOVAL & SEWER SYSTEM  
REHABILITATION  
MWRA PROJECT NO.  
WRA-P11-04-3-1124 &  
MWRA PROJECT NO.  
WRA-P11-04-3-1160

INDEX TO DRAWINGS

SHEET NO.	DRAWING NO.	TITLE
1	G-001	COVER
2	G-002	KEY PLAN NORTH
3	G-003	KEY PLAN SOUTH
4	C-001	LEGEND, ABBREVIATIONS AND GENERAL NOTS
5	C-101	KING STREET, BARTLETT AVENUE AND SUNNYSIDE PLACE
6	C-102	HOMER ROAD AND HASTINGS ROAD
7	C-103	PALFREY ROAD, GARDEN STREET AND VAN NESS ROAD
8	C-104	LEONARD STREET
9	C-105	MIDDLECOT STREET AND HURLEY STREET
10	C-106	SHERMAN STREET AND HAMMOND ROAD
11	C-107	RADCLIFFE ROAD
12	C-108	CROSS STREET AND LAKE STREET
13	C-109	PROSPECT STREET
14	C-110	ORCHARD STREET AND EDWARD STREET
15	C-111	CHARLES STREET
16	C-112	WINTHROP ROAD AND SLADE STREET
17	C-113	GLENDALE ROAD
18	C-114	FAIRMONT STREET AND HIGHLAND ROAD
19	C-115	HILLCREST ROAD
20	C-116	STULTS ROAD
21	C-117	TOWNSEND ROAD AND PAYSON ROAD
22	C-118	WOODS ROAD AND BACON ROAD
23	C-119	DALTON ROAD AND ANIS ROAD
24	C-120	SUMP PUMP – HOITT RD, SHERMAN ST, BRIGHTON ST AND COOLIDGE RD
25	C-121	SUMP PUMP – CROSS ST, LEXINGTON ST AND SLADE ST
26	C-122	SUMP PUMP – WAVERLEY ST, HOMER RD AND COMMON ST
27	C-123	SUMP PUMP – COTTAGE ST, SPINNEY TERR, GODEN ST AND SCHOOL ST
28	C-124	SUMP PUMP – GODEN ST, CONCORD AVE AND BAKER ST
29	C-125	SUMP PUMP – WASHINGTON ST, DALTON RD, LIVERMORE RD AND BETTS RD
30	C-126	SUMP PUMP – ANIS RD, CLAFLIN ST AND HARTLEY RD
31	C-501	SUMP PUMP RELOCATION DETAILS
32	C-502	MISCELLANEOUS DETAILS 1 OF 2
33	C-503	MISCELLANEOUS DETAILS 2 OF 2

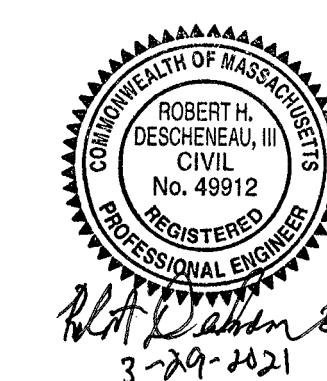


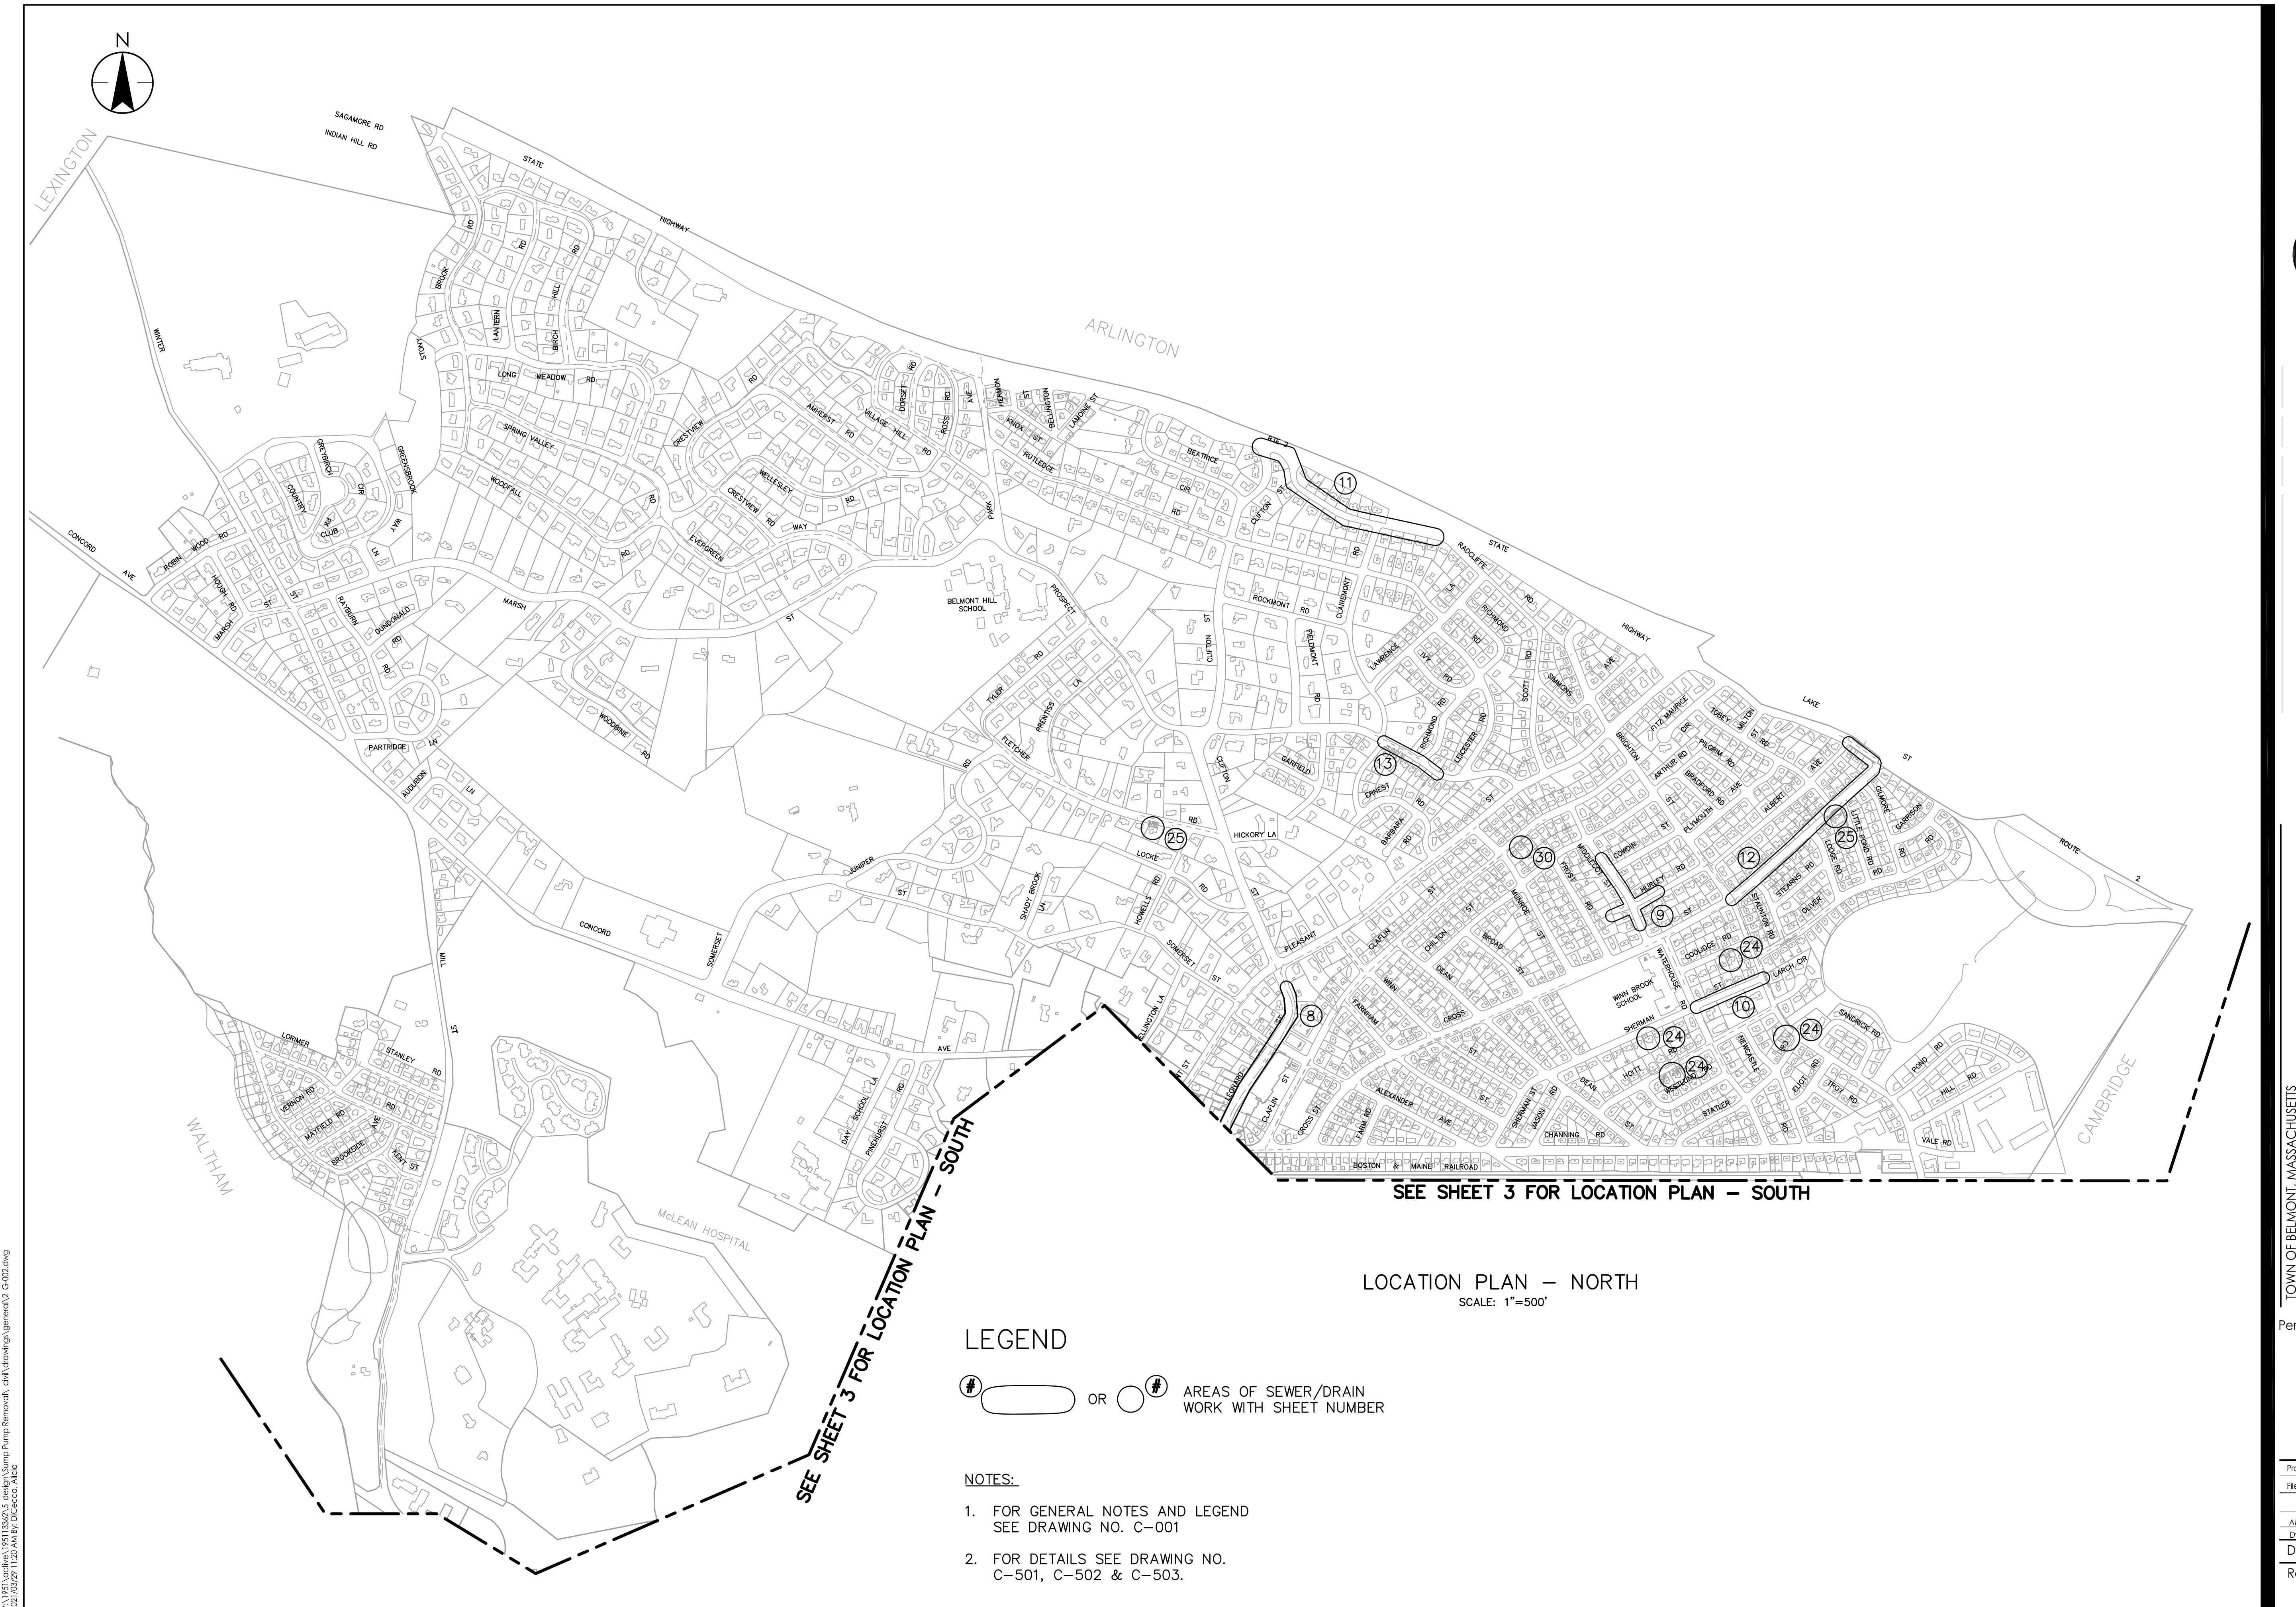

# PRIVATE SEWER SYSTEM REMOVAL & SEWER SYSTEM REHABILITATION

MWRA PROJECT NO. WRA-P-1 | 04-3-1 | 60  
BELMONT, MASSACHUSETTS  
KEY PLAN NORTH

**Health Seal**

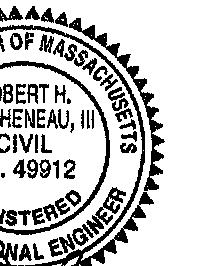

Number: 195113362

me:

21.03.21

RHD      RPB      21.03.31  
Chkd.      Dsgn.      YY.MM.DD

wing No. G-002

## Position Sheet

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### LEGEND



AREAS OF SEWER/DRAIN  
WORK WITH SHEET NUMBER

### LOCATION PLAN - SOUTH


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### NOTES:

- FOR GENERAL NOTES AND LEGEND  
SEE DRAWING NO. C-001
- FOR DETAILS SEE DRAWING NO.  
C-501, C-502 & C-503.

TOWN OF BELMONT, MASSACHUSETTS  
PRIVATE SECTOR SUMP PUMP REMOVAL &  
SEWER SYSTEM REHABILITATION  
MWRA PROJECT NO. WRA-P11-04-3-1124 &  
MWRA PROJECT NO. WRA-P11-04-3-1160  
BELMONT, MASSACHUSETTS

Permit-Seal

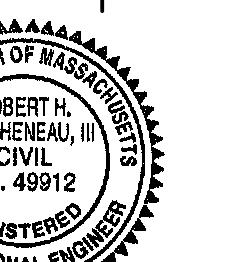

Project Number:	195113362		
File Name:			
AMD	RHD	RPB	21.03.31
Dwn.	Chkd.	Disp.	YY.MM.DD
Drawing No. G-003			
Revision	Sheet		
0	3 of		



## GENERAL NOTES

- THE CONTRACTOR SHALL NOT ENTER A PRIVATE PROPERTY PRIOR TO COORDINATION WITH THE BUILDING OWNER, CONTRACTOR AND THE TOWN OF BELMONT.
- THE CONTRACTOR SHALL PROVIDE A LICENSED PLUMBER TO PERFORM BUILDING INFLOW REMOVAL WORK GOVERNED BY 248 CMR 10.00: UNIFORM STATE PLUMBING CODE. THE CONTRACTOR SHALL PROVIDE ALL COUPLINGS, FITTINGS, VALVES AND CLEANOUTS AS REQUIRED BY 248 CMR 10.00.
- THESE PLANS HAVE BEEN COMPILED FROM EXISTING PLANS AND ON-SITE OBSERVATIONS AND CCTV INSPECTIONS.
- PROFILES OF EXISTING GROUND SURFACE ARE BASED UPON DATA OBTAINED FROM TOWN OF BELMONT, MA RECORD DRAWINGS, SUPPLEMENTED WITH A PARTIAL SURVEY BY STANTEC.
- THE LOCATIONS OF EXISTING DRAINS, SEWERS, WATER MAINS, GAS MAINS AND OTHER UTILITIES ARE APPROXIMATE ONLY. ACTUAL LOCATIONS IN THE FIELD MAY BE DIFFERENT. CONTRACTOR SHALL EXCAVATE TEST PITS AT NEW MANHOLE LOCATIONS TO CONFIRM. CONTRACTOR SHALL PROVIDE SUPPORT AND PROTECTION OF UTILITIES AS REQUIRED.
- NOT ALL OF THE SEWER, DRAIN, WATER, GAS, TELEPHONE, CABLE, ELECTRIC SERVICES, AND OTHER OVERHEAD OR UNDERGROUND UTILITY SERVICES TO BUILDING ARE SHOWN. THE CONTRACTOR SHALL ANTICIPATE THAT EACH PROPERTY WILL HAVE SERVICE CONNECTION FOR THE VARIOUS UTILITIES, SIZE, MATERIAL, AND LOCATION OF EXISTING UTILITIES AND SERVICE IN PROJECT VICINITY SHALL BE VERIFIED OR DETERMINED BY THE CONTRACTOR. RECORD DRAWINGS PREPARED BY THE CONTRACTOR FOR THIS PROJECT SHALL INCLUDE THIS FIELD VERIFIED INFORMATION. THE OWNER ASSUMES NO RESPONSIBILITY FOR THE ACCURACY OF THE EXISTING UTILITY INFORMATION.
- ANY AREA DISTURBED BY THE CONTRACTOR OUTSIDE THE LIMIT OF WORK SHALL BE RESTORED TO ORIGINAL CONDITION AT NO ADDITIONAL COST TO THE OWNER.
- ALL GROUND SURFACES SHALL BE PROTECTED TO PREVENT EROSION AND SEDIMENT ON THE SITE.
- THE CONTRACTOR SHALL PROVIDE DUST CONTROL FOR EXCAVATION AND CONSTRUCTION OPERATIONS.
- CONCRETE ENCASEMENTS ARE TO BE PROVIDED WHERE NEW SEWER LINES CROSS UNDER OR OVER AND WITHIN 18" OF EXISTING WATER MAINS.
- WHERE NEW PAVEMENT MEETS EXISTING PAVEMENT, THE JOINTS SHALL BE SAW CUT TO A NEAT HORIZONTAL/VERTICAL LINE.
- THE CONTRACTOR MUST NOTIFY ALL UTILITIES PRIOR TO PERFORMING ANY EXCAVATION WORK IN THE TOWN OF BELMONT, THE TOWN OF BELMONT WATER DEPARTMENT AND MASSACHUSETTS WATER RESOURCES AUTHORITY ARE NOT MEMBERS OF "DIG-SAFE" AND MUST BE NOTIFIED DIRECTLY AT LEAST 48 HOURS PRIOR TO START OF WORK.
- ALL ELEVATIONS ARE REFERRED TO CITY OF BOSTON BASE DATUM (5.65 BELOW THE NATIONAL GEODETIC VERTICAL DATUM OF 1929) UNLESS OTHERWISE INDICATED.
- ELEVATIONS SHOWN FOR SEWERS REFER TO THE FINISHED INVERT.
- ALL EXISTING SEWERS AND STORM DRAINS ARE VITRIFIED CLAY PIPE (VCP) UNLESS OTHERWISE INDICATED.
- SERVICE LATERALS SHALL BE REPLACED TO THE EDGE OF PAVEMENT, UNLESS OTHERWISE INDICATED.
- THE CONTRACTOR IS ALERTED TO THE PRESENCE OF OVERHEAD UTILITIES THAT MAY EFFECT HIS OPERATIONS DURING THE EXECUTION OF THE PROPOSED WORK. THE CONTRACTOR IS REQUIRED TO IDENTIFY THE LOCATION OF EXISTING OVERHEAD UTILITIES AND PLAN HIS OPERATIONS ACCORDINGLY.

## ABBREVIATIONS

A/ABAN	ABANDON	HORZ	HORIZONTAL
APPROX	APPROXIMATELY	LP	LIGHT POLE
B	BEND	SS	SANITARY SEWER
BCC	BIT CONC CURB	ST	STONE WALL
BIT	BITUMINOUS	PVC	POLYVINYL CHLORIDE
BSW	BIT. SIDEWALK	RCP	REINFORCED CONCRETE PIPE
CB	CATCH BASIN	RED	REDUCER
CI	CAST IRON	R&D	REMOVE & DISPOSE
CIP	CAST IRON PIPE	R&R	REMOVE & REPLACE
CC	CONCRETE CURB	RW	RETAINING WALL
CONC	CONCRETE	T	TEE
CLF	CHAIN LINK FENCE	TB	THRUST BLOCK
CMP	CORRUGATED METAL PIPE	TYP.	TYPICAL
C.T.E.	CONNECT TO EXISTING	UP	UTILITY POLE
CSW	CONC. SIDEWALK	VCP	VITRIFIED CLAY PIPE
E	ELECTRICAL	VERT	VERTICAL
EXIST	EXISTING	HYD	FIRE HYDRANT
WG	WATER GATE VALVE		
GC	GRANITE CURB		
GW	GRANITE WALL		

## LEGEND



SEWER OR DRAIN MANHOLES ARE SHOWN IN PROFILE THUS:




NEW SEWER OR DRAIN MANHOLES ARE SHOWN IN PLAN THUS:



GRAVITY SEWERS AND DRAINS ARE SHOWN IN PLAN THUS:



SEWER PIPE LINING ARE SHOWN IN PLAN THUS:

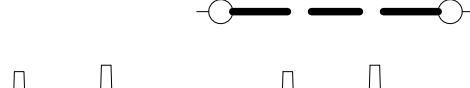

SEWER PIPE LINING ARE SHOWN IN PROFILES THUS:



DRAIN PIPE FOR SUMP PUMP DISCHARGE ARE SHOWN IN PLAN THUS:




SEWER SERVICE LATERAL REPLACEMENT ARE SHOWN IN PROFILES THUS:




POINT REPAIR ARE SHOWN IN PLAN THUS:




MECHANICAL PIPE PLUG ARE SHOWN IN PLAN THUS:

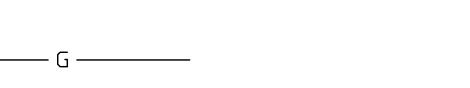

ELECTRIC CO. DUCTS ARE SHOWN THUS:

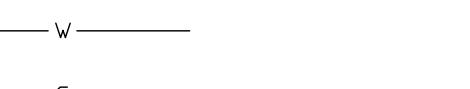

WATER MAINS ARE SHOWN THUS:

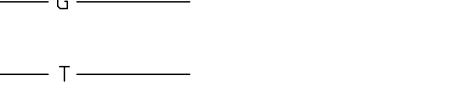

GAS MAINS ARE SHOWN THUS:



TELEPHONE CO. DUCTS ARE SHOWN THUS:



CABLE TV (CATV) LINES ARE SHOWN THUS:



OVERHEAD WIRES ARE SHOWN THUS:



CURBING IS SHOWN THUS:



FENCES ARE SHOWN THUS:



TELEPHONE CO. MANHOLES ARE SHOWN THUS:



TELEPHONE CO. HANDHOLES ARE SHOWN THUS:



UTILITY POLES ARE SHOWN THUS:




LIGHT POLES ARE SHOWN THUS:



HYDRANTS ARE SHOWN THUS:



WATER GATES ARE SHOWN THUS:

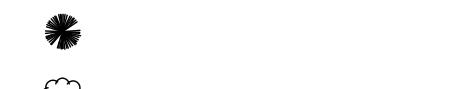

GAS GATES ARE SHOWN THUS:



CABLE TV PEDESTALS (C-PED) ARE SHOWN THUS:



CABLE TV VAULTS (CV) ARE SHOWN THUS:



CABLE TV HANDHOLES (CHH) ARE SHOWN THUS:



CATCH BASINS ARE SHOWN THUS:



DECIDUOUS TREES ARE SHOWN THUS:



EVERGREEN TREES ARE SHOWN THUS:




SHRUBS ARE SHOWN THUS:

TOWN OF BELMONT, MASSACHUSETTS  
PRIVATE SECTOR SUMP PUMP REMOVAL &  
SEWER SYSTEM REHABILITATION

MWRA PROJECT NO. WRA-P11-04-3-1124 &  
MWRA PROJECT NO. WRA-P11-04-3-1160  
BELMONT, MASSACHUSETTS

LEGEND, ABBREVIATIONS AND GENERAL NOTES

Permit-Seal

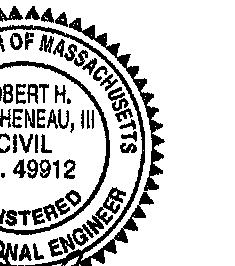

Project Number: 195113362


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Drawing No. C-001

Revision Sheet

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SEWER SYSTEM REHABILITATION  
MWRA PROJECT NO. WRA-P11-04-3-1124 &  
MWRA PROJECT NO. WRA-P-11-04-3-1160  
BELMONT, MASSACHUSETTS  
KING STREET, BARTLETT AVENUE AND SUNNYSIDE PLAC

The seal is circular with a scalloped outer edge. The words "COMMONWEALTH OF MASSACHUSETTS" are written along the top inner border, and "PROFESSIONAL ENGINEERS" are along the bottom. In the center, it says "ROBERT H. DESCHENEAU, III" above "CIVIL" and "No. 49912". Below that, it says "REGISTERED" and "PROFESSIONAL ENGINEER".

Number: 195113362

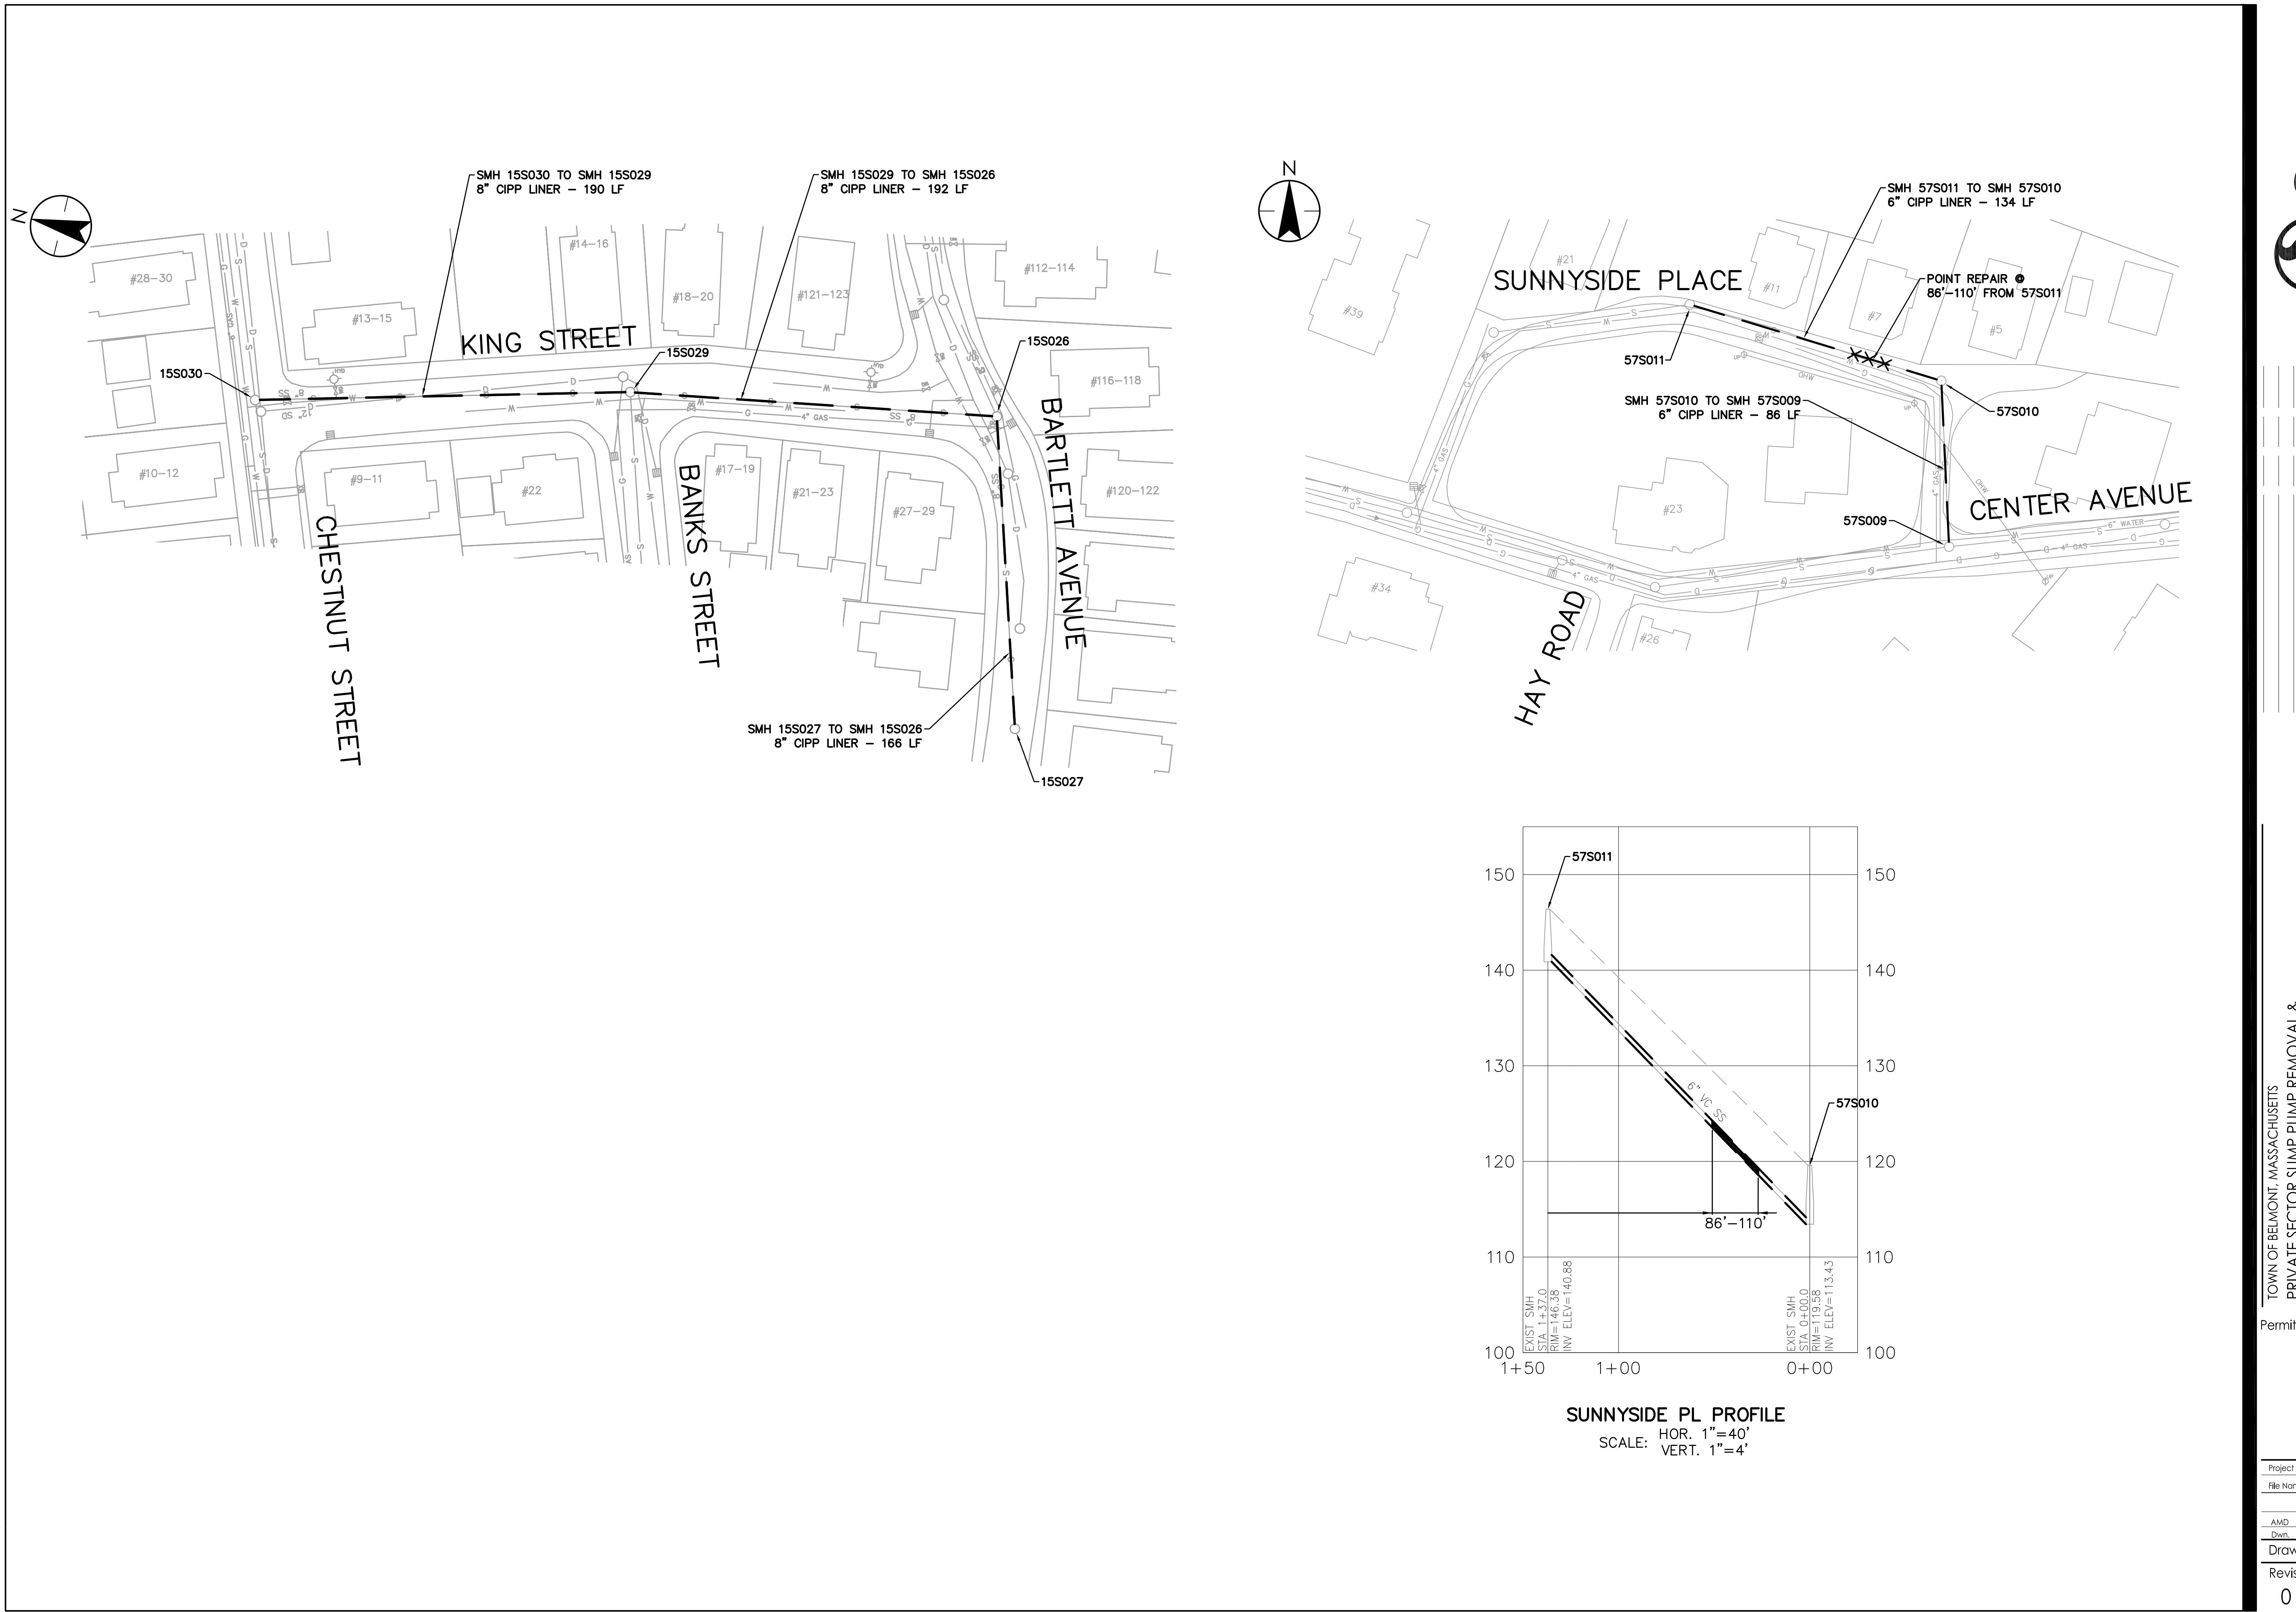
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RHD RPB 21.03.



Chkd. Dsgn. YY.MM  
g No. C-101

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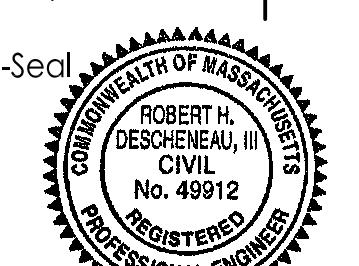
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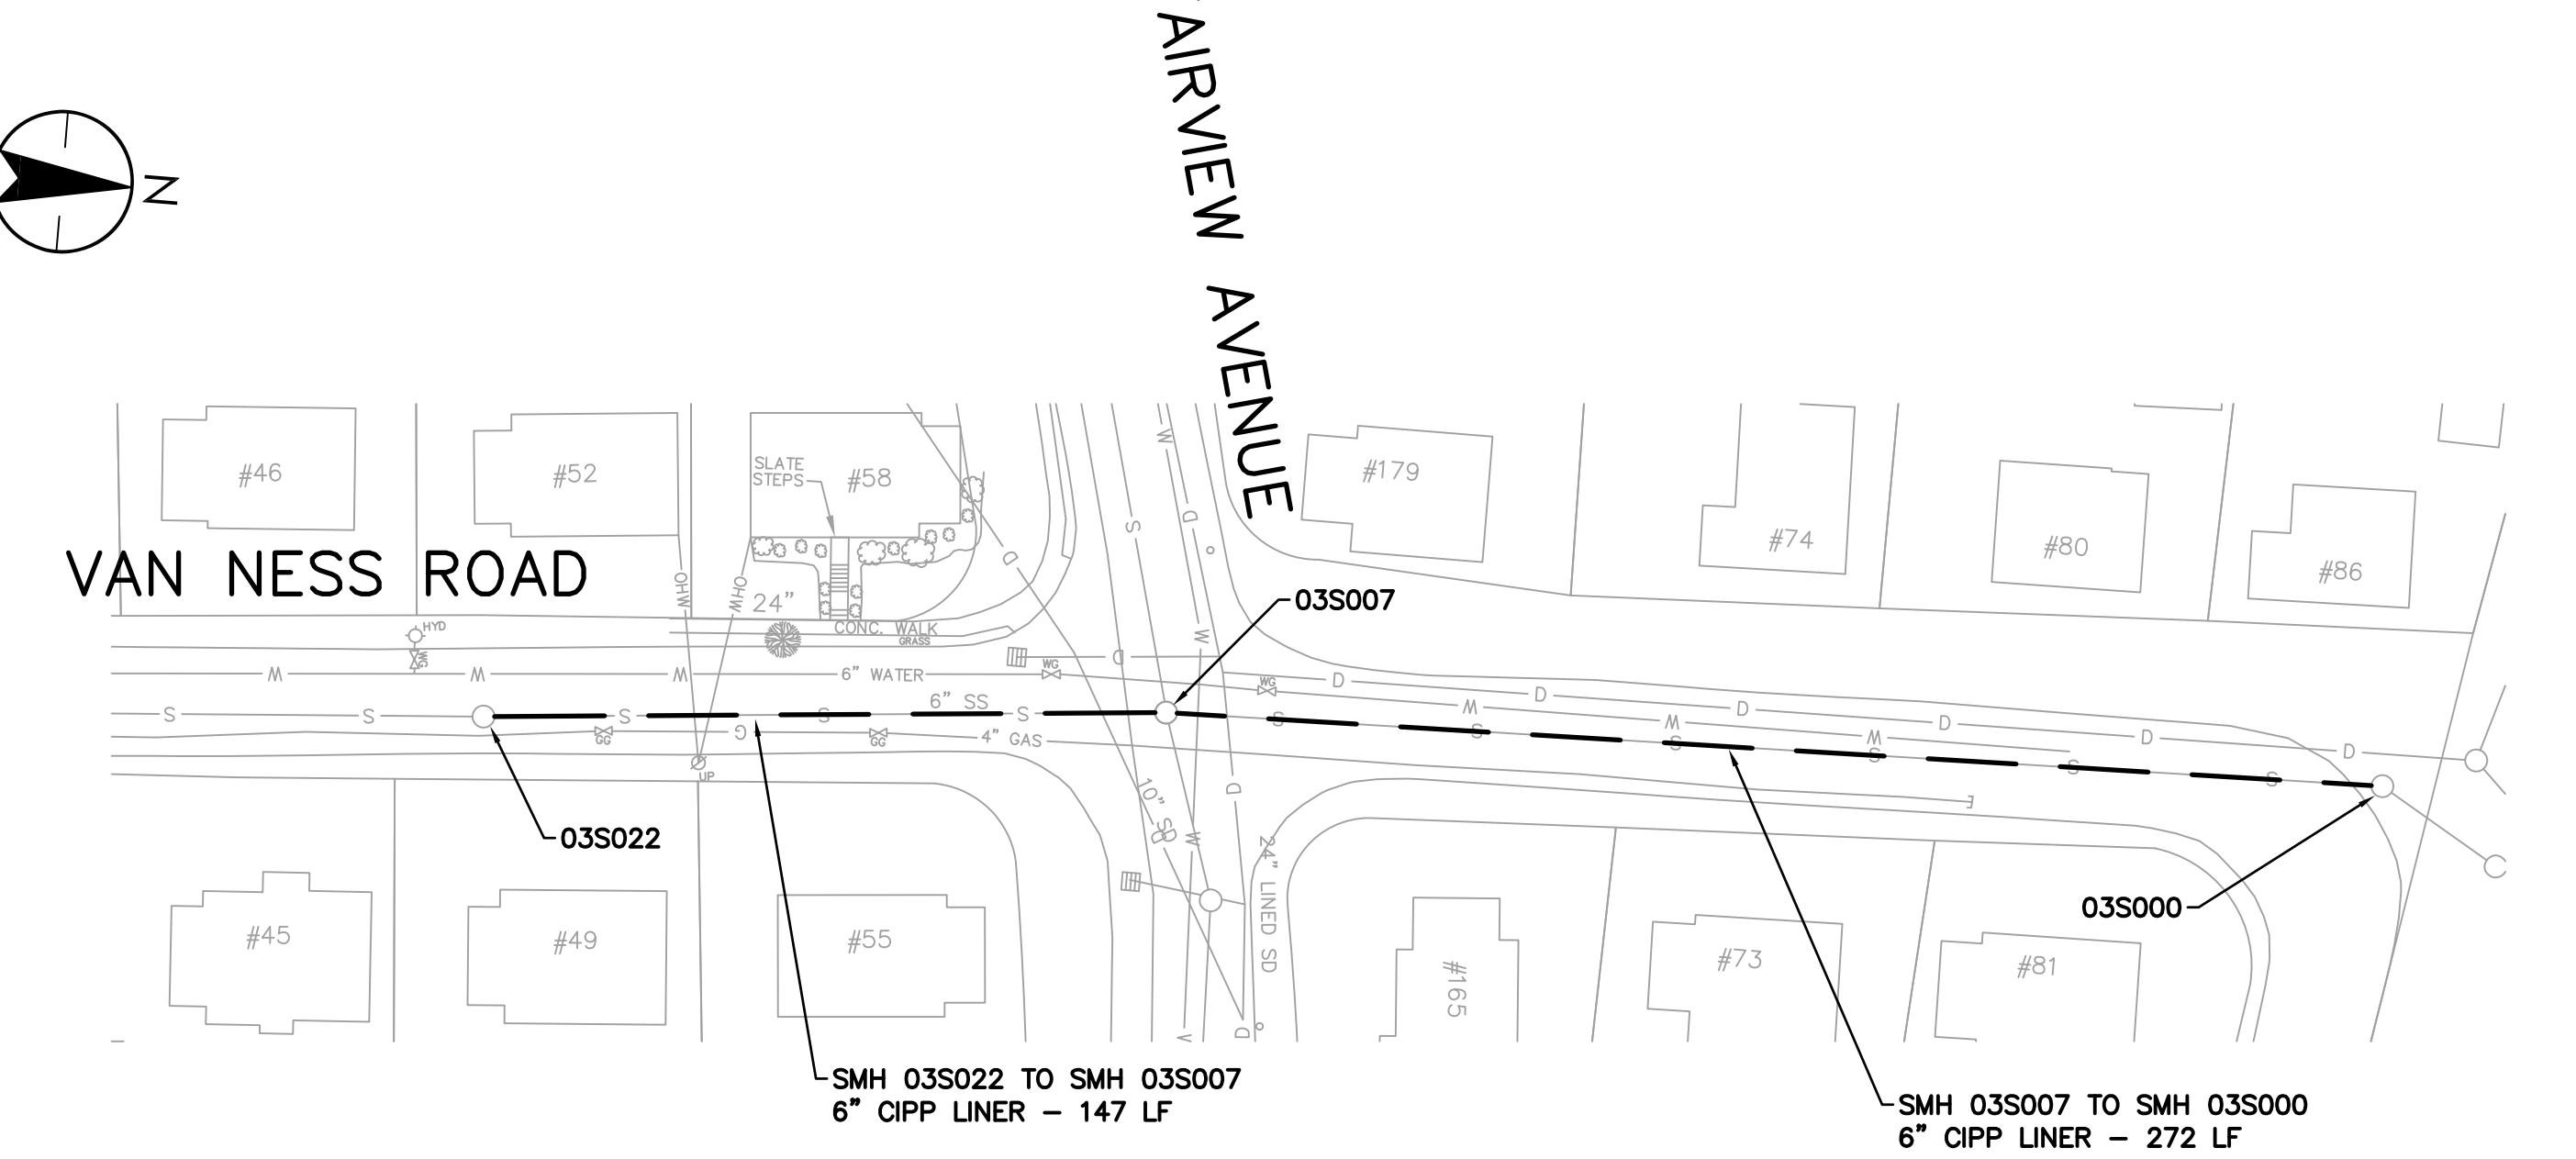
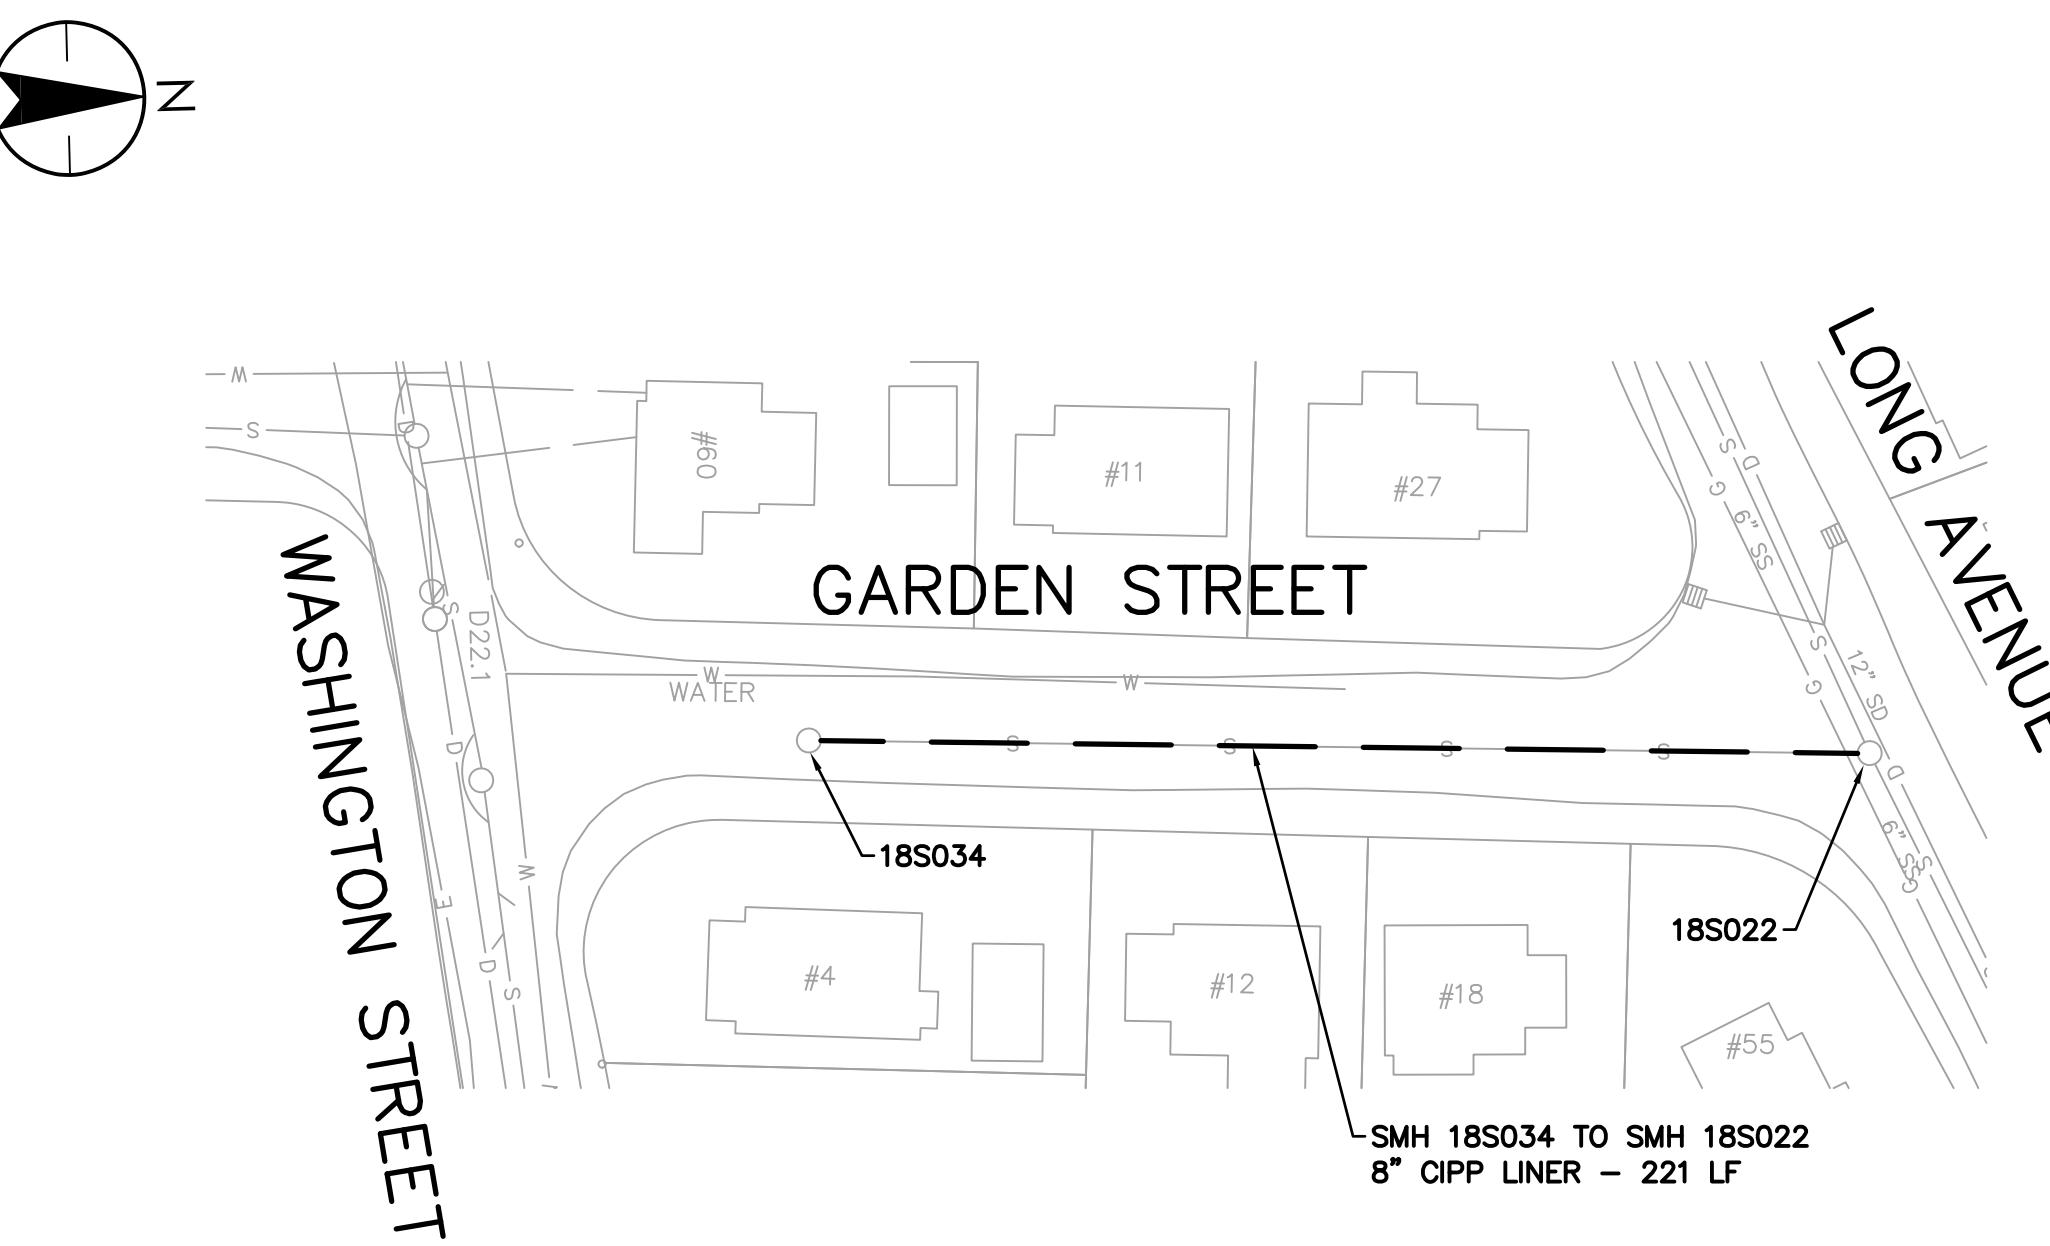
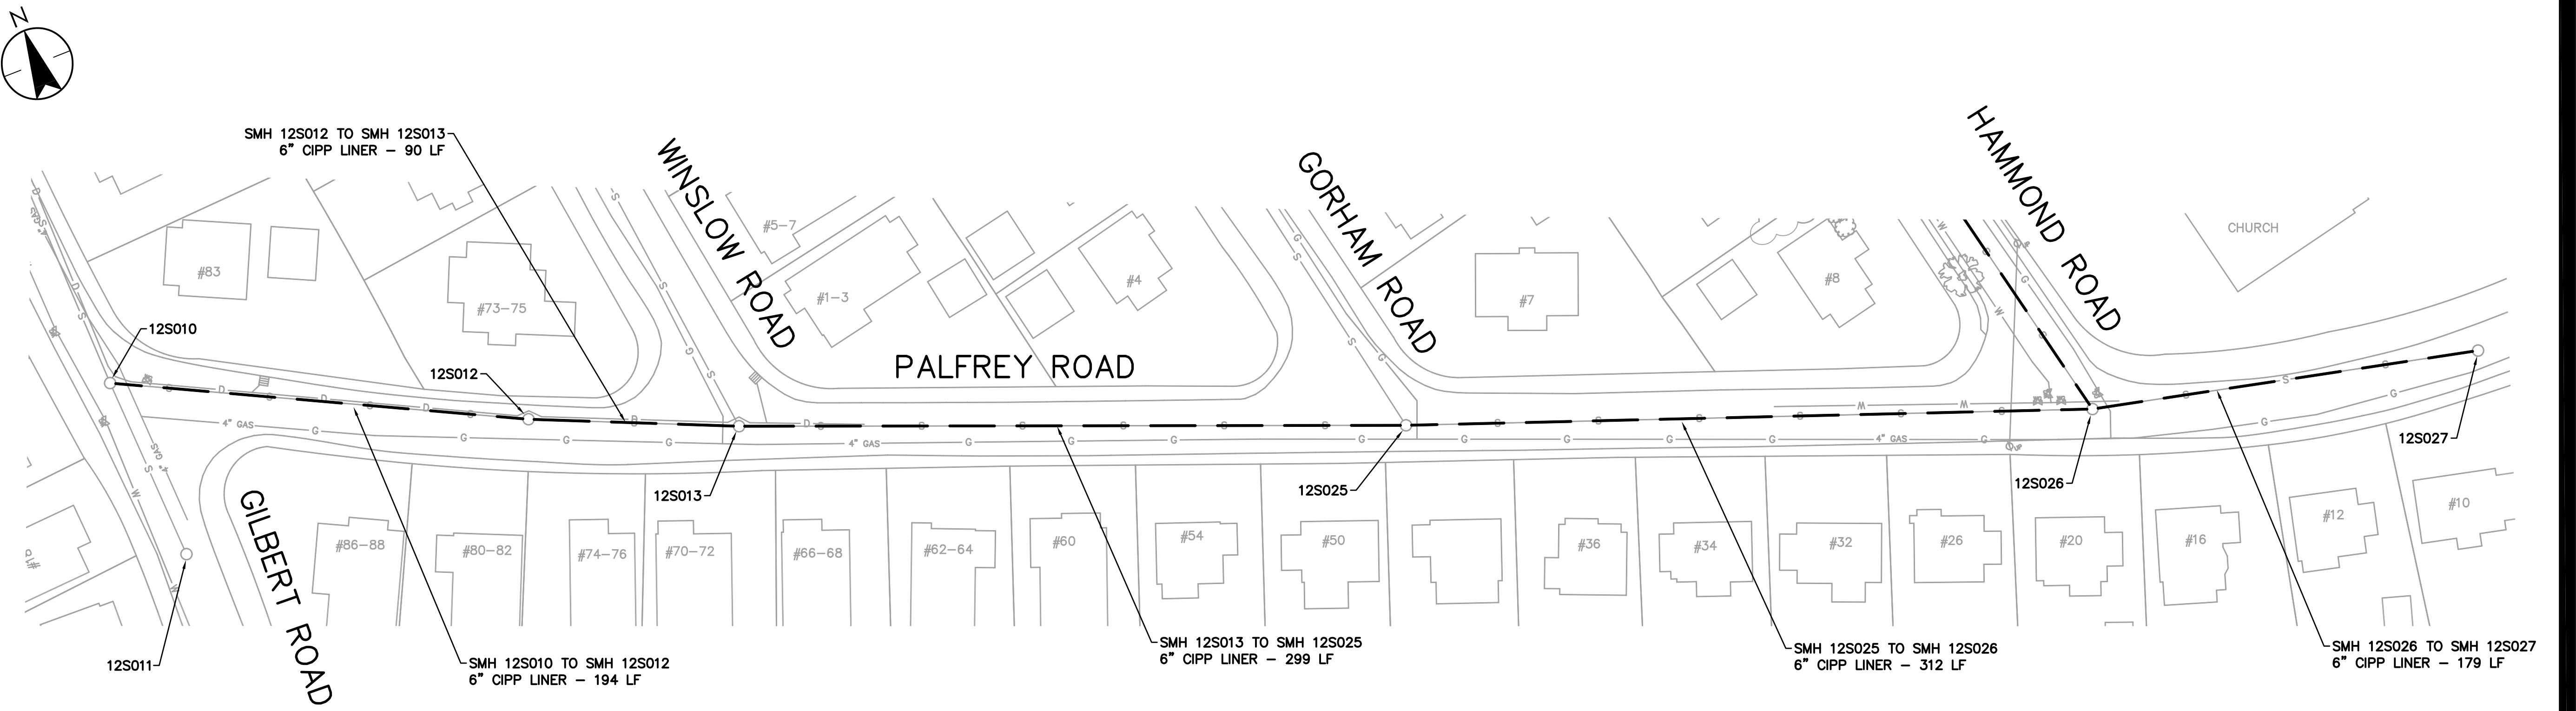
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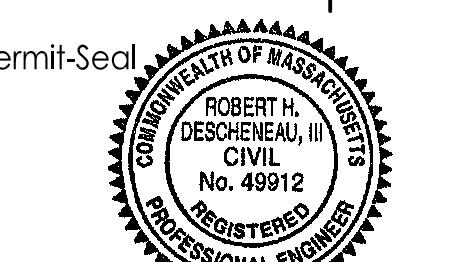
TOWN OF BELMONT, MASSACHUSETTS  
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SEWER SYSTEM REHABILITATION  
MWRA PROJECT NO. WRA-P11-04-3-1124 &  
MWRA PROJECT NO. WRA-P-11-04-3-1160



Project Number:		195113362	
File Name:			
AMD Dwn.	RHD Chkd.	RPB Dsgn.	21.03.31 YY.MM.DD
Drawing No.		C-102	
Revision	Sheet		
0	6 of		

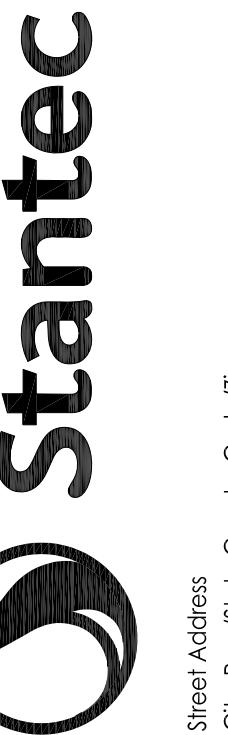

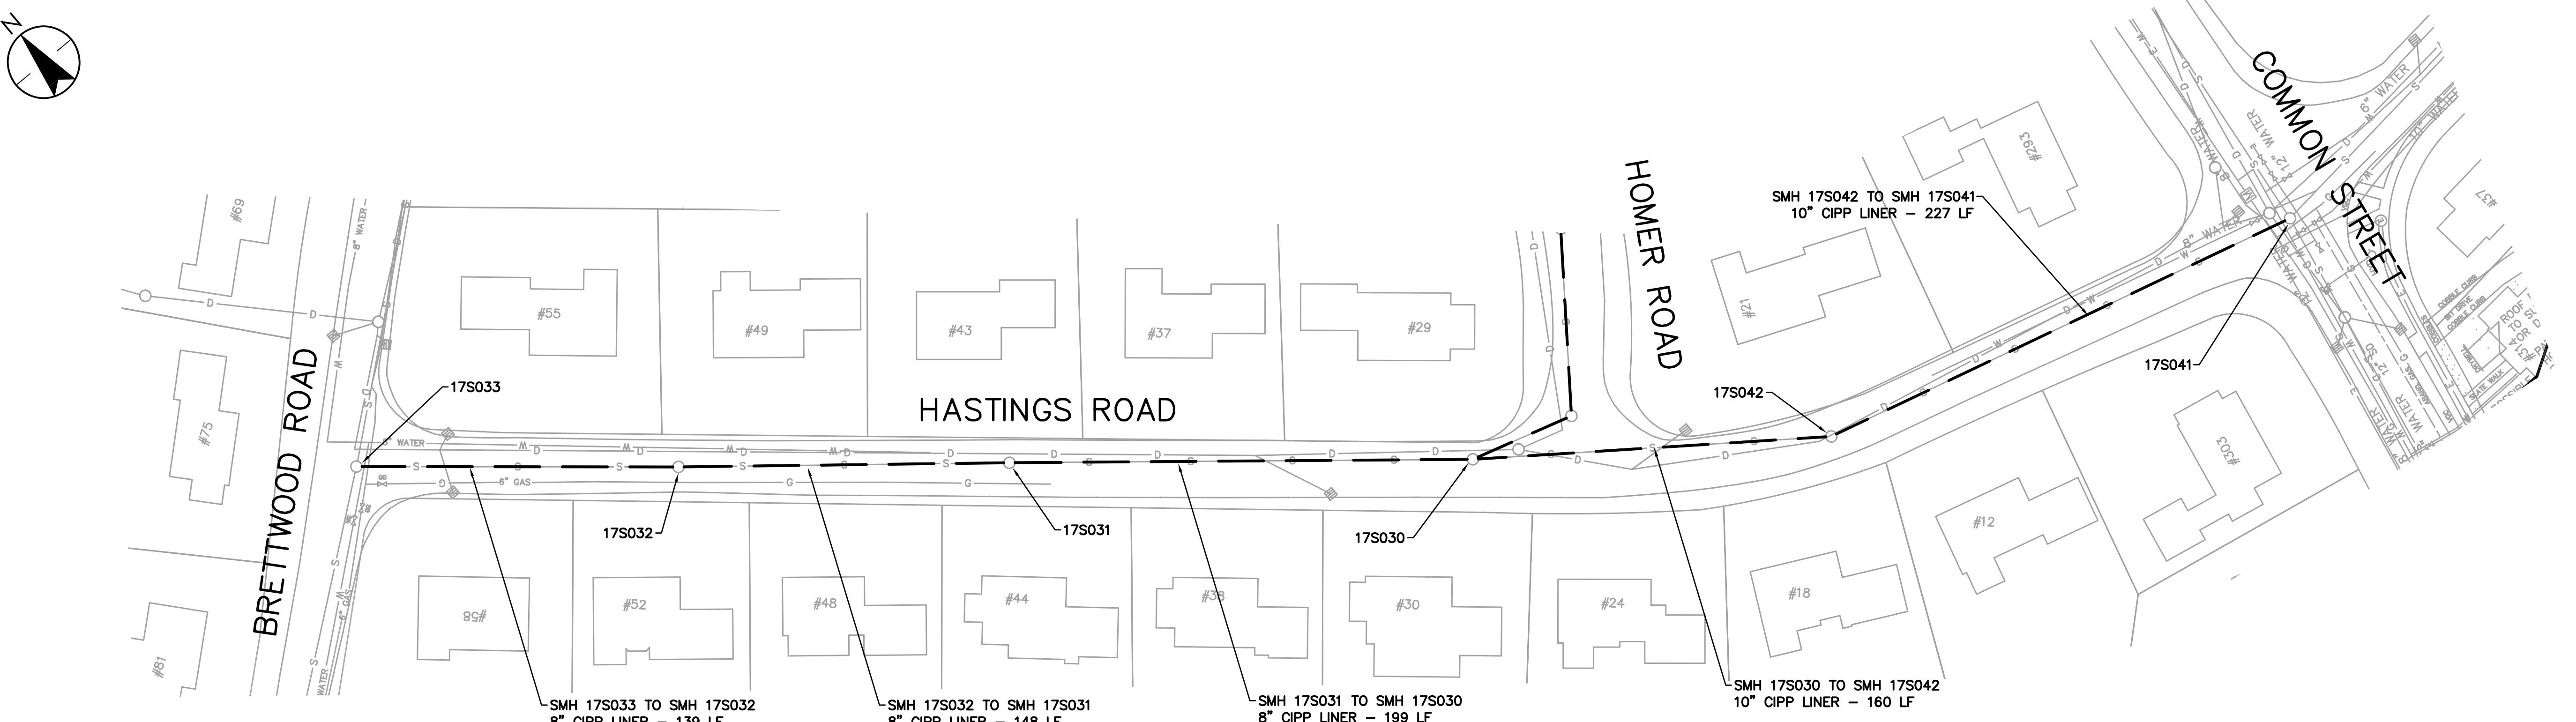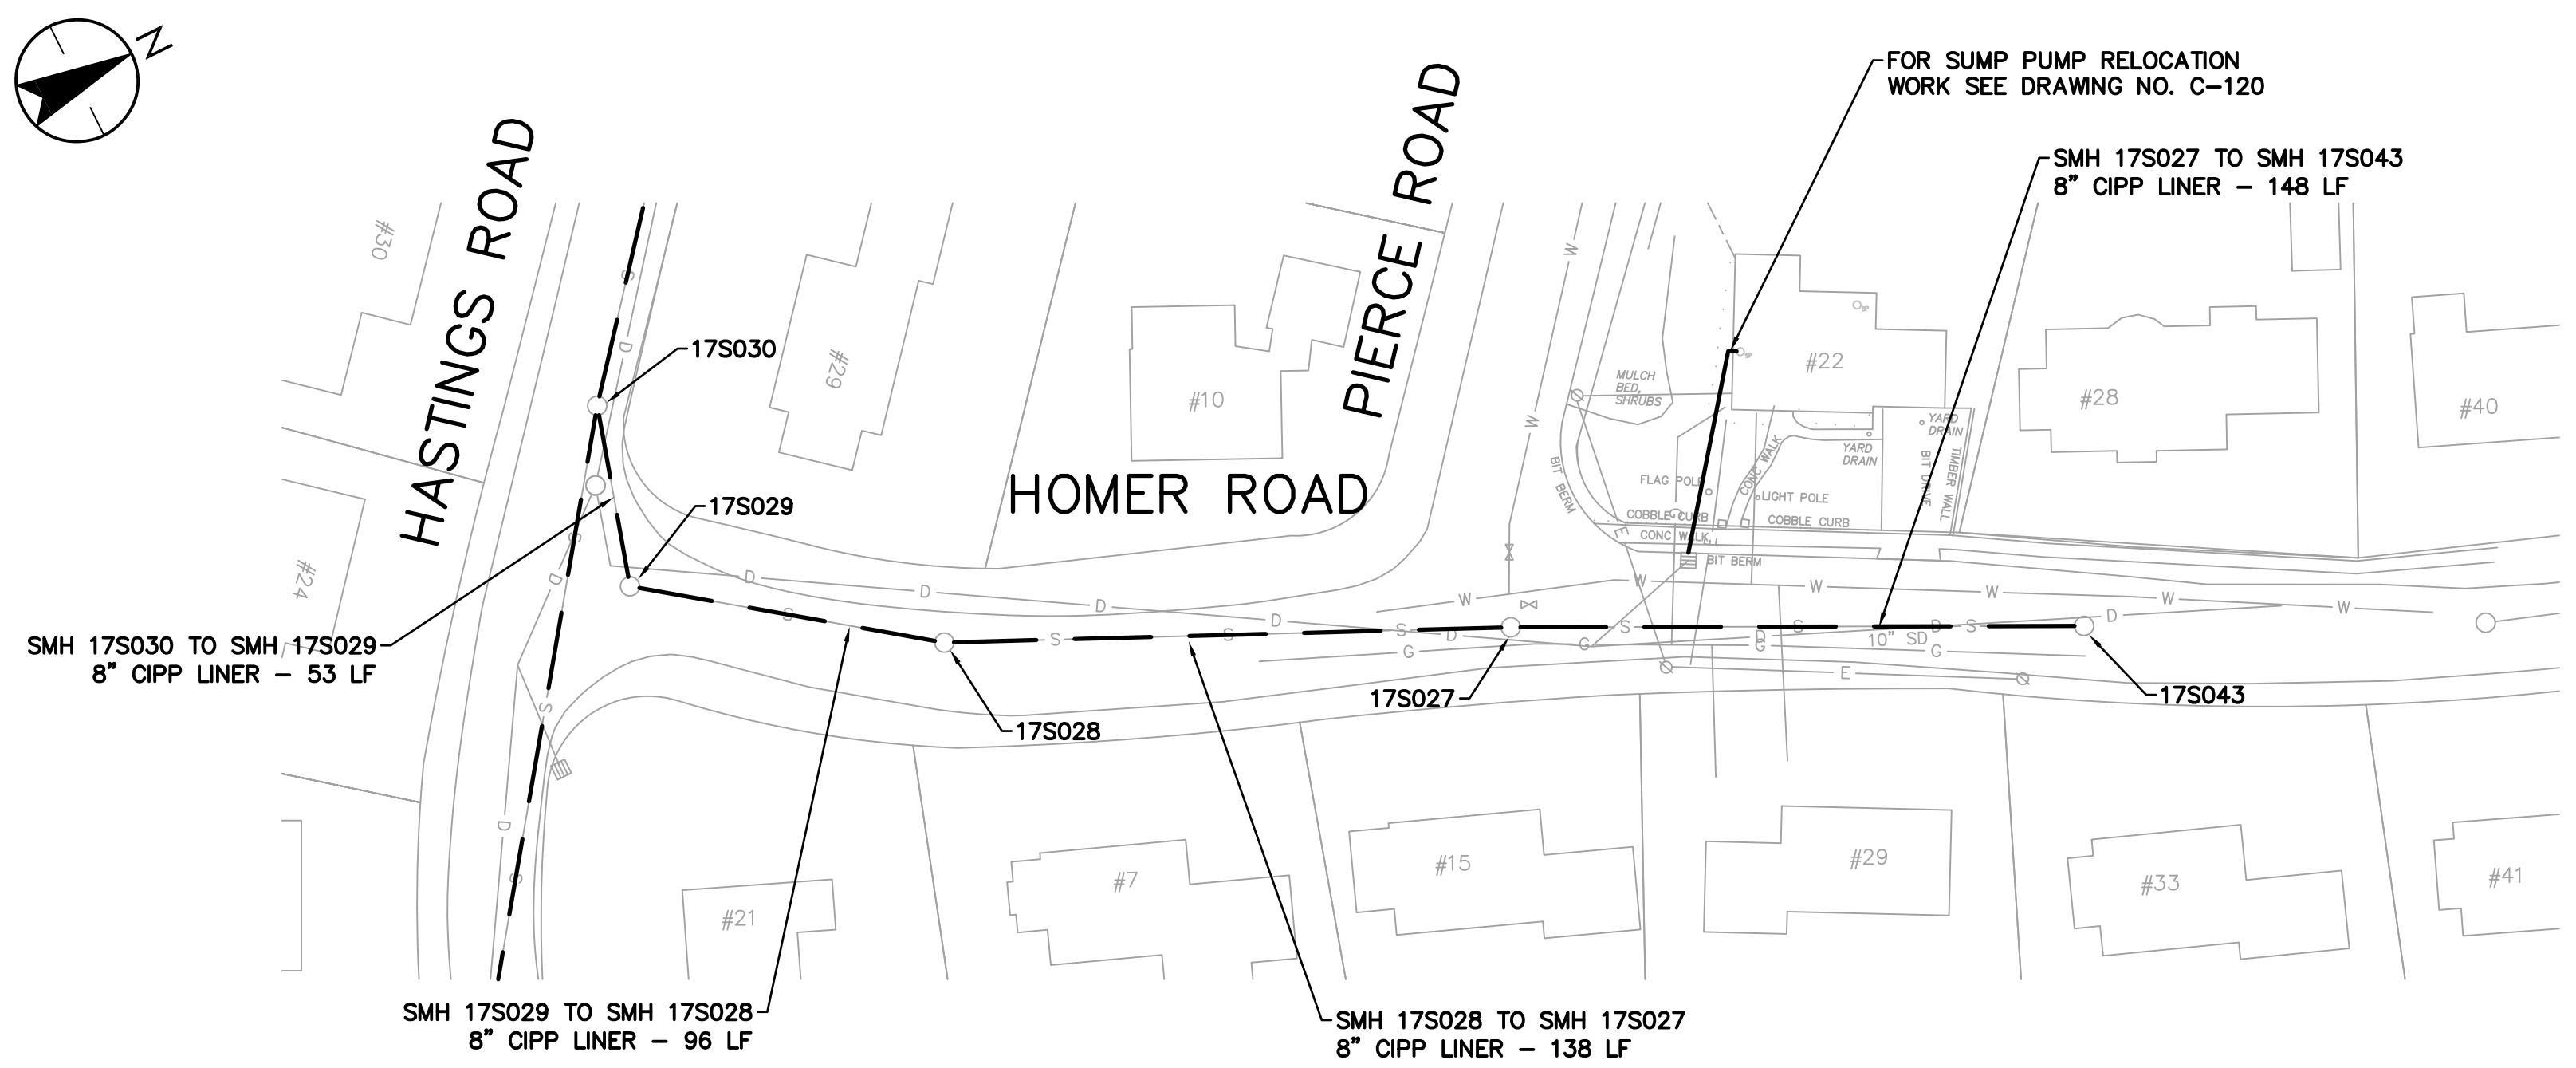TOWN OF BELMONT, MASSACHUSETTS  
PRIVATE SECTOR SUMP PUMP REMOVAL &  
SEWER SYSTEM REHABILITATION  
MWRA PROJECT NO. WRA-P11-04-3-1124 &  
MWRA PROJECT NO. WRA-P11-04-3-1160  
BELMONT, MASSACHUSETTS  
PALFREY ROAD, GARDEN STREET AND VAN NESS ROAD



Project Number: 195113362

File Name:

AMD RHD RPB 21.03.31  
Dwn. Chkd. Disp. YY.MM.DD


Drawing No. C-103

Revision Sheet

0 7 of

By _____	Appd. _____	YY/MM/DD _____
By _____	Appd. _____	YY/MM/DD _____
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By _____	Appd. _____	YY/MM/DD _____
By _____	Appd. _____	YY/MM/DD _____
By _____	Appd. _____	YY/MM/DD _____
By _____	Appd. _____	YY/MM/DD _____
By _____	Appd. _____	YY/MM/DD _____

TOWN OF BELMONT, MASSACHUSETTS  
PRIVATE SECTOR SUMP PUMP REMOVAL &  
SEWER SYSTEM REHABILITATION  
MWRA PROJECT NO. WRA-P11-04-3-1124 &  
MWRA PROJECT NO. WRA-P11-04-3-1160  
BELMONT, MASSACHUSETTS  
LEONARD STREET

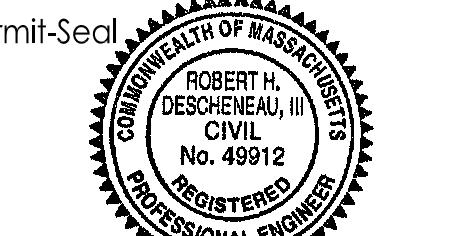

ROBERT H.  
DESCHENEAU, III  
CIVIL  
No. 49912

3-29-2021

Project Number: 195113362

File Name:



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Dwn. Chkd. Disp. YY/MM/DD


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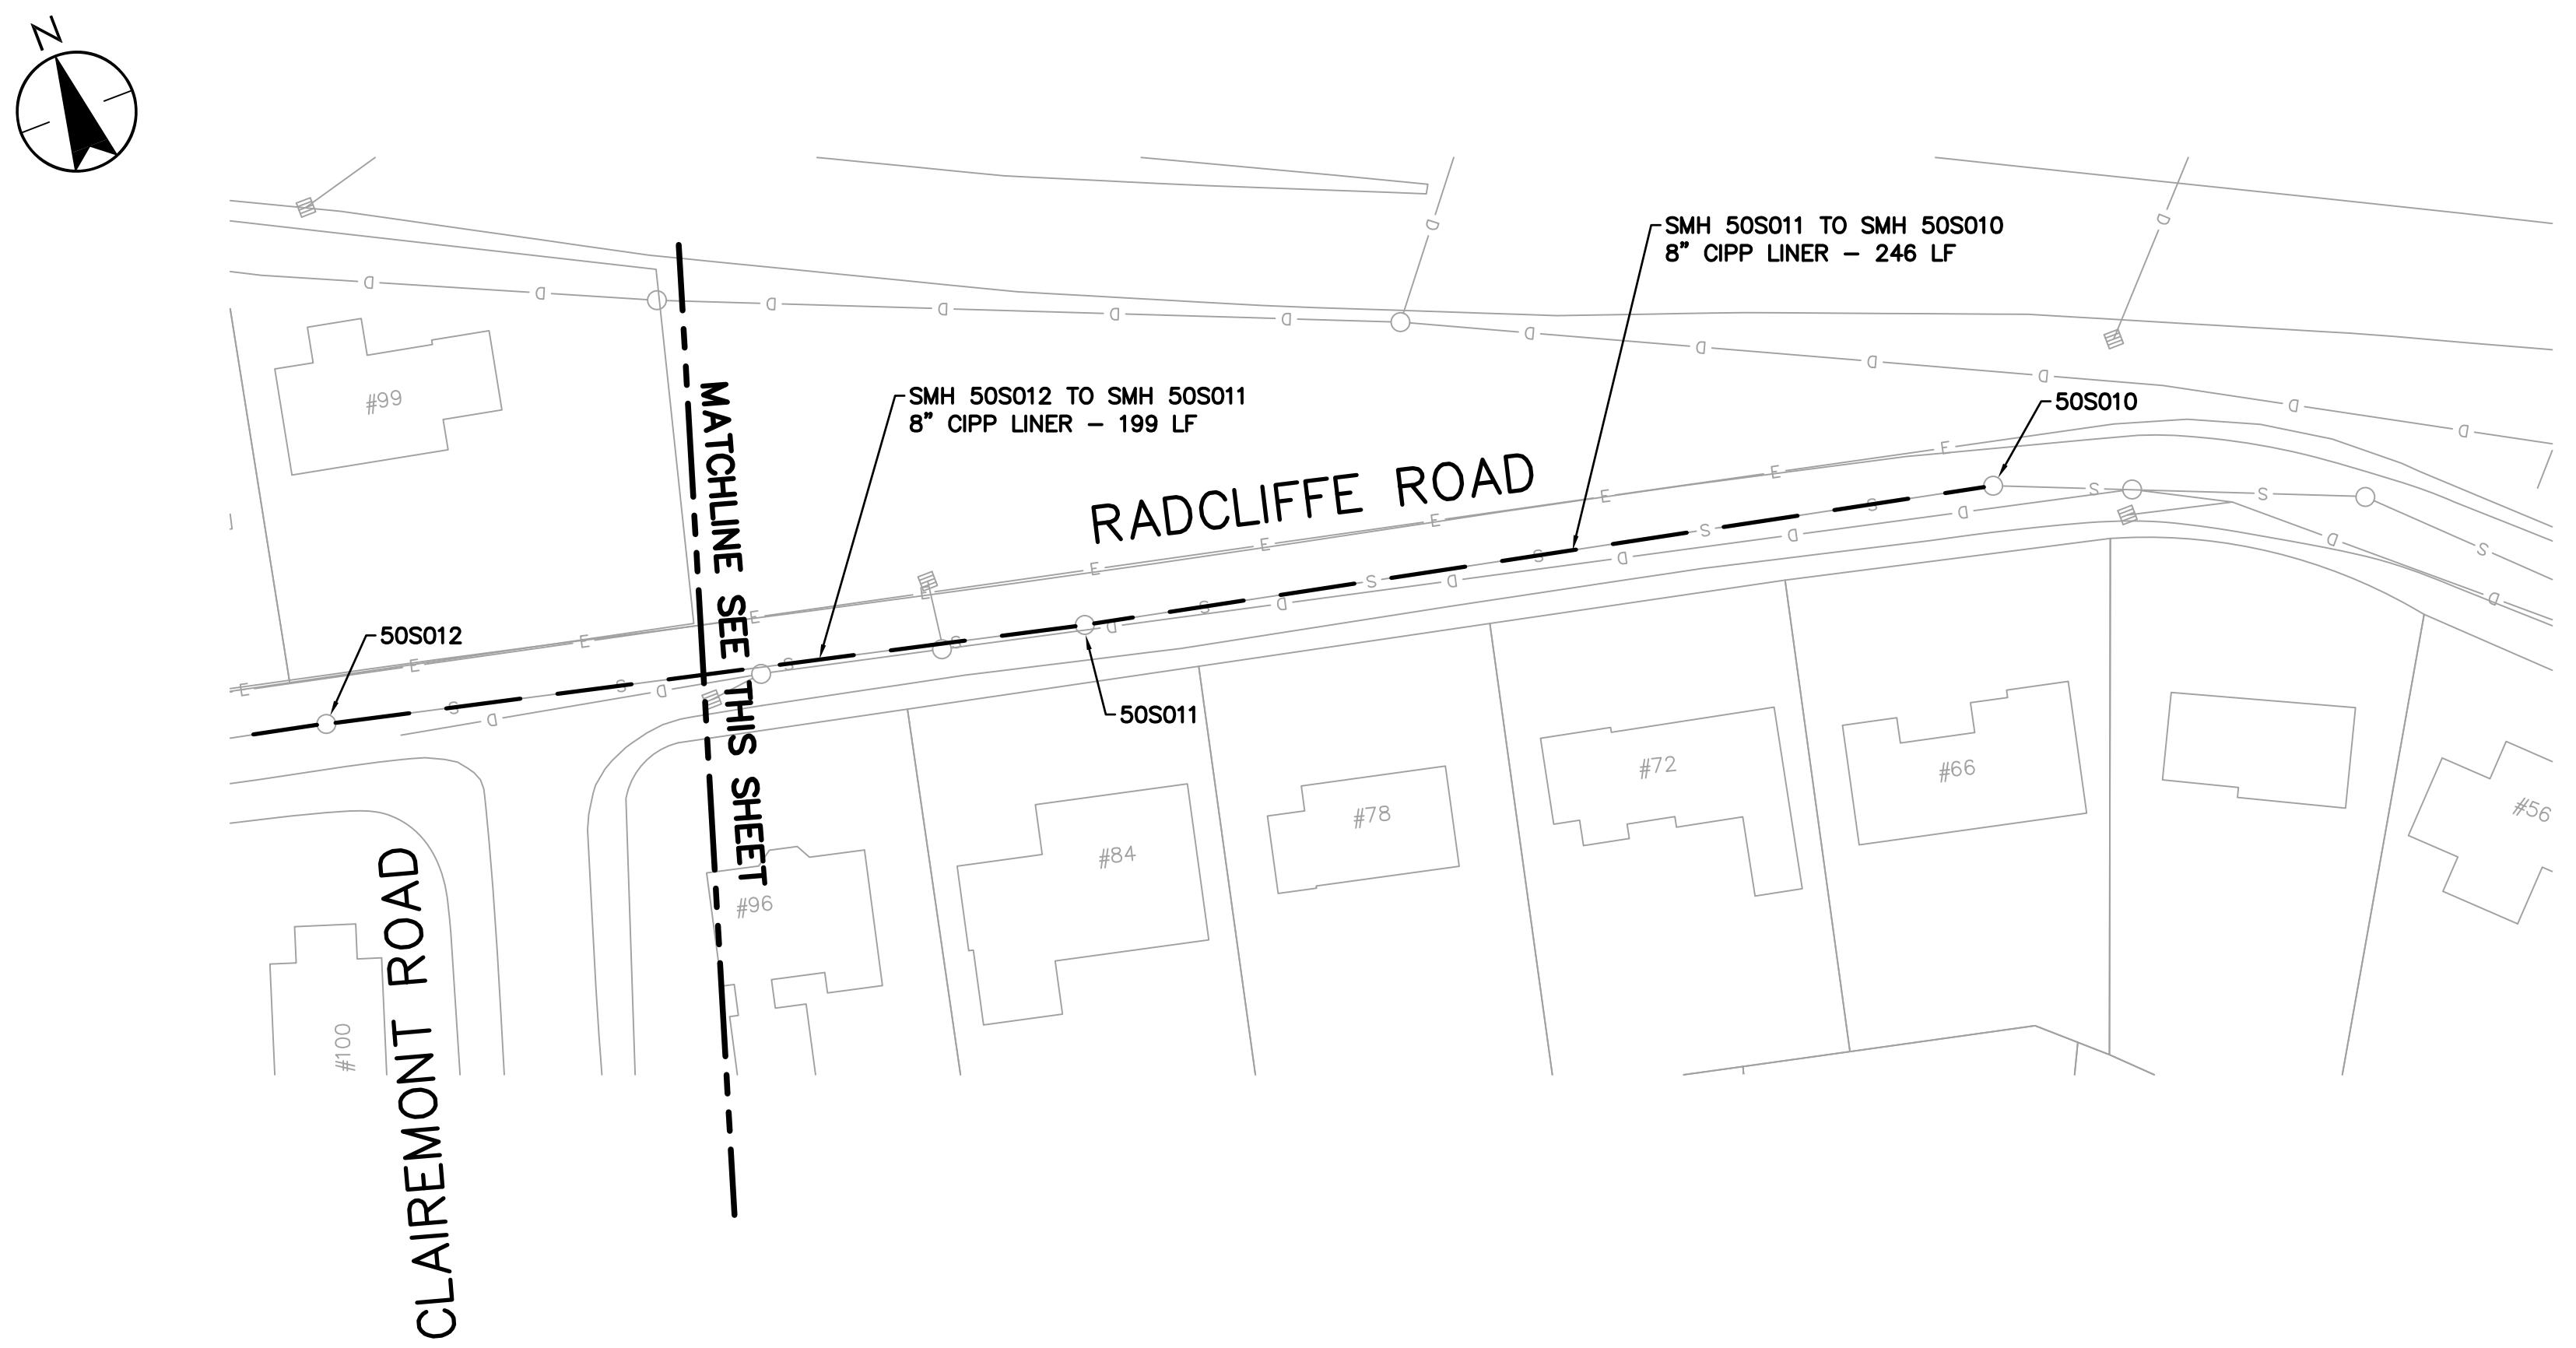
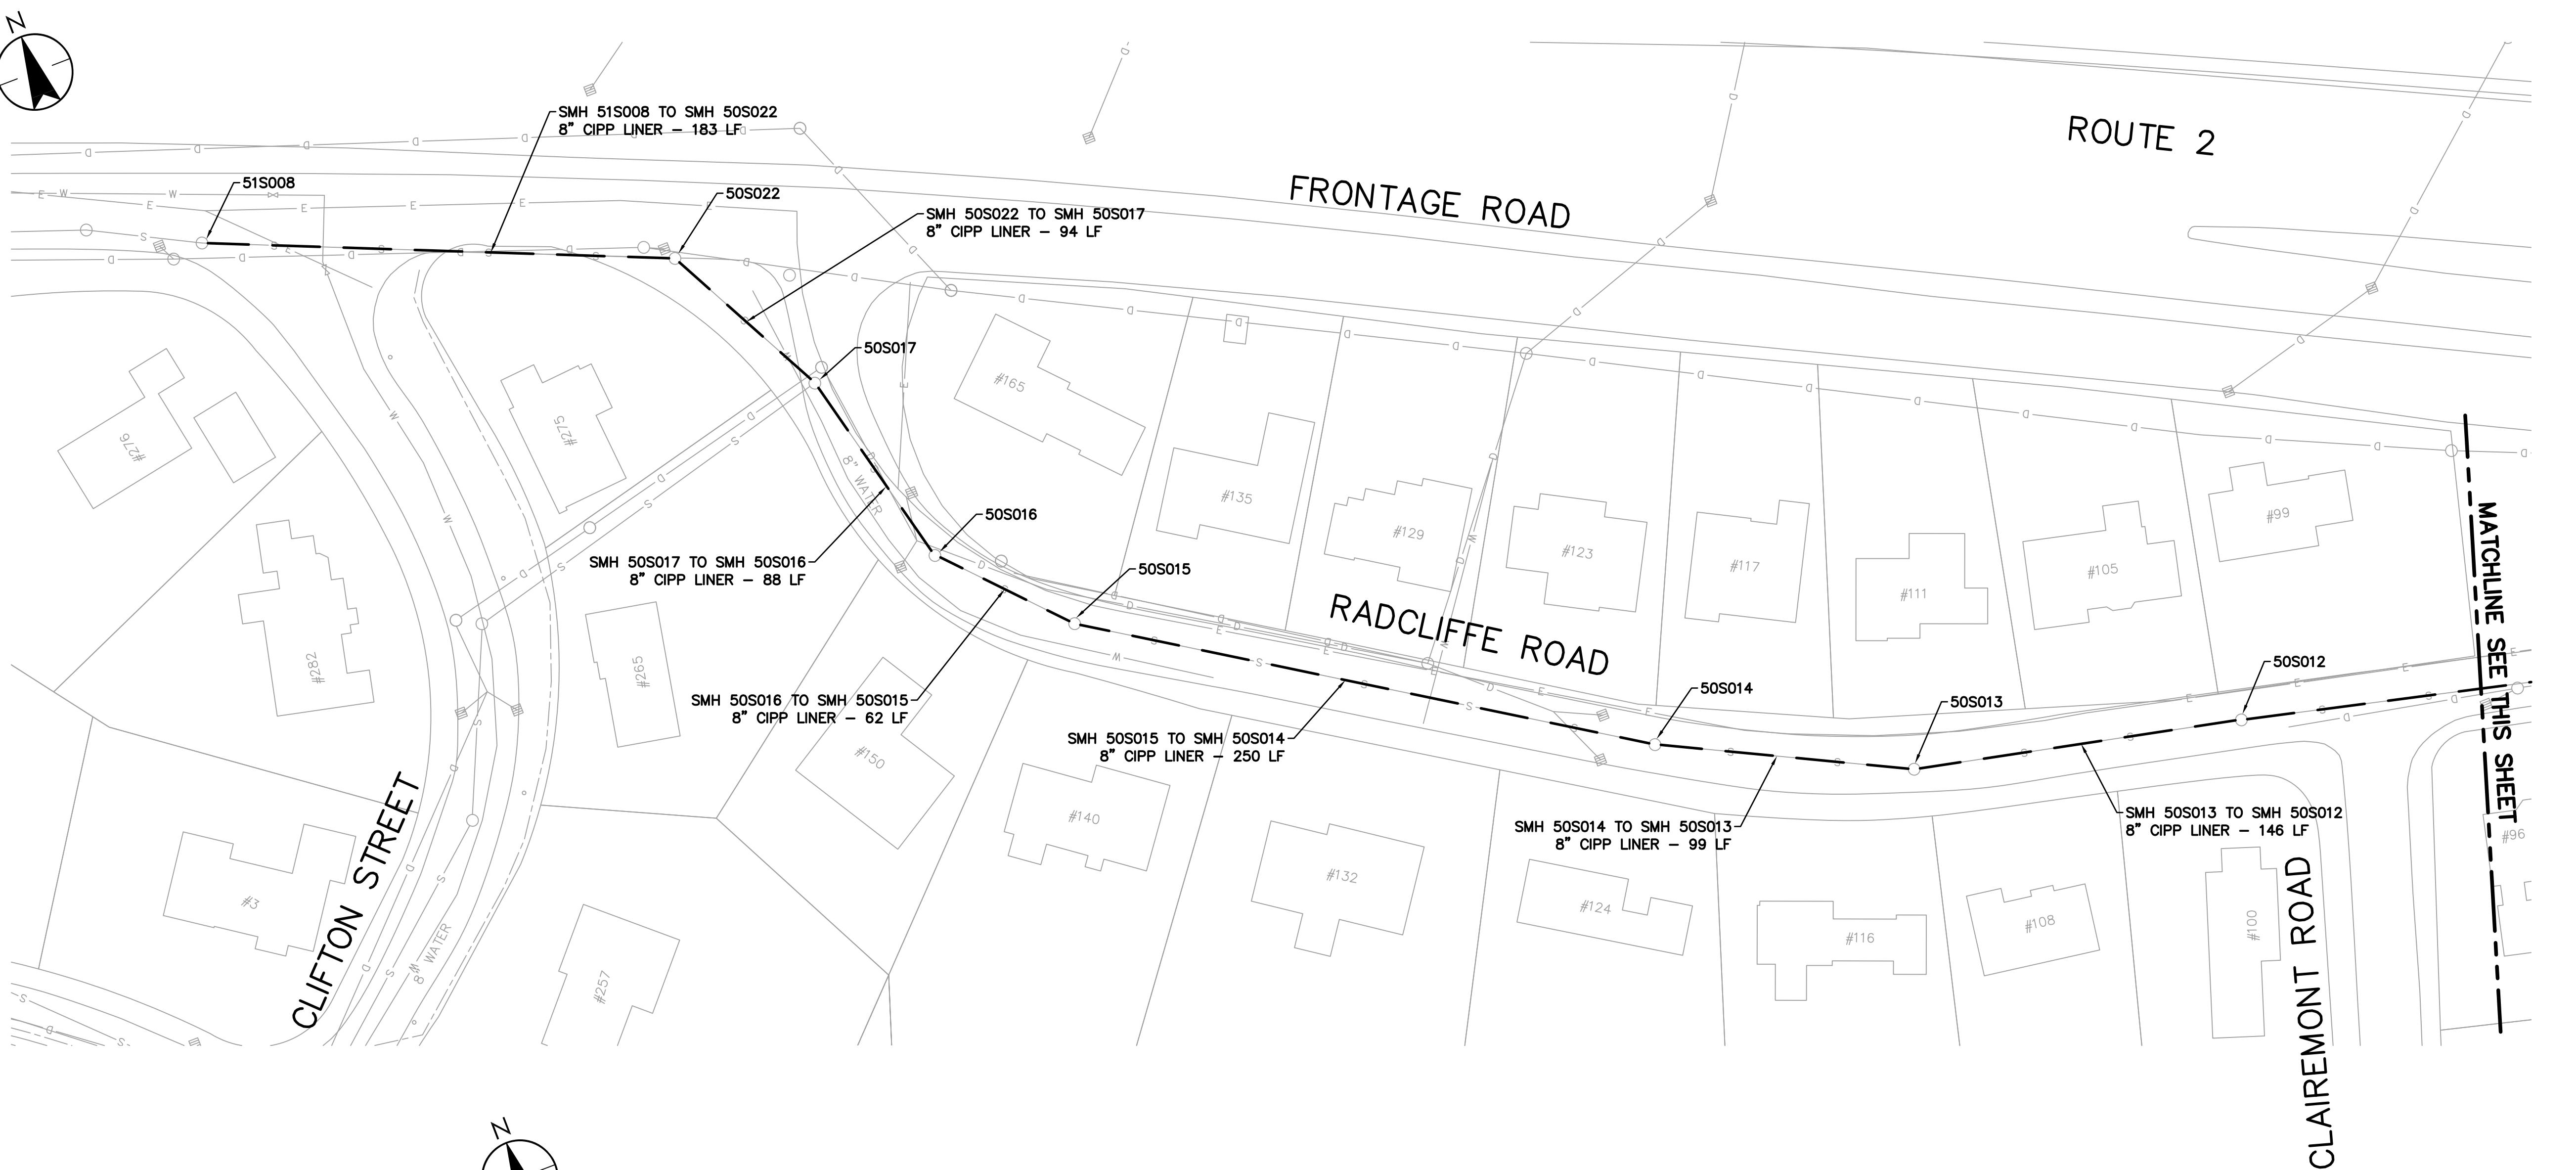
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0 8 of








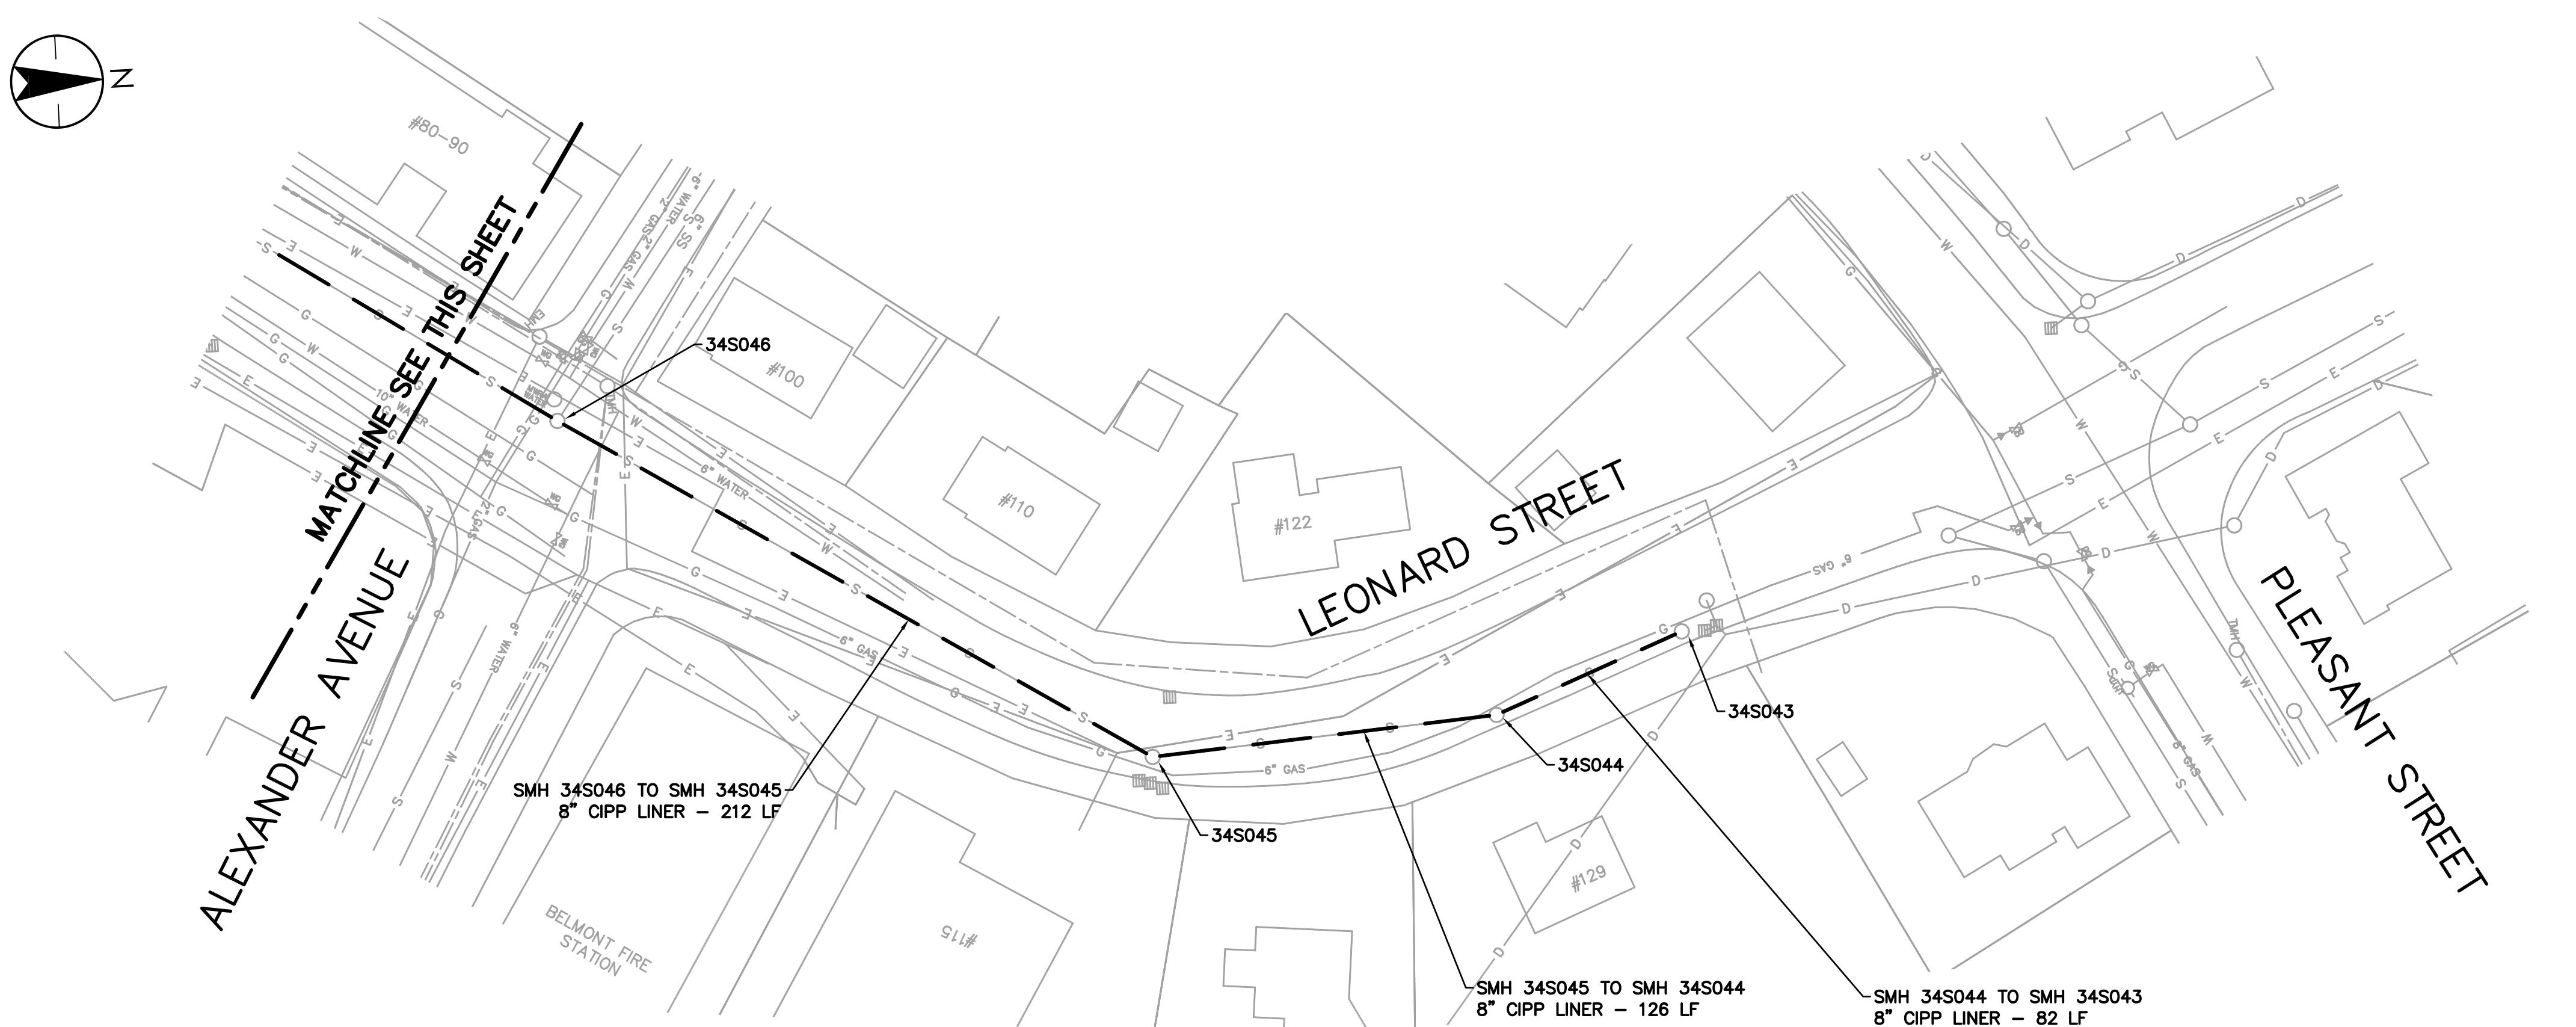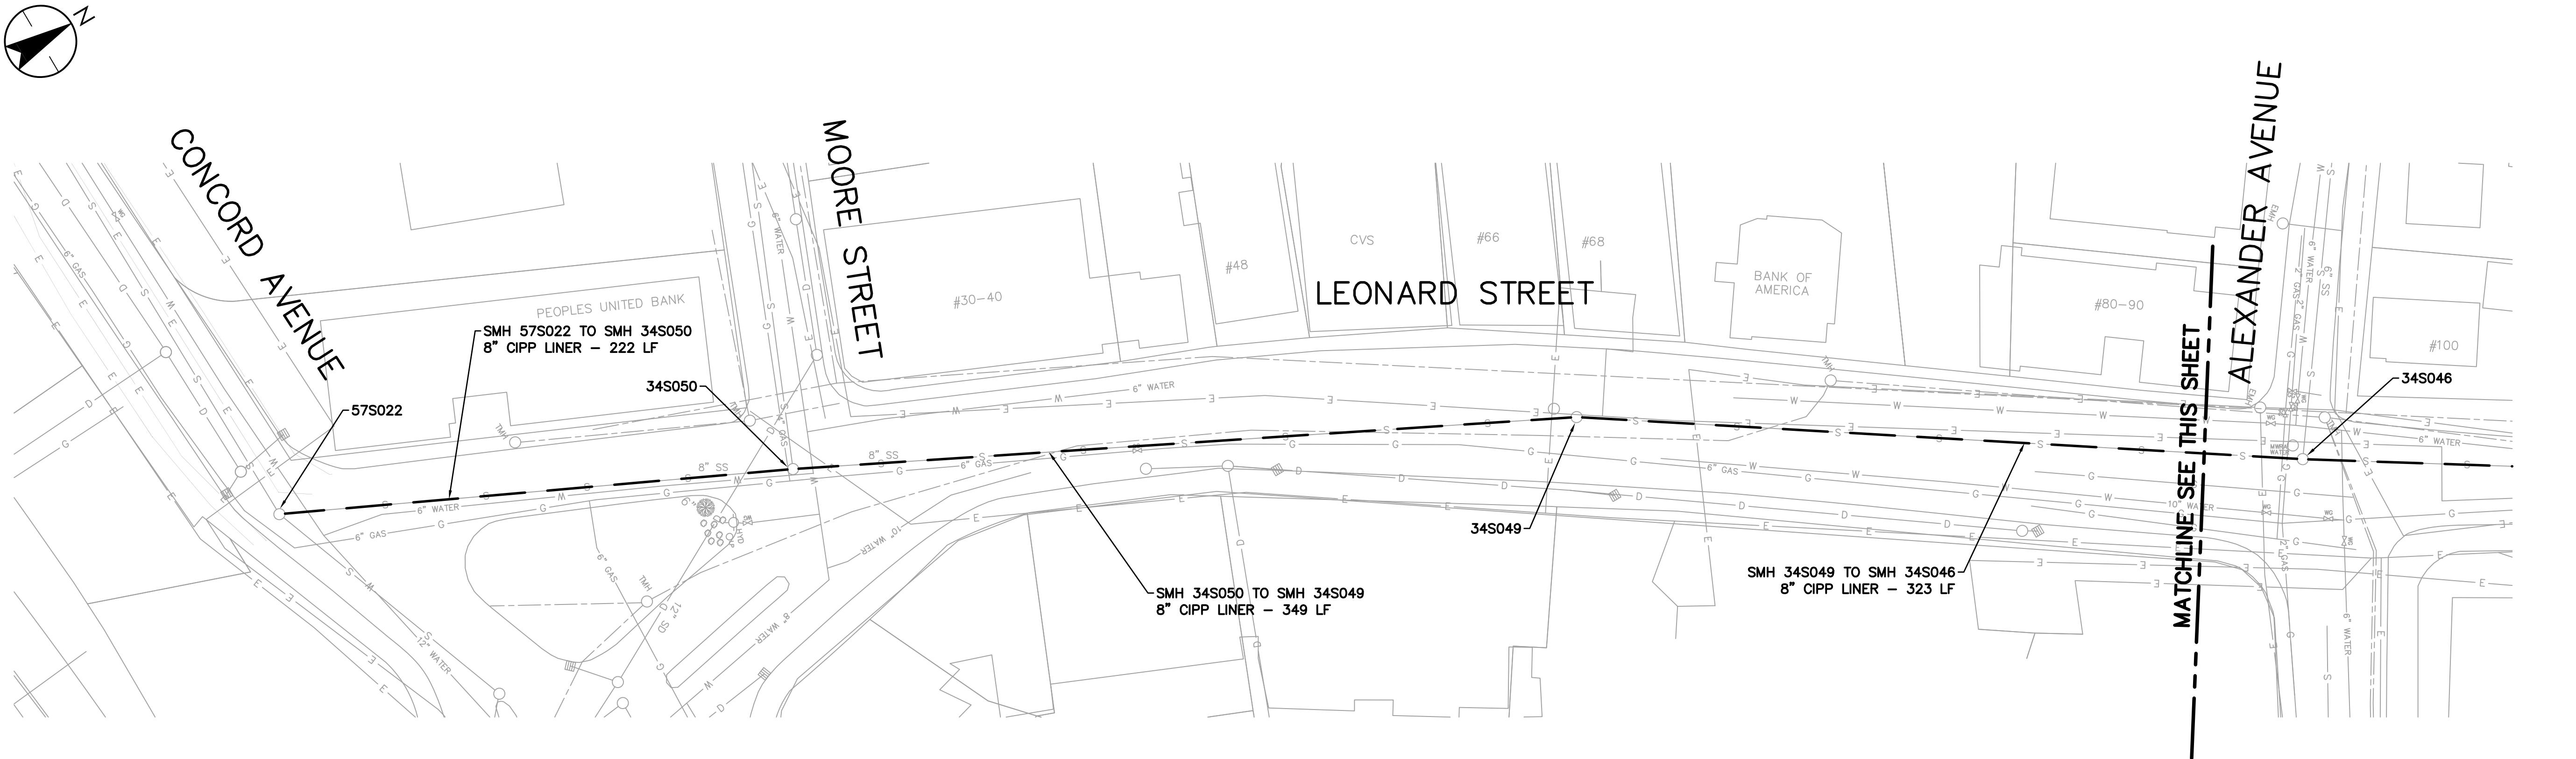

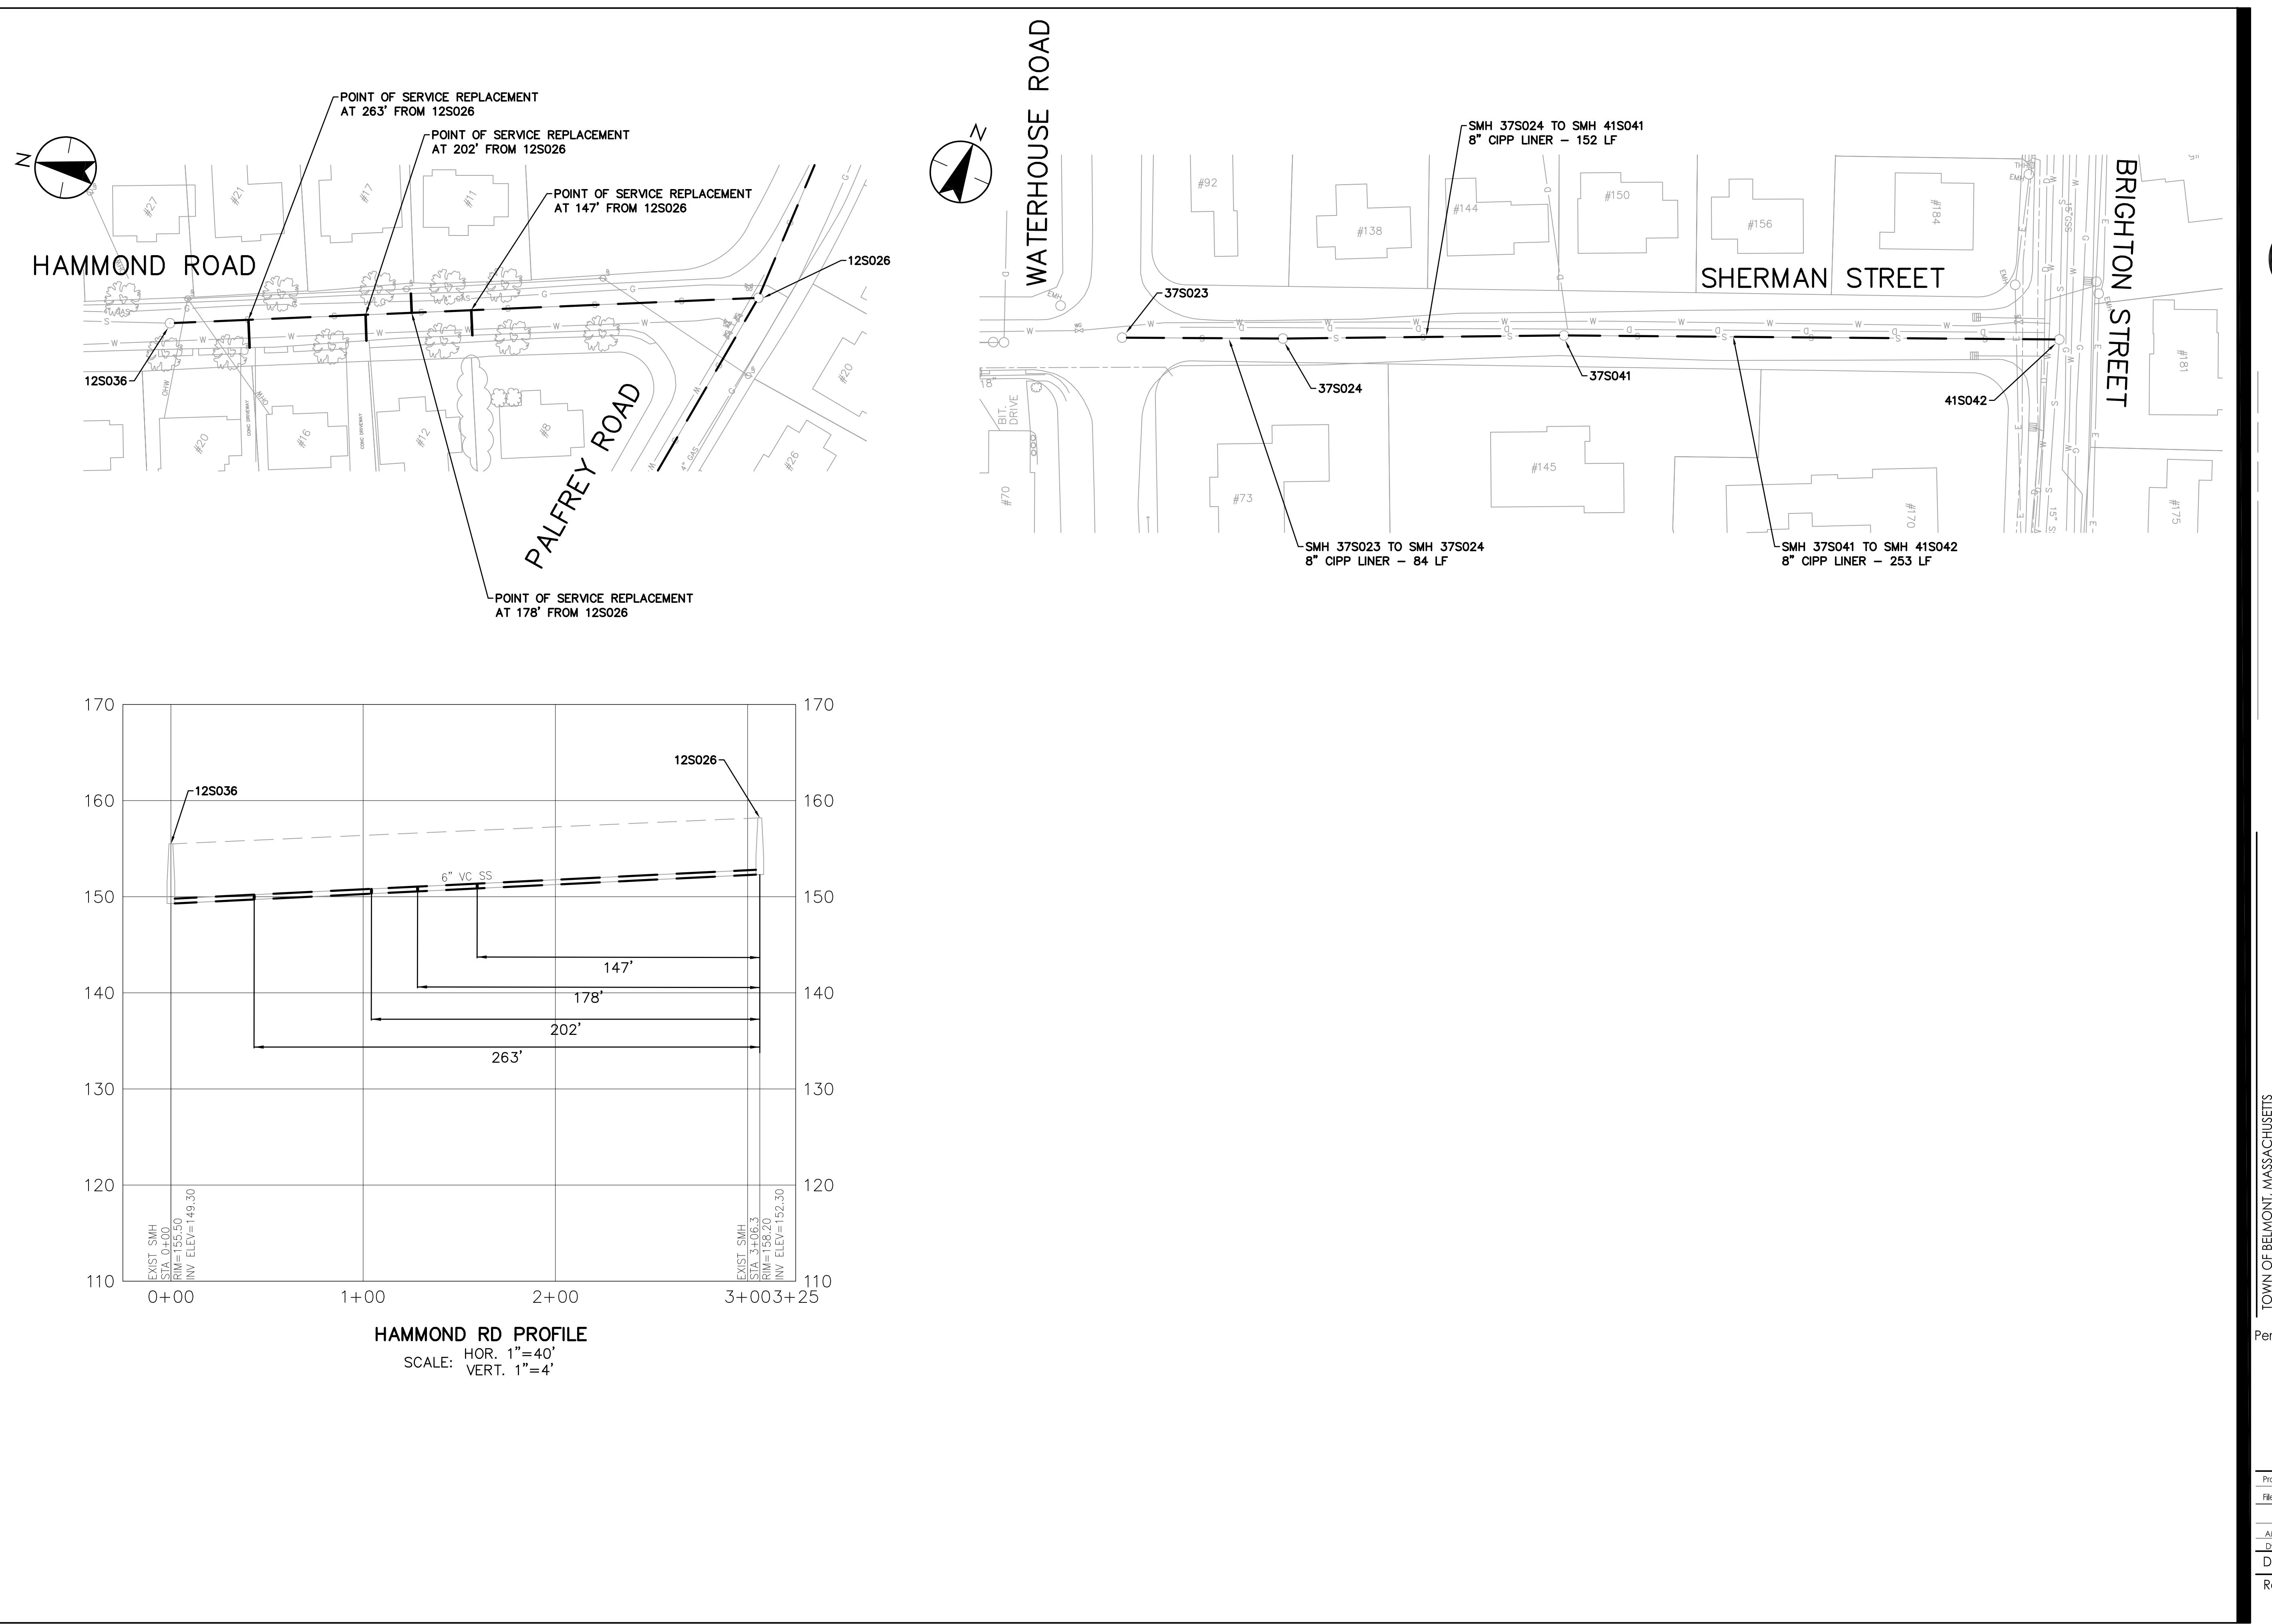TOWN OF BELMONT, MASSACHUSETTS  
 PRIVATE SECTOR SUMP PUMP REMOVAL &  
 SEWER SYSTEM REHABILITATION  
 MWRA PROJECT NO. WRA-P11-04-3-1124 &  
 MWRA PROJECT NO. WRA-P11-04-3-1160  
 BELMONT, MASSACHUSETTS  
 RADCLIFFE ROAD

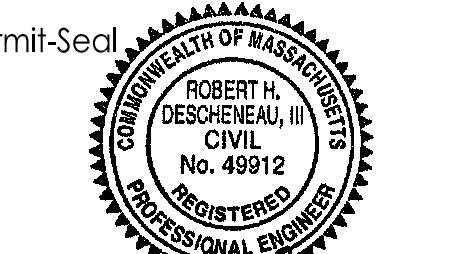


Project Number: 195113362  
 File Name:

AMD RHD RPB 21.03.31  
 Dwn. Chkd. Disp. YY.MM.DD

Drawing No. C-107

Revision Sheet

0 11 of

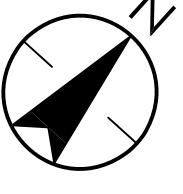

MH 41S046  
 195 LF

**SMH 41S046 TO SMH 41S047**  
**8" CIPP LINER – 321 LF**

**CROSS STREET**

**41S046**

**41S047**

STAUN

#272 #278 #280 #286 #290 #296 #302  
 #277 #281 #285 #289 #293 #297 #303

SMH 41S047 TO SMH 41S009  
8" CIPP LINER - 363 LF

#310      #314      #318      #322      #332      #344

EY ROAD

41S009

LODGE ROAD

LITTLE POND ROAD

FOR SUMP PUMP RELOCATION  
WORK SEE DRAWING NO. C-119

**MATCHLINE SEE THIS SHEET**



This map illustrates a residential area with several streets and property boundaries. Key features include:

- ALBERT AVENUE**: A street running diagonally from the top left towards the center.
- LAKE STREET**: A street running vertically on the right side.
- CROSS STREET**: A horizontal street connecting ALBERT AVENUE and LAKE STREET.
- GILMORE ROAD**: A street running horizontally at the bottom of the map.
- TOBEY ROAD**: A street running vertically on the left side.

Residential properties are marked with house numbers:

- #329 (GILMORE ROAD)
- #332 (TOBEY ROAD)
- #344 (CROSS STREET)
- #334 (CROSS STREET)
- #340 (CROSS STREET)
- #292 (CROSS STREET)
- #300 (LAKE STREET)
- #350 (ALBERT AVENUE)
- #345 (GILMORE ROAD)
- #284 (GILMORE ROAD)

Utility work and pipe segments are labeled with identifiers and descriptions:

- 45S022**: Located on ALBERT AVENUE.
- 41S019**: Located on LAKE STREET.
- 41S018**: Located on GILMORE ROAD.
- SMH 41S019 TO SMH 41S022**: An 8" CIPP LINER - 199 LF.
- SMH 41S009 TO SMH 41S018**: An 8" CIPP LINER - 353 LF.
- SMH 41S018 TO SMH 41S019**: An 8" CIPP LINER - 56 LF.
- 8" POINT REPAIR AT 44'-52 FROM 41S022**: Located on ALBERT AVENUE.

A vertical dashed line on the left side of the map contains the text: **MATCHLINE SEE THIS SHEET**.


The figure is a topographic map with two vertical scales on the left and right sides, ranging from 20 to 60. A horizontal dashed line represents a profile across the map. Two survey stations are marked: 45S022 at the top left and 41S019 at the bottom right. A line connects these stations, passing through several elevation markers. A vertical scale bar is located in the lower-left quadrant. Text labels include:

- 45S022** at the top left station.
- 41S019** at the bottom right station.
- 8" VC SS** near the center of the connecting line.
- 44'-52'** indicating a vertical distance between two points on the line.
- EXIST SMH STA 2+21 RIM=45.8 INV ELEV=39.50** at the bottom left station.
- EXIST SMH STA 0+00 RIM=40.1 INV ELEV=34.91** at the bottom right station.

# LAKE ST PROFILE



SCALE: HOR. 1"=40'  
VERT 1"=4'

TOWN OF BELMONT, MASSACHUSETTS  
PRIVATE SECTOR SUMP PUMP REMOVAL &  
SEWER SYSTEM REHABILITATION  
  
MWRA PROJECT NO. WRA-P11-04-3-1124 &  
MWRA PROJECT NO. WRA-P-11-04-3-1160  
  
BELMONT, MASSACHUSETTS  
  
CROSS STREET AND LAKE STREET

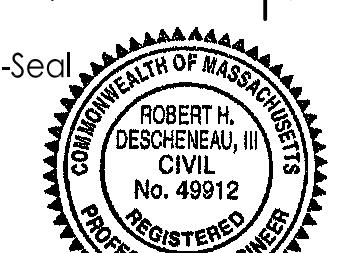

Project Number:		195113362	
File Name:			
AMD	RHD	RPB	21.03.31
Dwn.	Chkd.	Dsgn.	YY.MM.DD
Drawing No.		C-108	
Revision	Sheet		
0	12 of		


V:\1951\active\1951\13362\5\_design\Sump Pump Removal\civil\drawings\civil\LAKE ST.dwg  
2021/03/29 11:23 AM By: DiCecca, Alicia

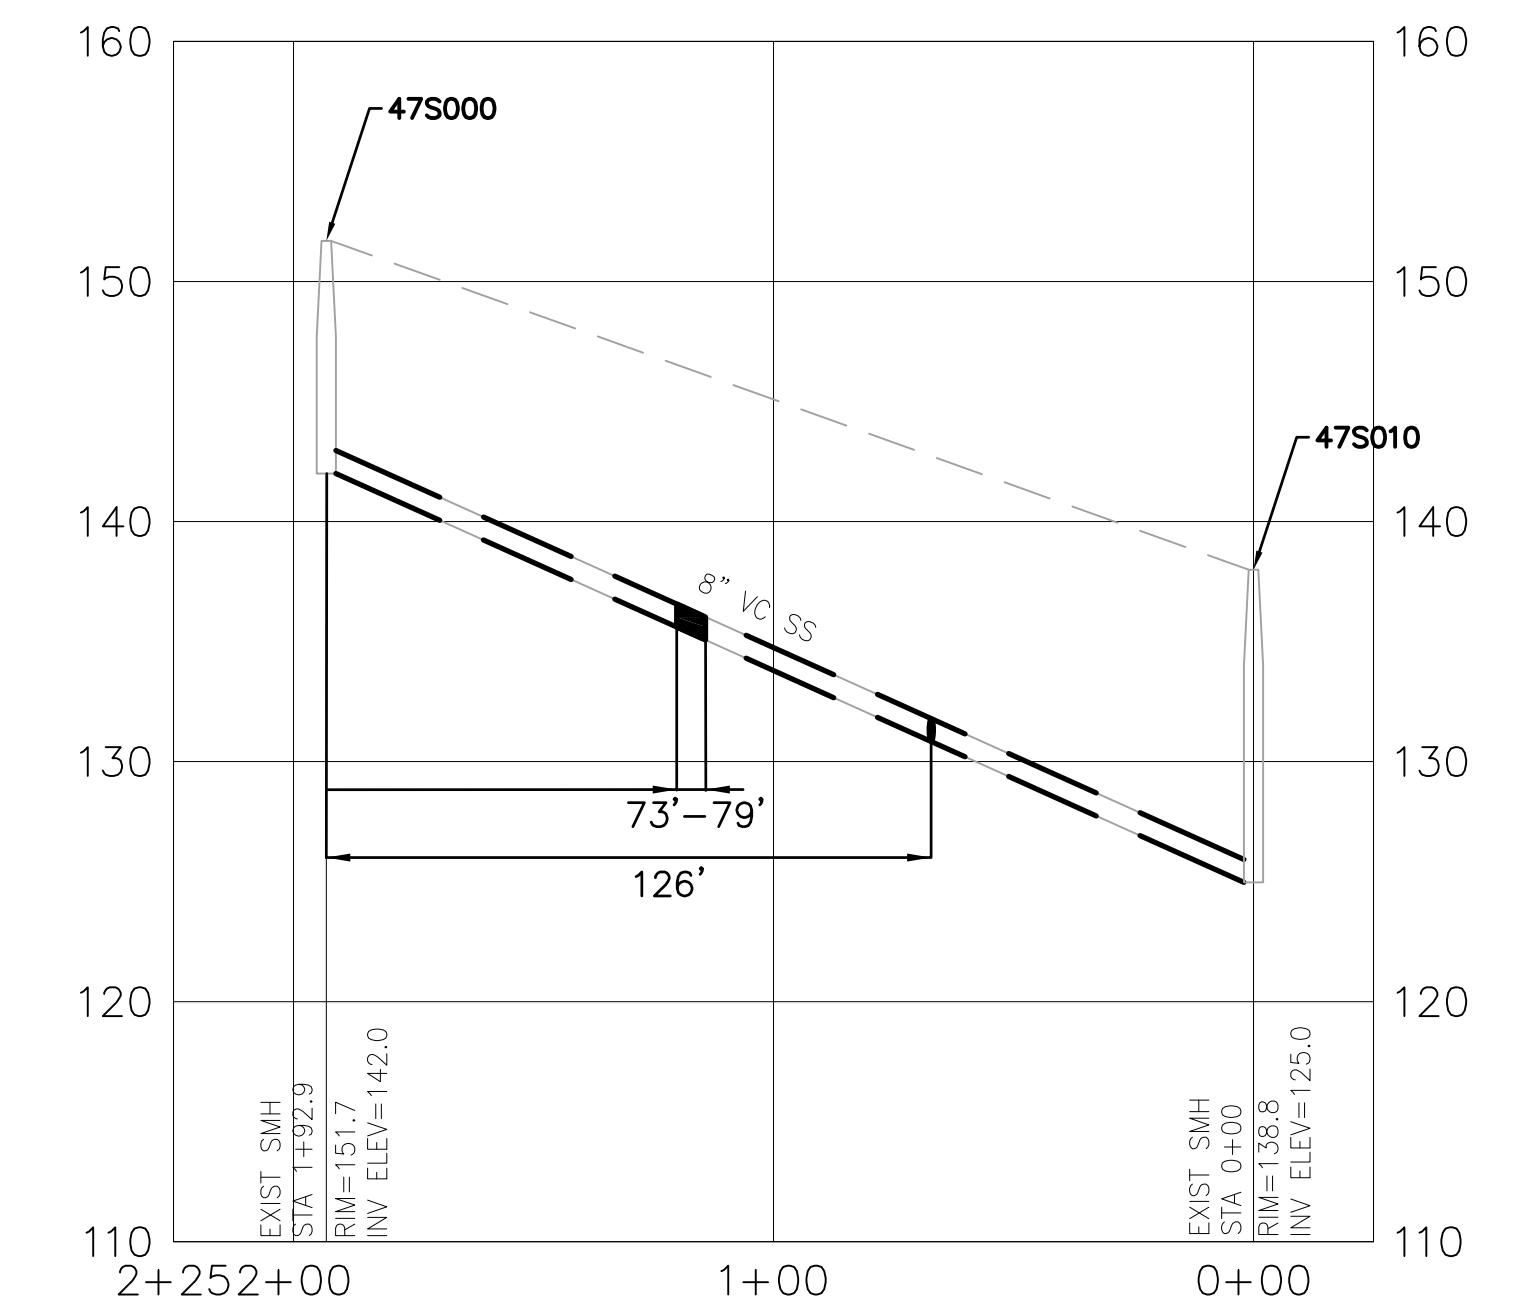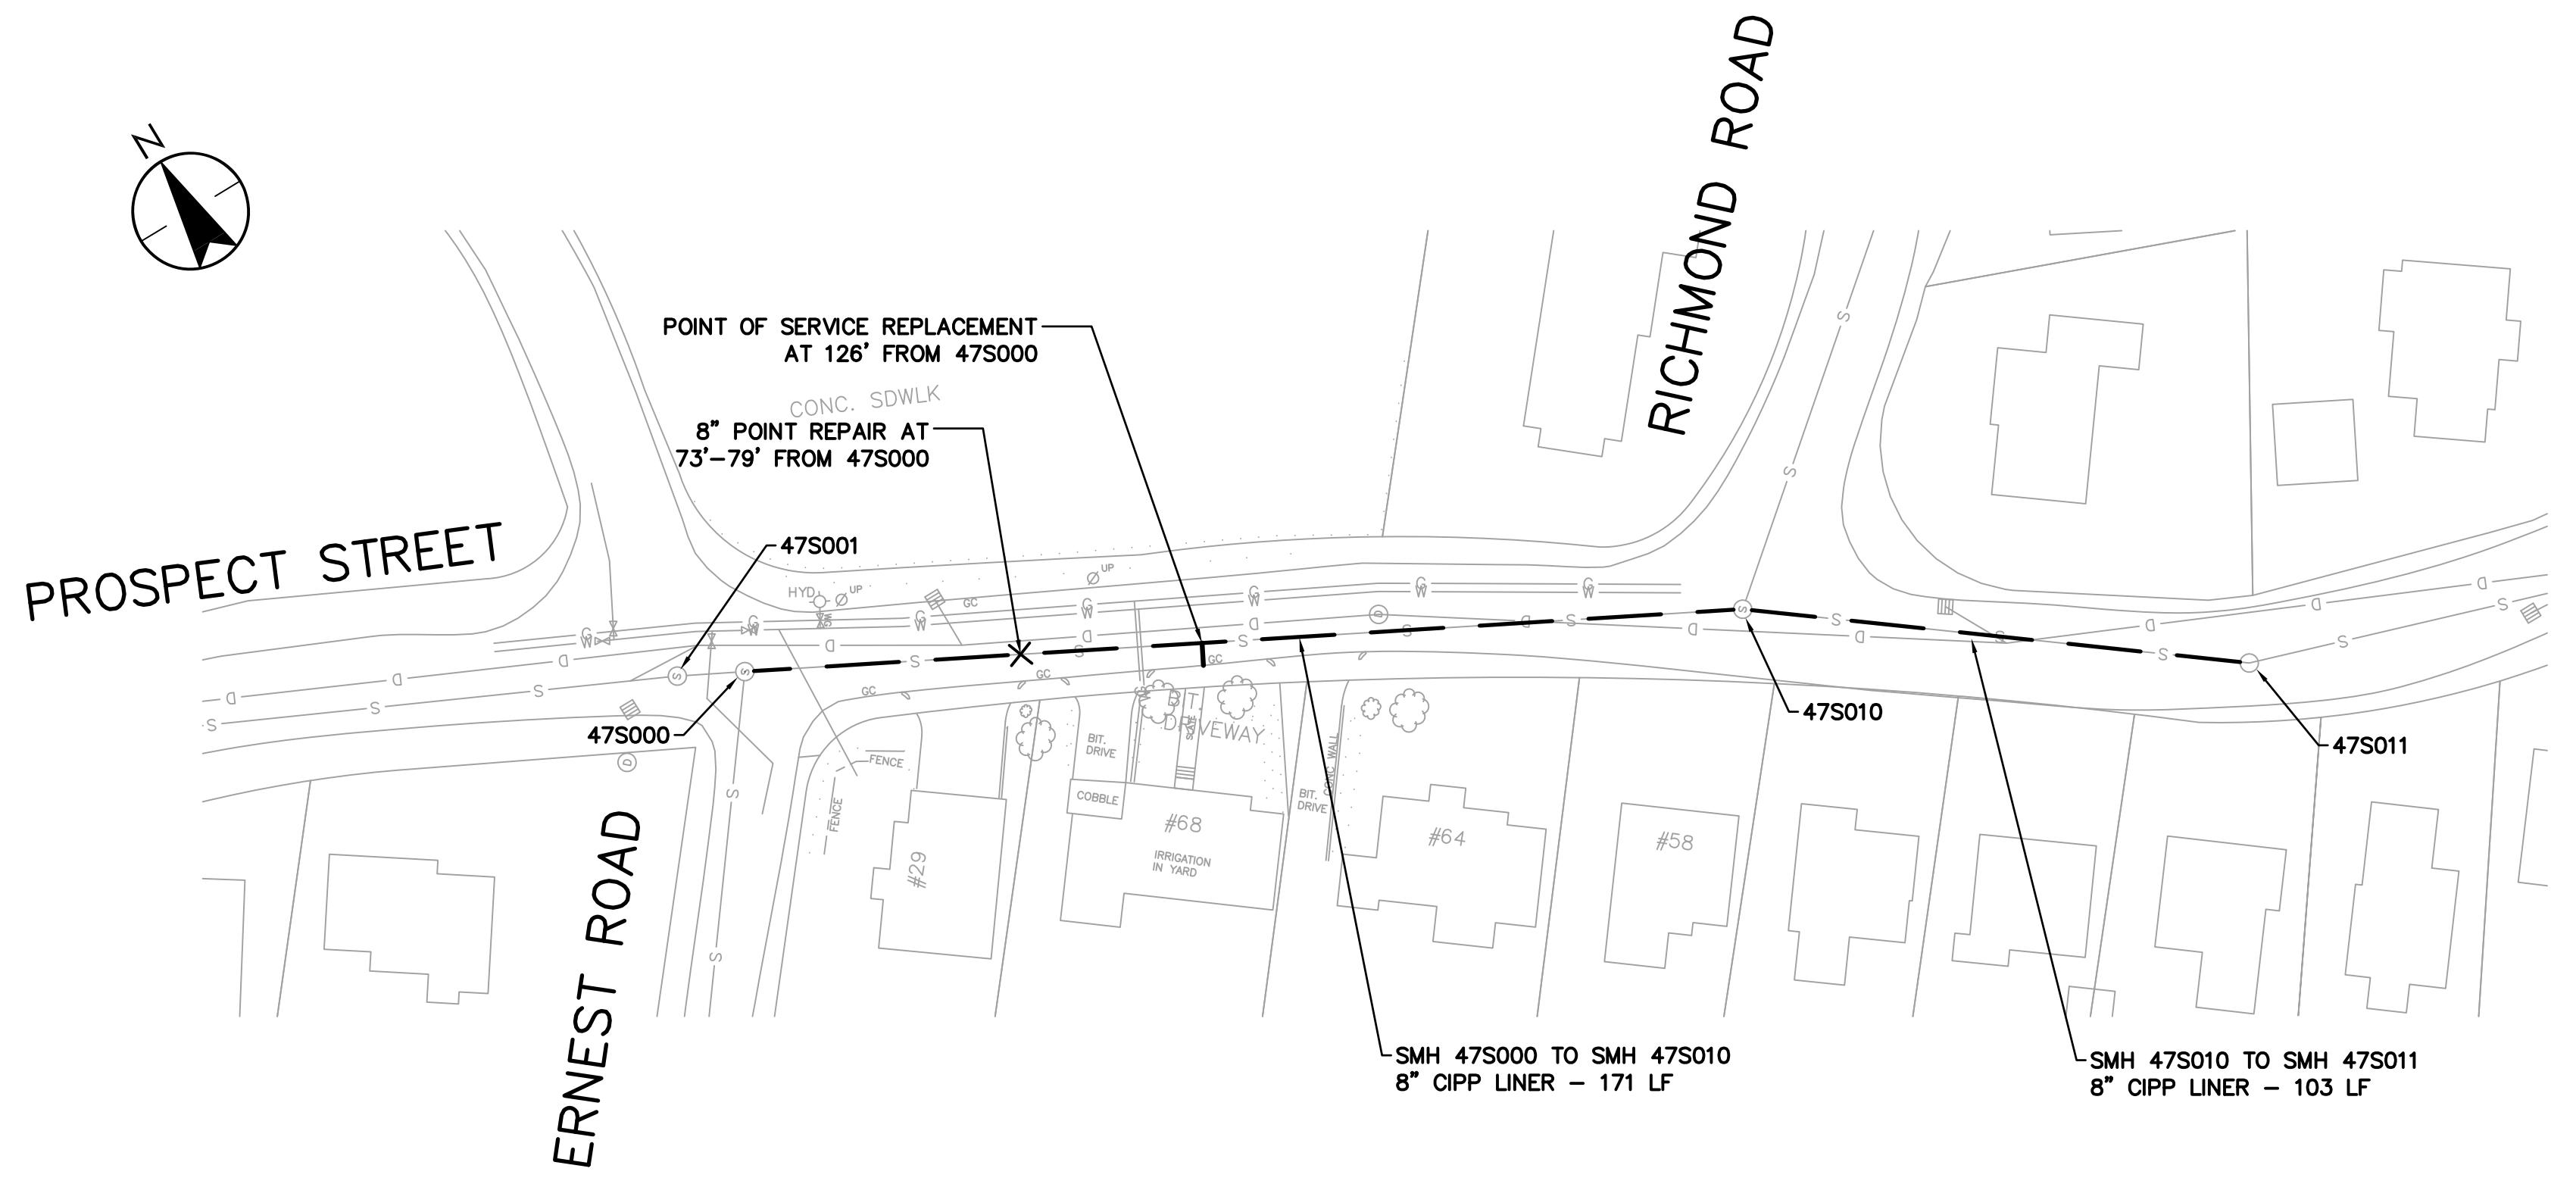

PROSPECT ST PROFILE



SCALE: HOR. 1"=40'  
VERT. 1"=4'

TOWN OF BELMONT, MASSACHUSETTS  
PRIVATE SECTOR SUMP PUMP REMOVAL &  
SEWER SYSTEM REHABILITATION  
MWRA PROJECT NO. WRA-P11-04-3-1124 &  
MWRA PROJECT NO. WRA-P11-04-3-1160  
BELMONT, MASSACHUSETTS  
PROSPECT STREET

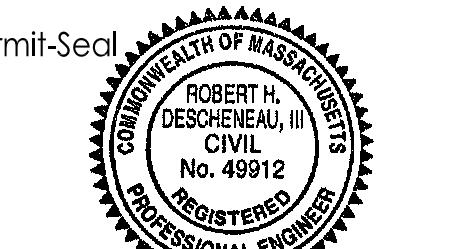


Project Number: 195113362  
File Name:  
AMD RHD RPB 21.03.31  
Dwn. Chkd. Disp. YY.MM.DD  
Drawing No. C-109  
Revision Sheet







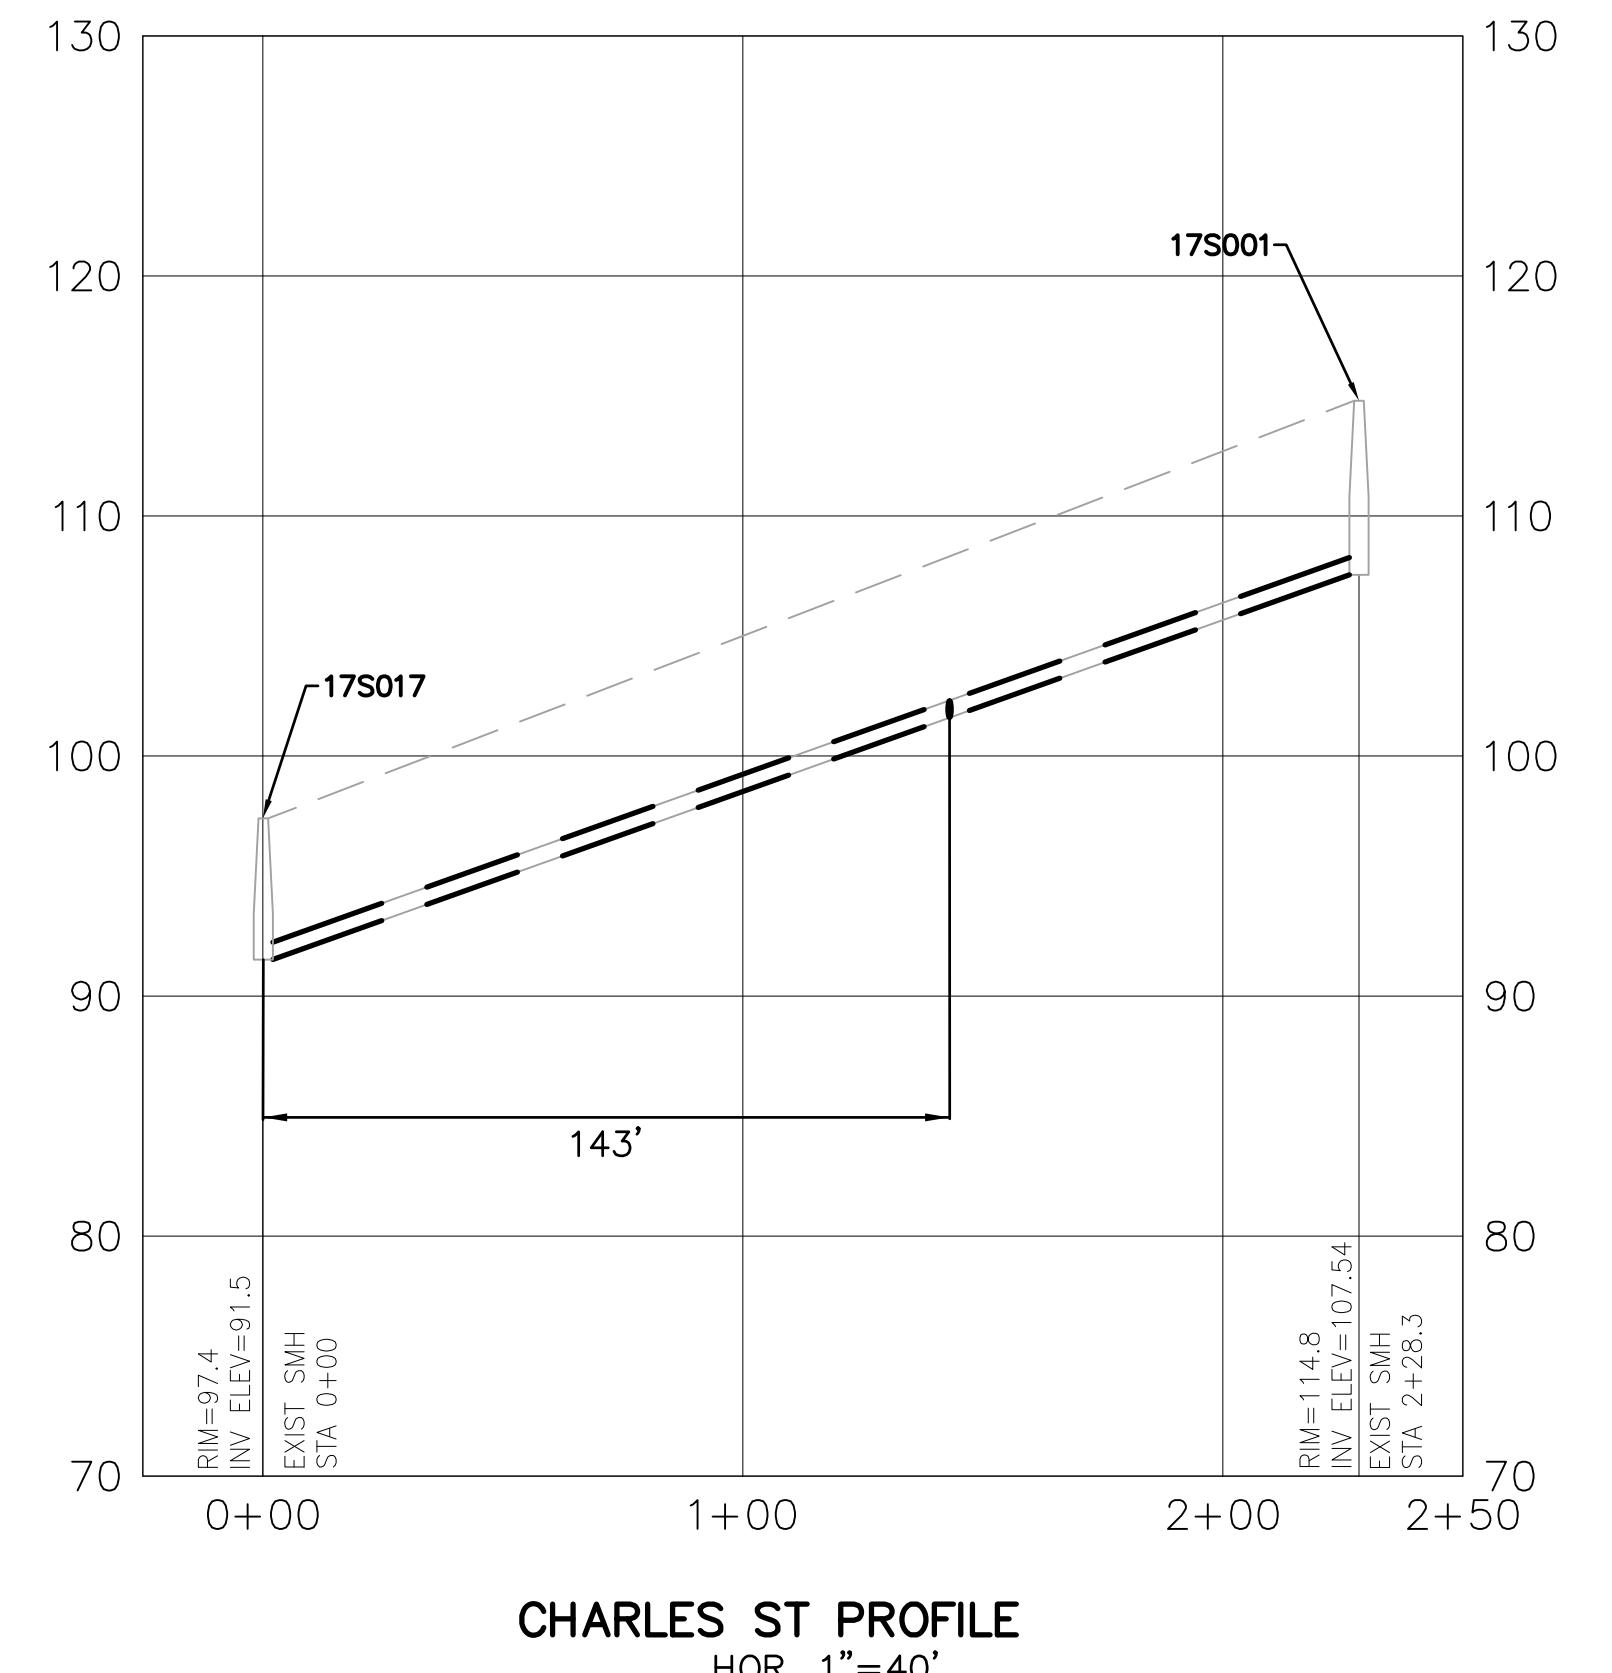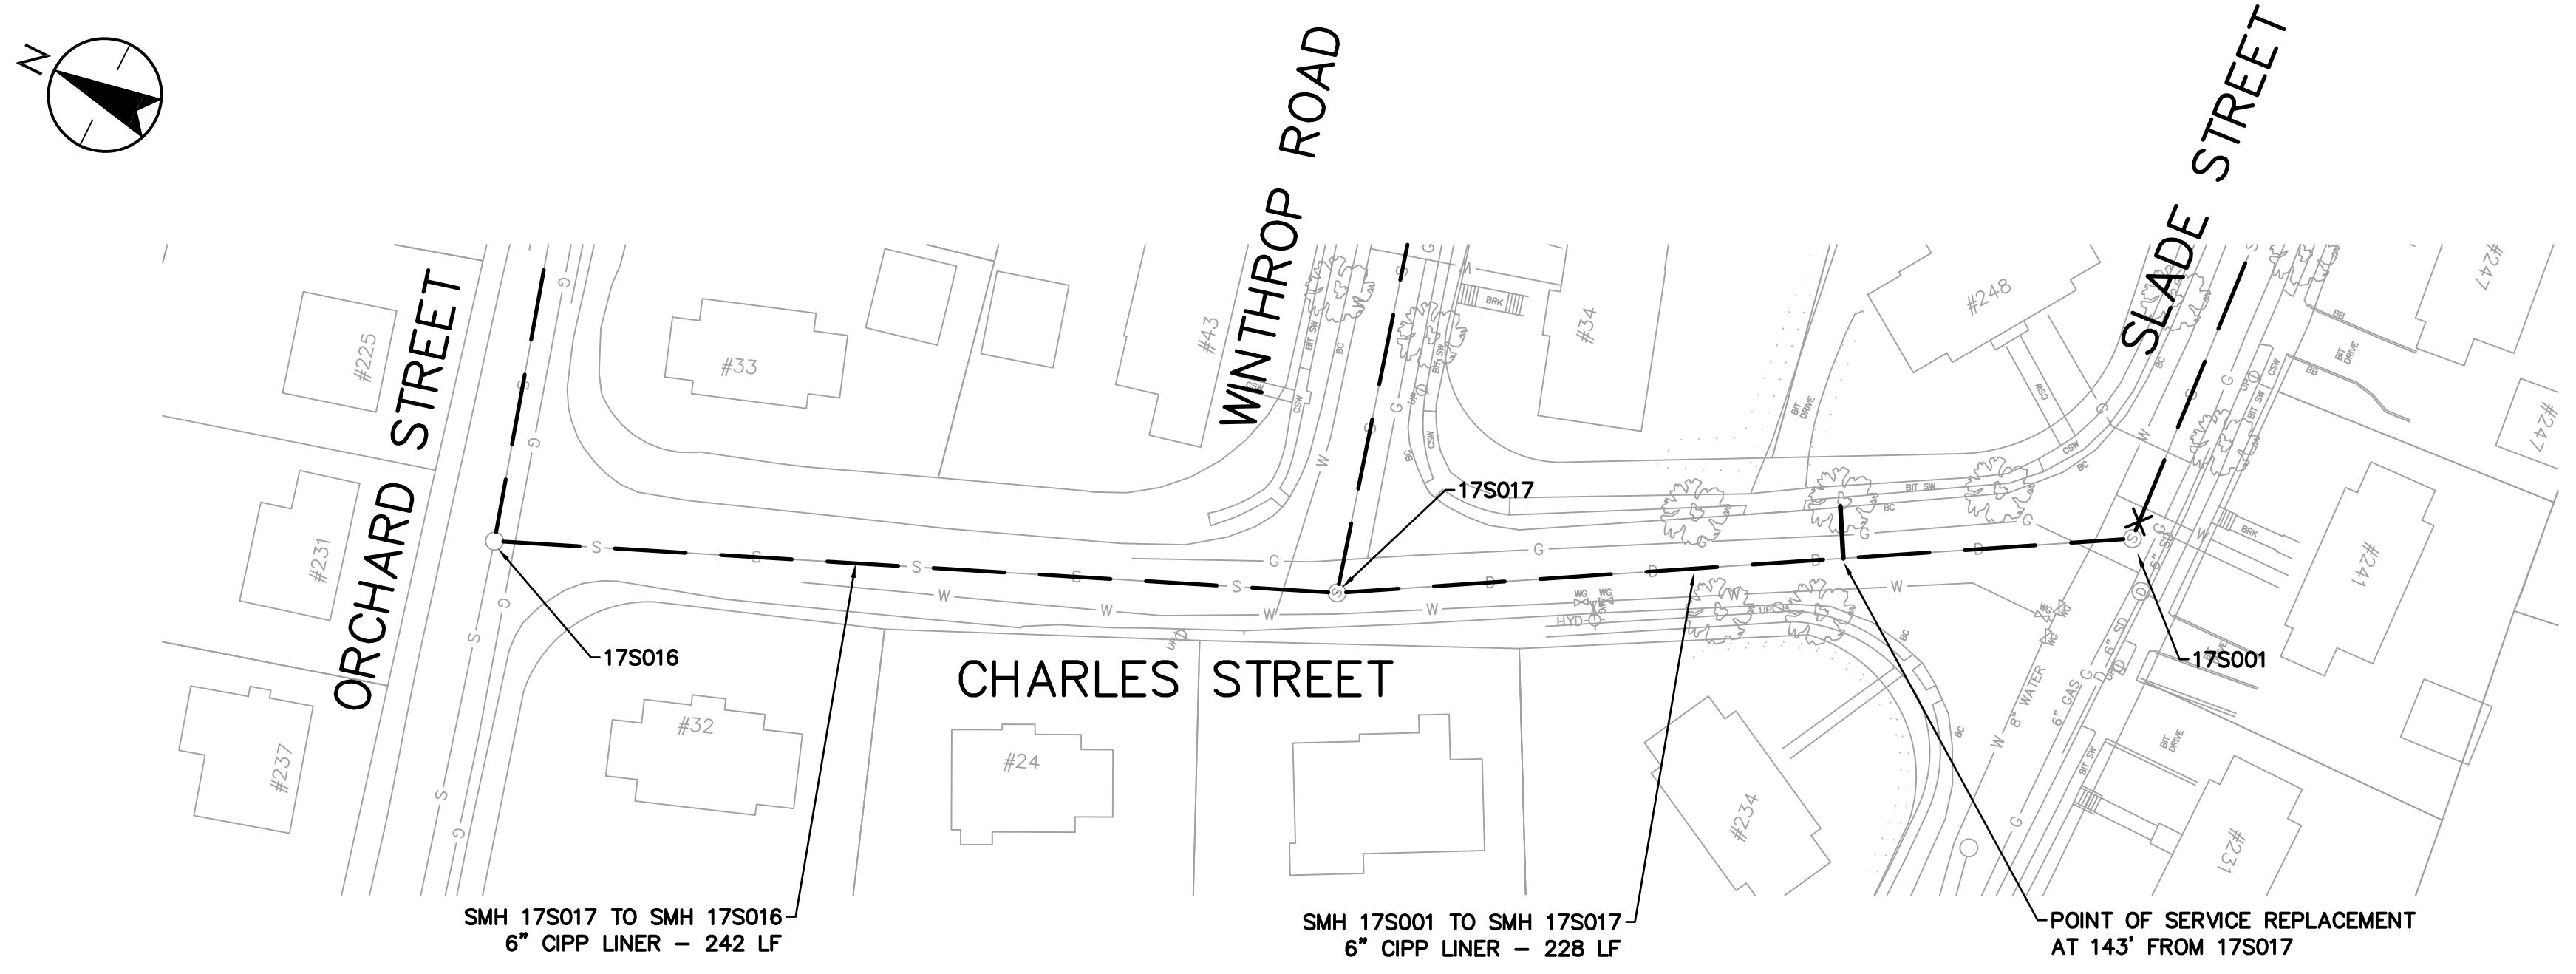


TOWN OF BELMONT, MASSACHUSETTS  
PRIVATE SECTOR SUMP PUMP REMOVAL &  
SEWER SYSTEM REHABILITATION  
MWRA PROJECT NO. WRA-P11-04-3-1124 &  
MWRA PROJECT NO. WRA-P11-04-3-1160  
BELMONT, MASSACHUSETTS  
CHARLES STREET

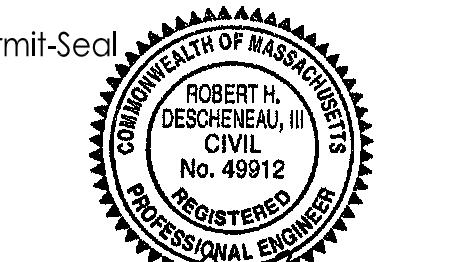



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AMD RHD RPB 21.03.31  
Dwn. Chkd. Rgn. YY.MM.DD  
Drawing No. C-111  
Revision Sheet  
0 15 of

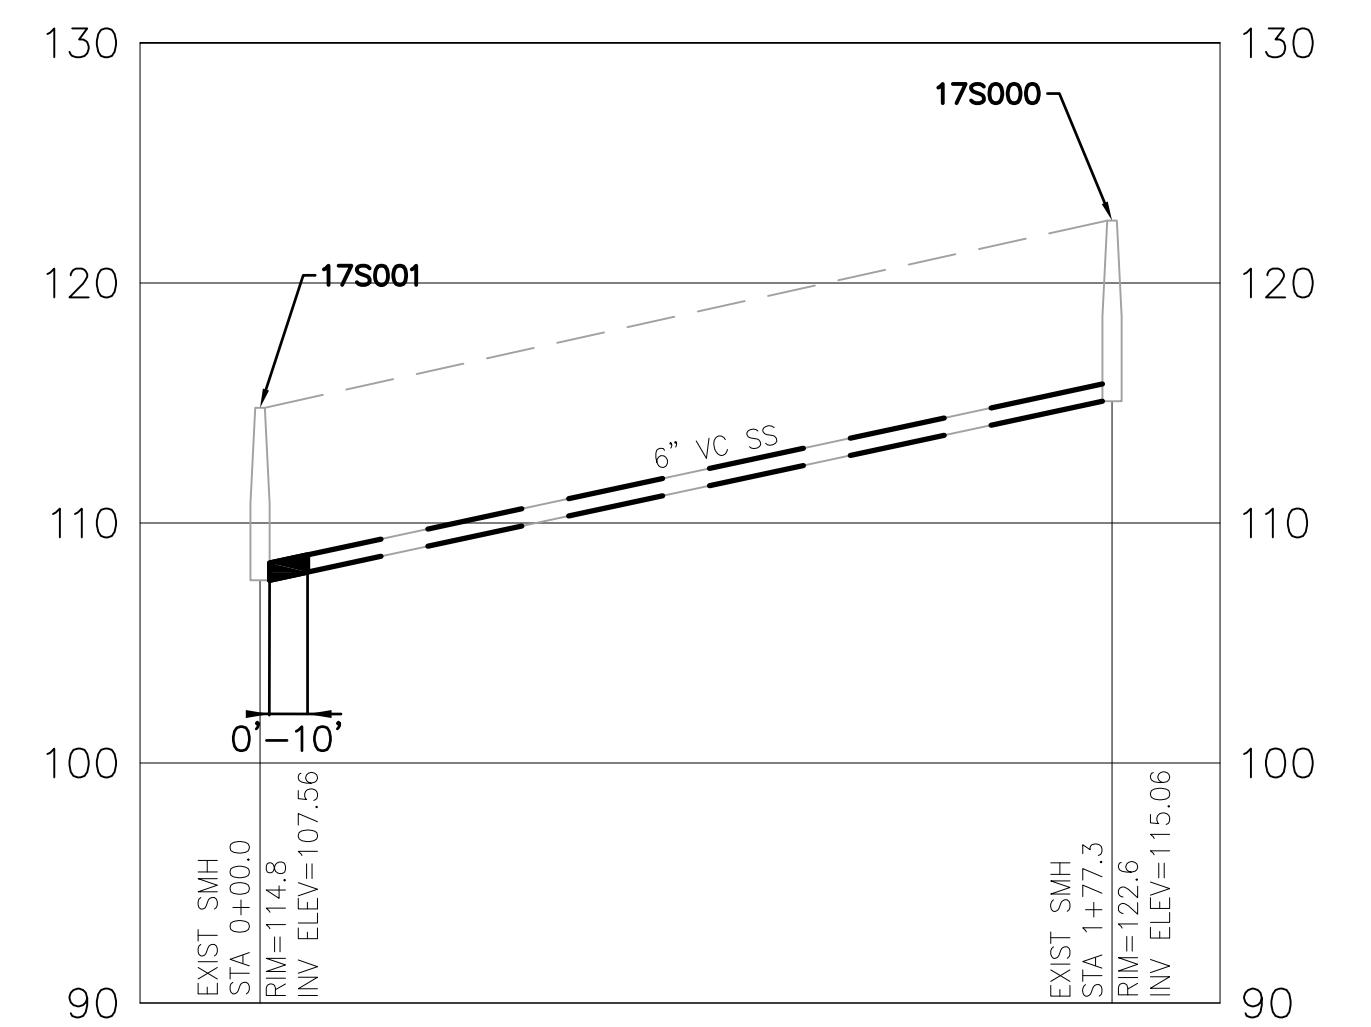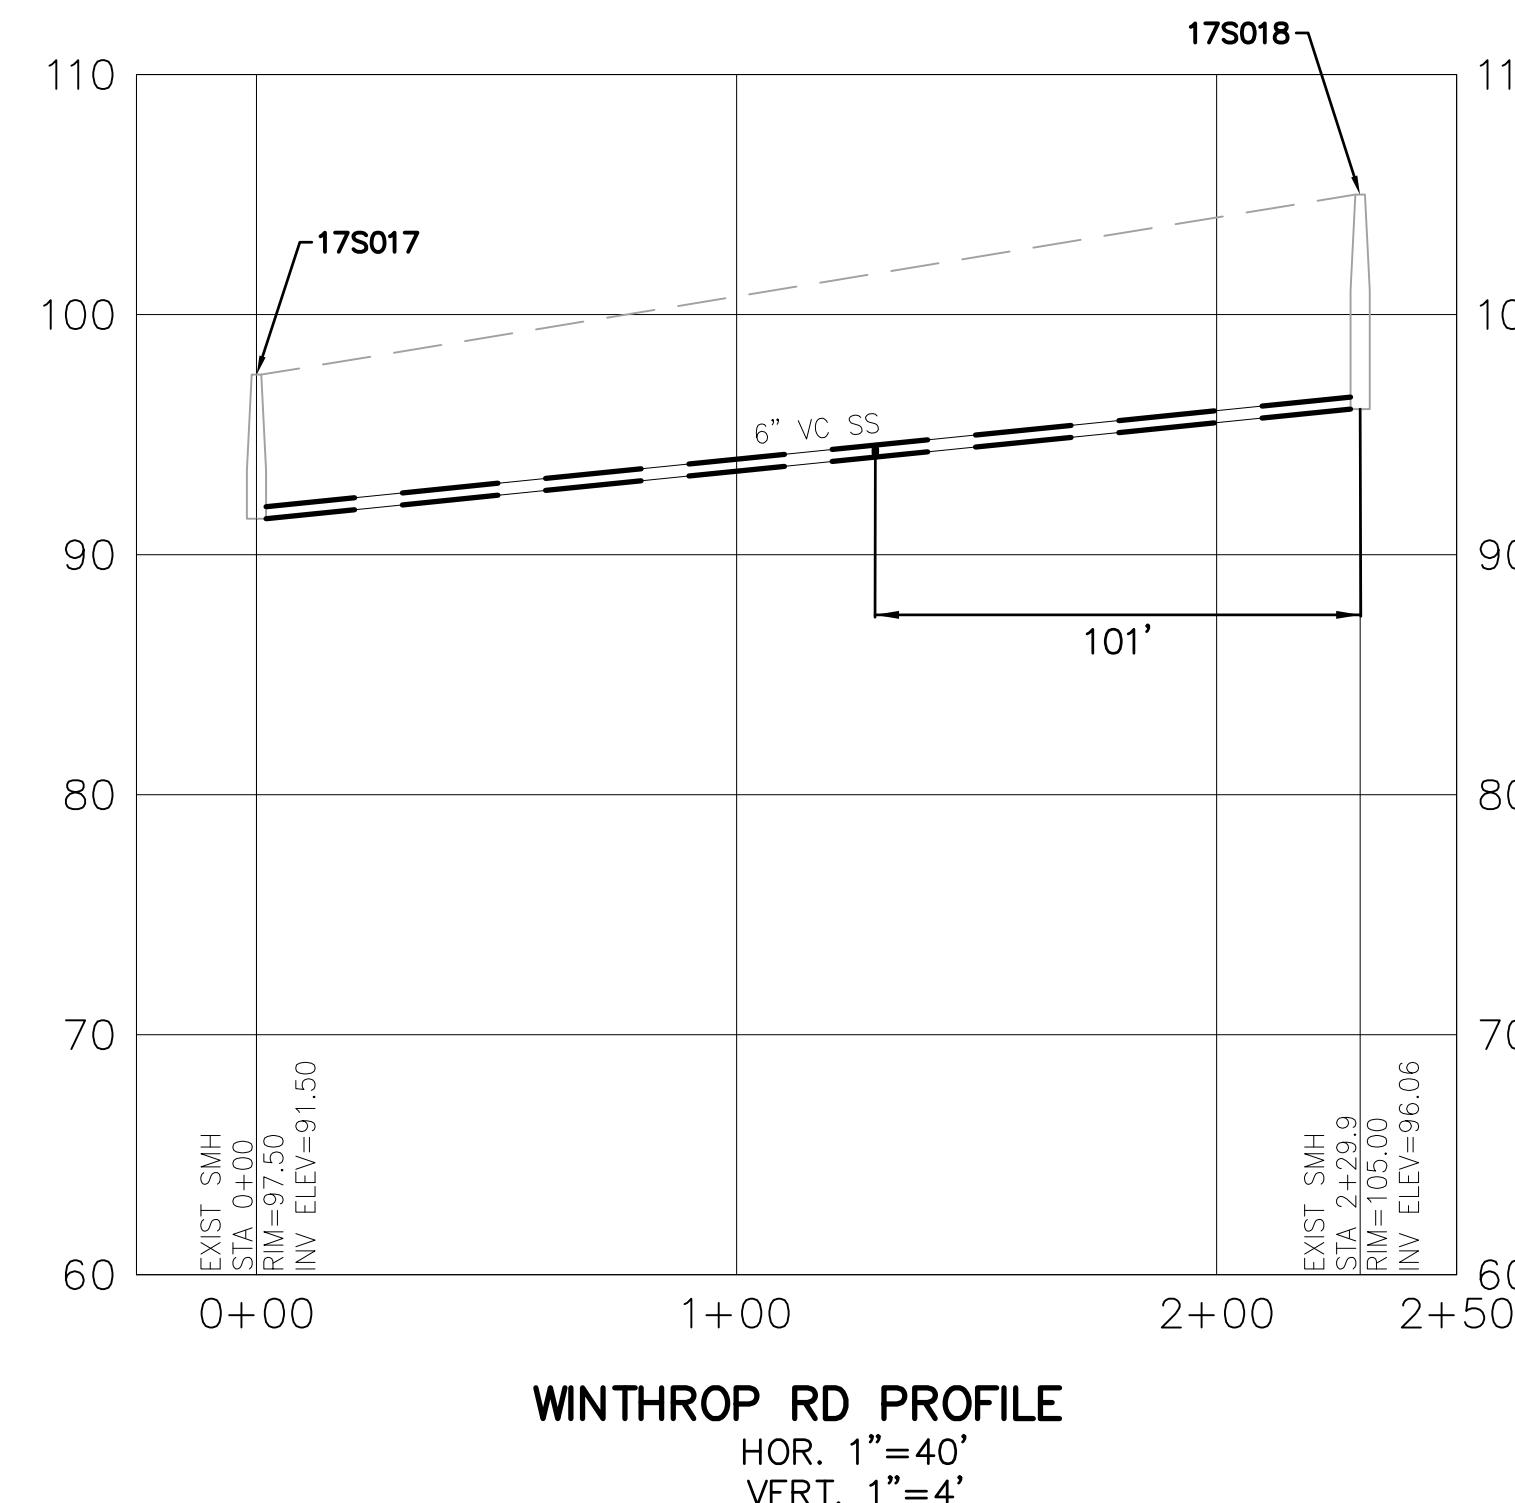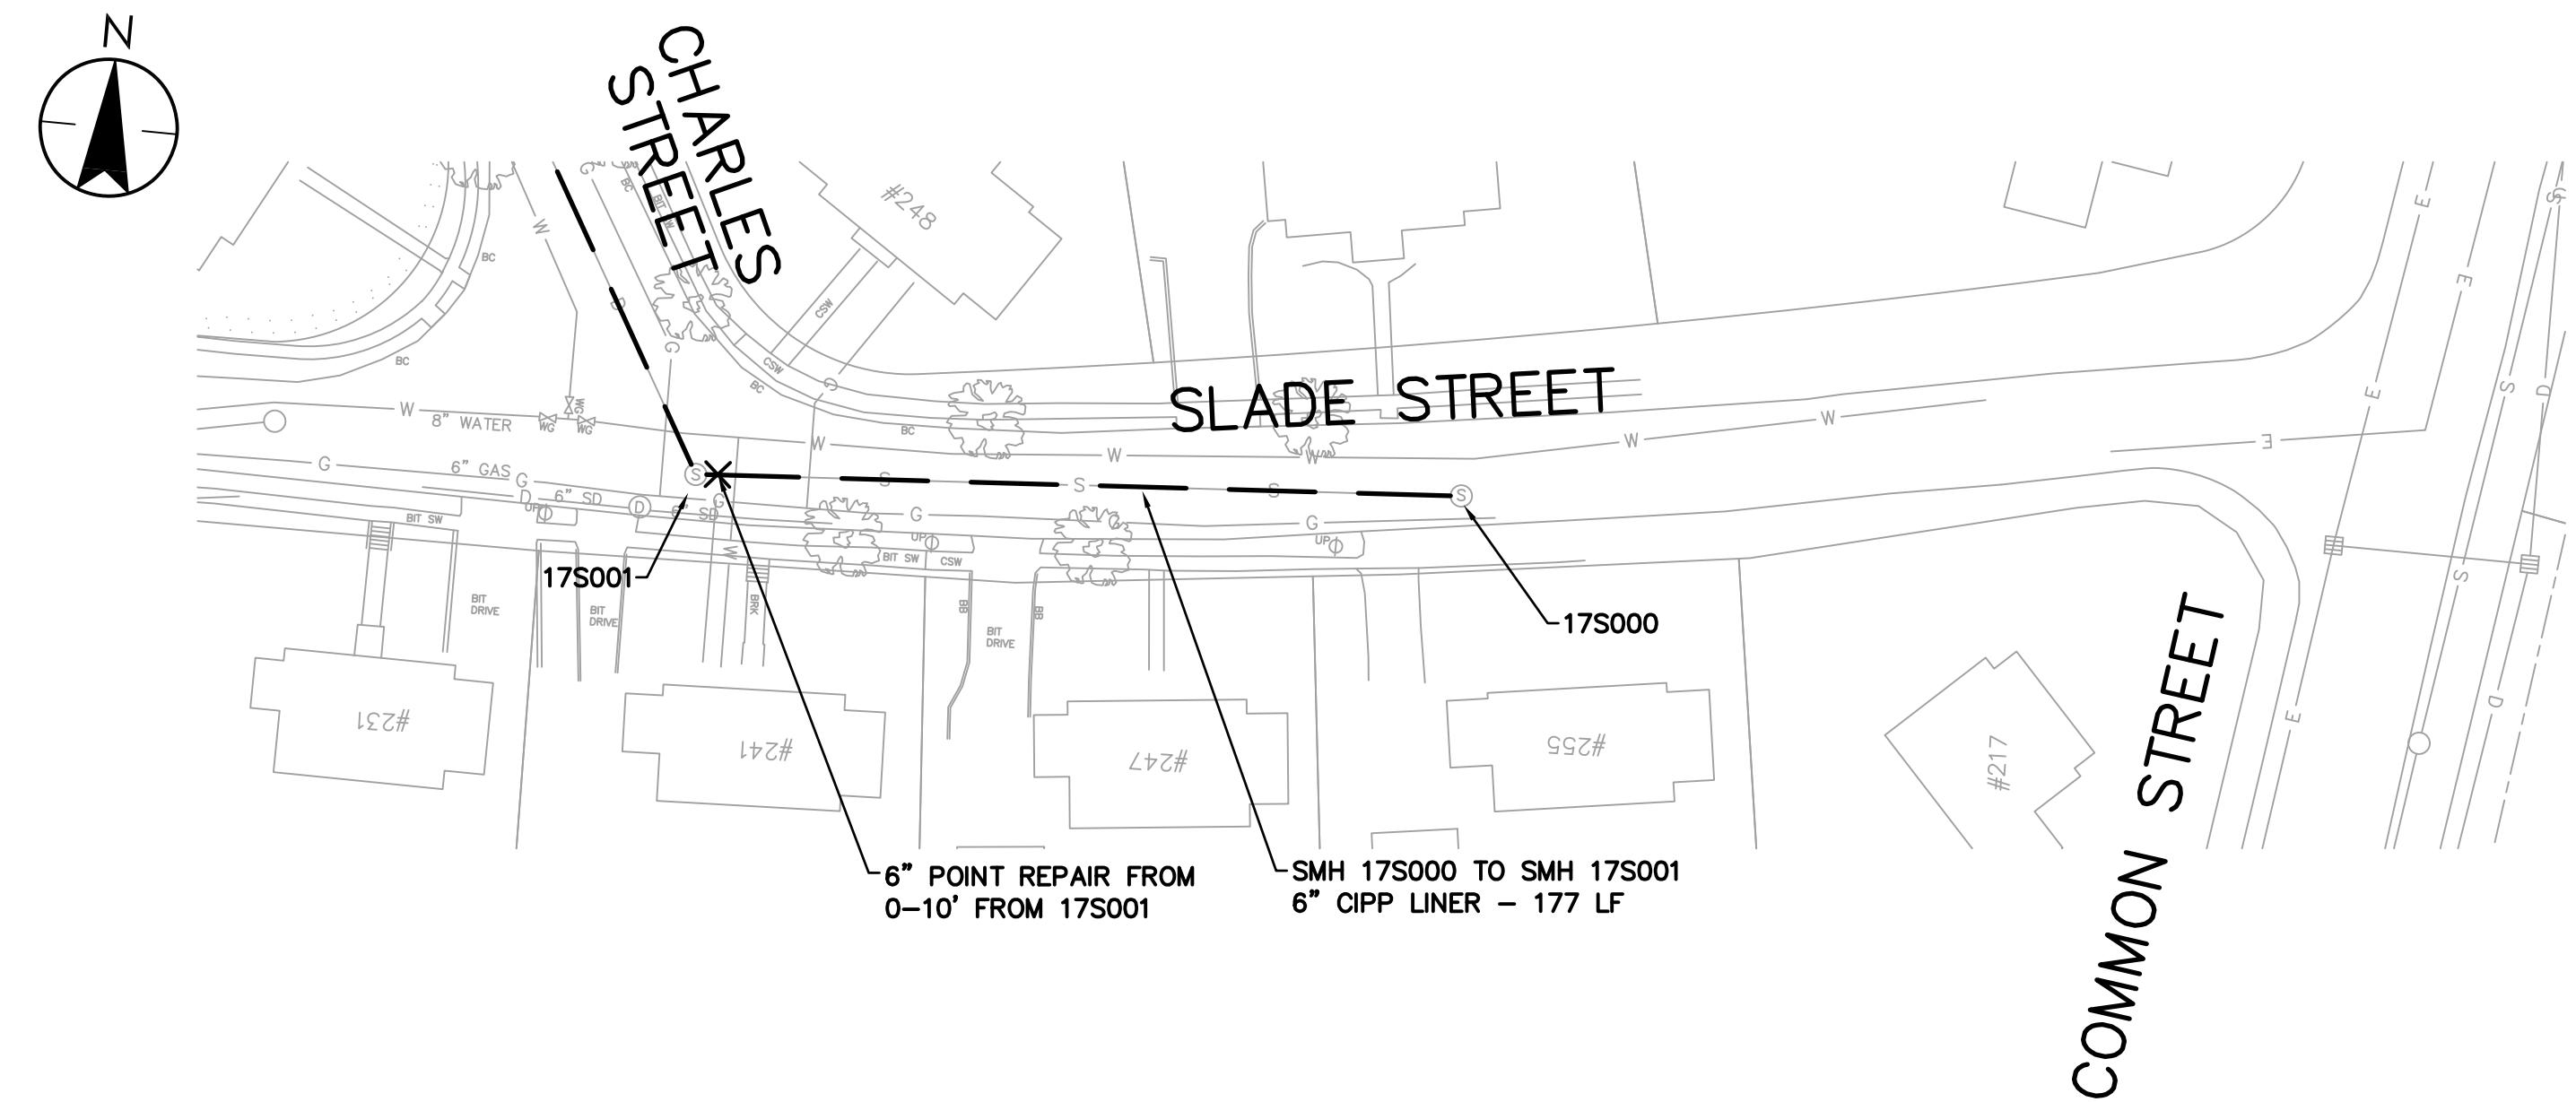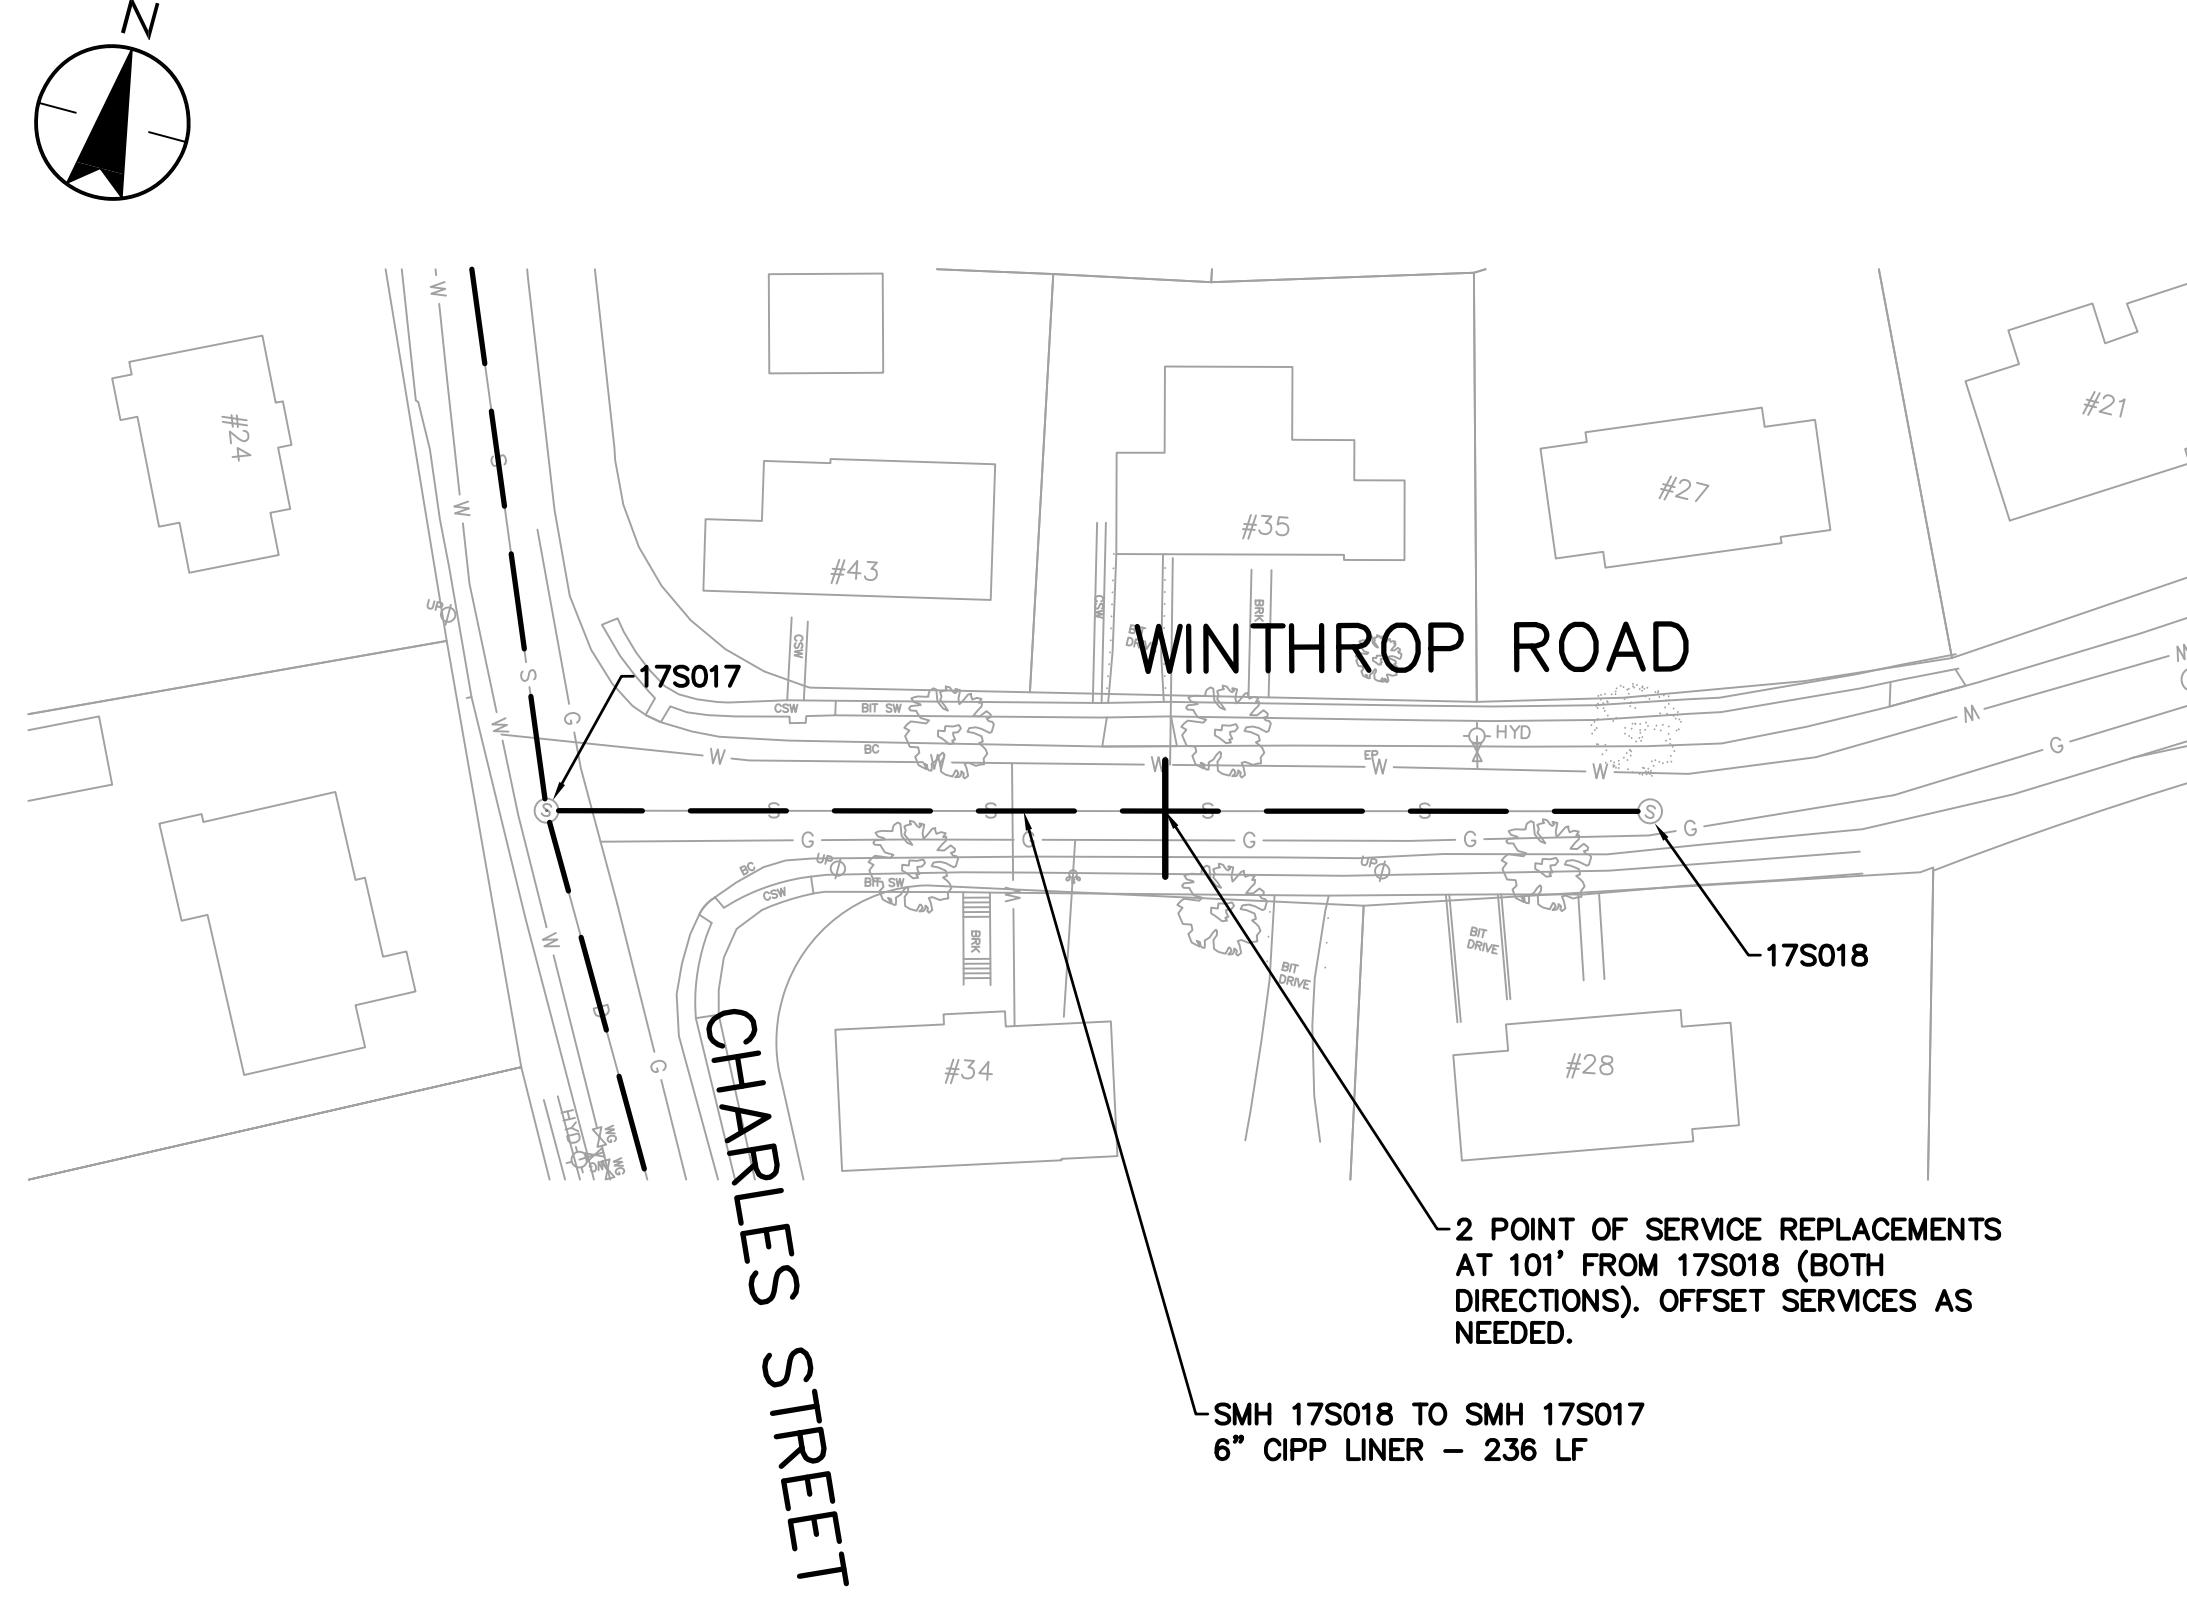


TOWN OF BELMONT, MASSACHUSETTS  
PRIVATE SECTOR SUMP PUMP REMOVAL &  
SEWER SYSTEM REHABILITATION  
MWRA PROJECT NO. WRA-P11-04-3-1124 &  
MWRA PROJECT NO. WRA-P11-04-3-1160  
BELMONT, MASSACHUSETTS  
WINTHROP ROAD AND SLADE STREET

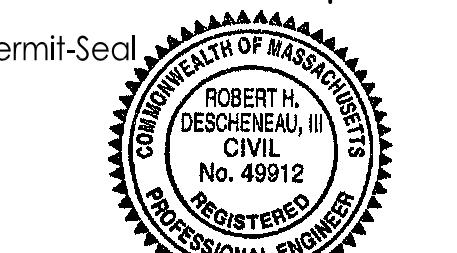




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AMD RHD RPB 21.03.31  
Dwn. Chkd. Dsgn. YY.MM.DD  
Drawing No. C-112  
Revision Sheet  
0 16 of

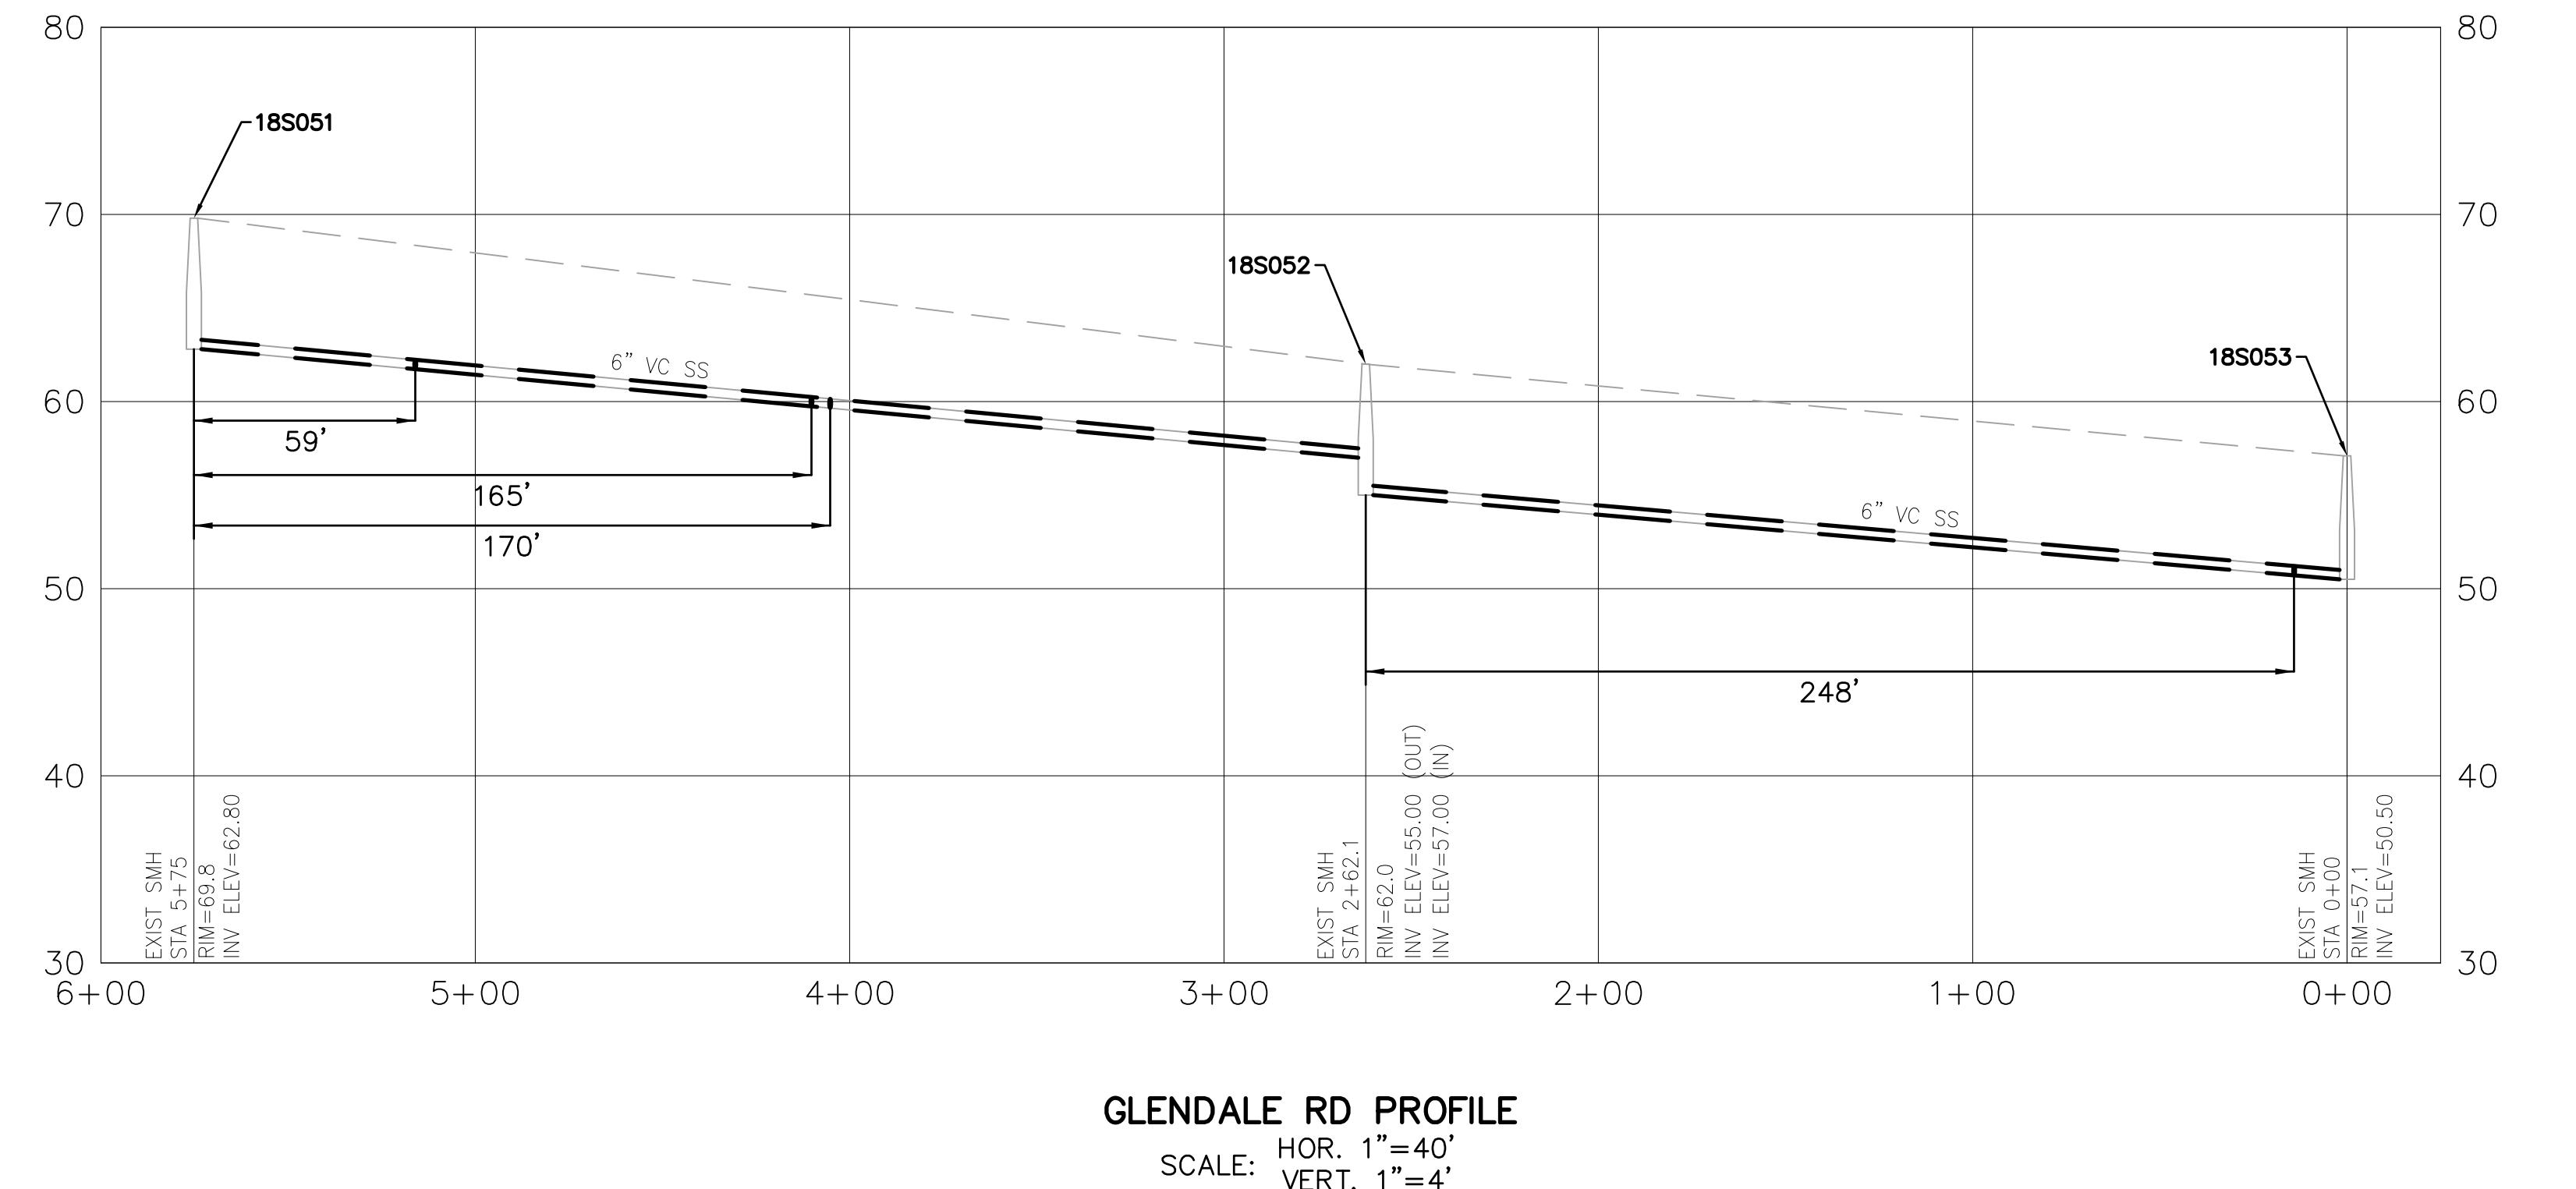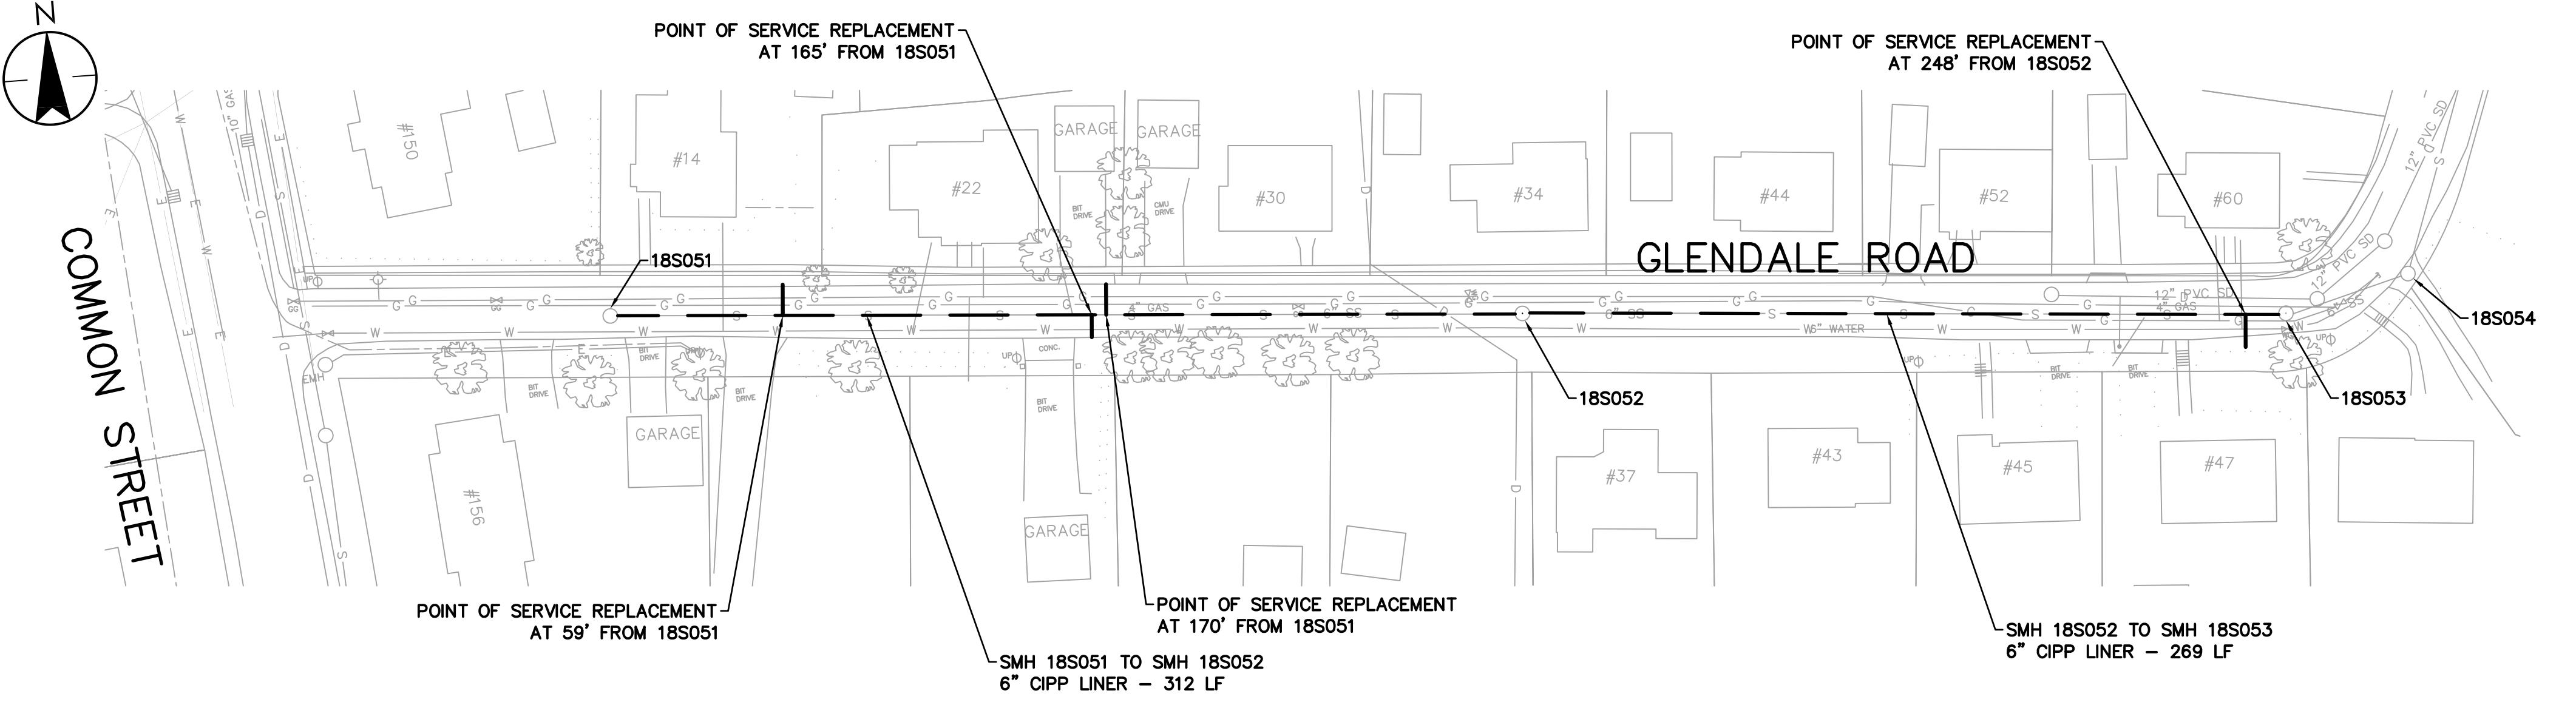


TOWN OF BELMONT, MASSACHUSETTS  
PRIVATE SECTOR SUMP PUMP REMOVAL &  
SEWER SYSTEM REHABILITATION  
MWRA PROJECT NO. WRA-P11-04-3-1124 &  
MWRA PROJECT NO. WRA-P11-04-3-1160  
BELMONT, MASSACHUSETTS  
Glendale Road

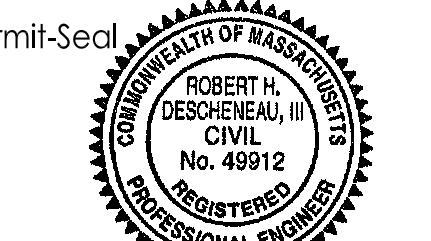

Project Number: 195113362  
File Name:  
AMD RHD RPB 21.03.31  
Dwn. Chkd. Dsgn. YY.MM.DD  
Drawing No. C-113  
Revision Sheet  
0 17 of

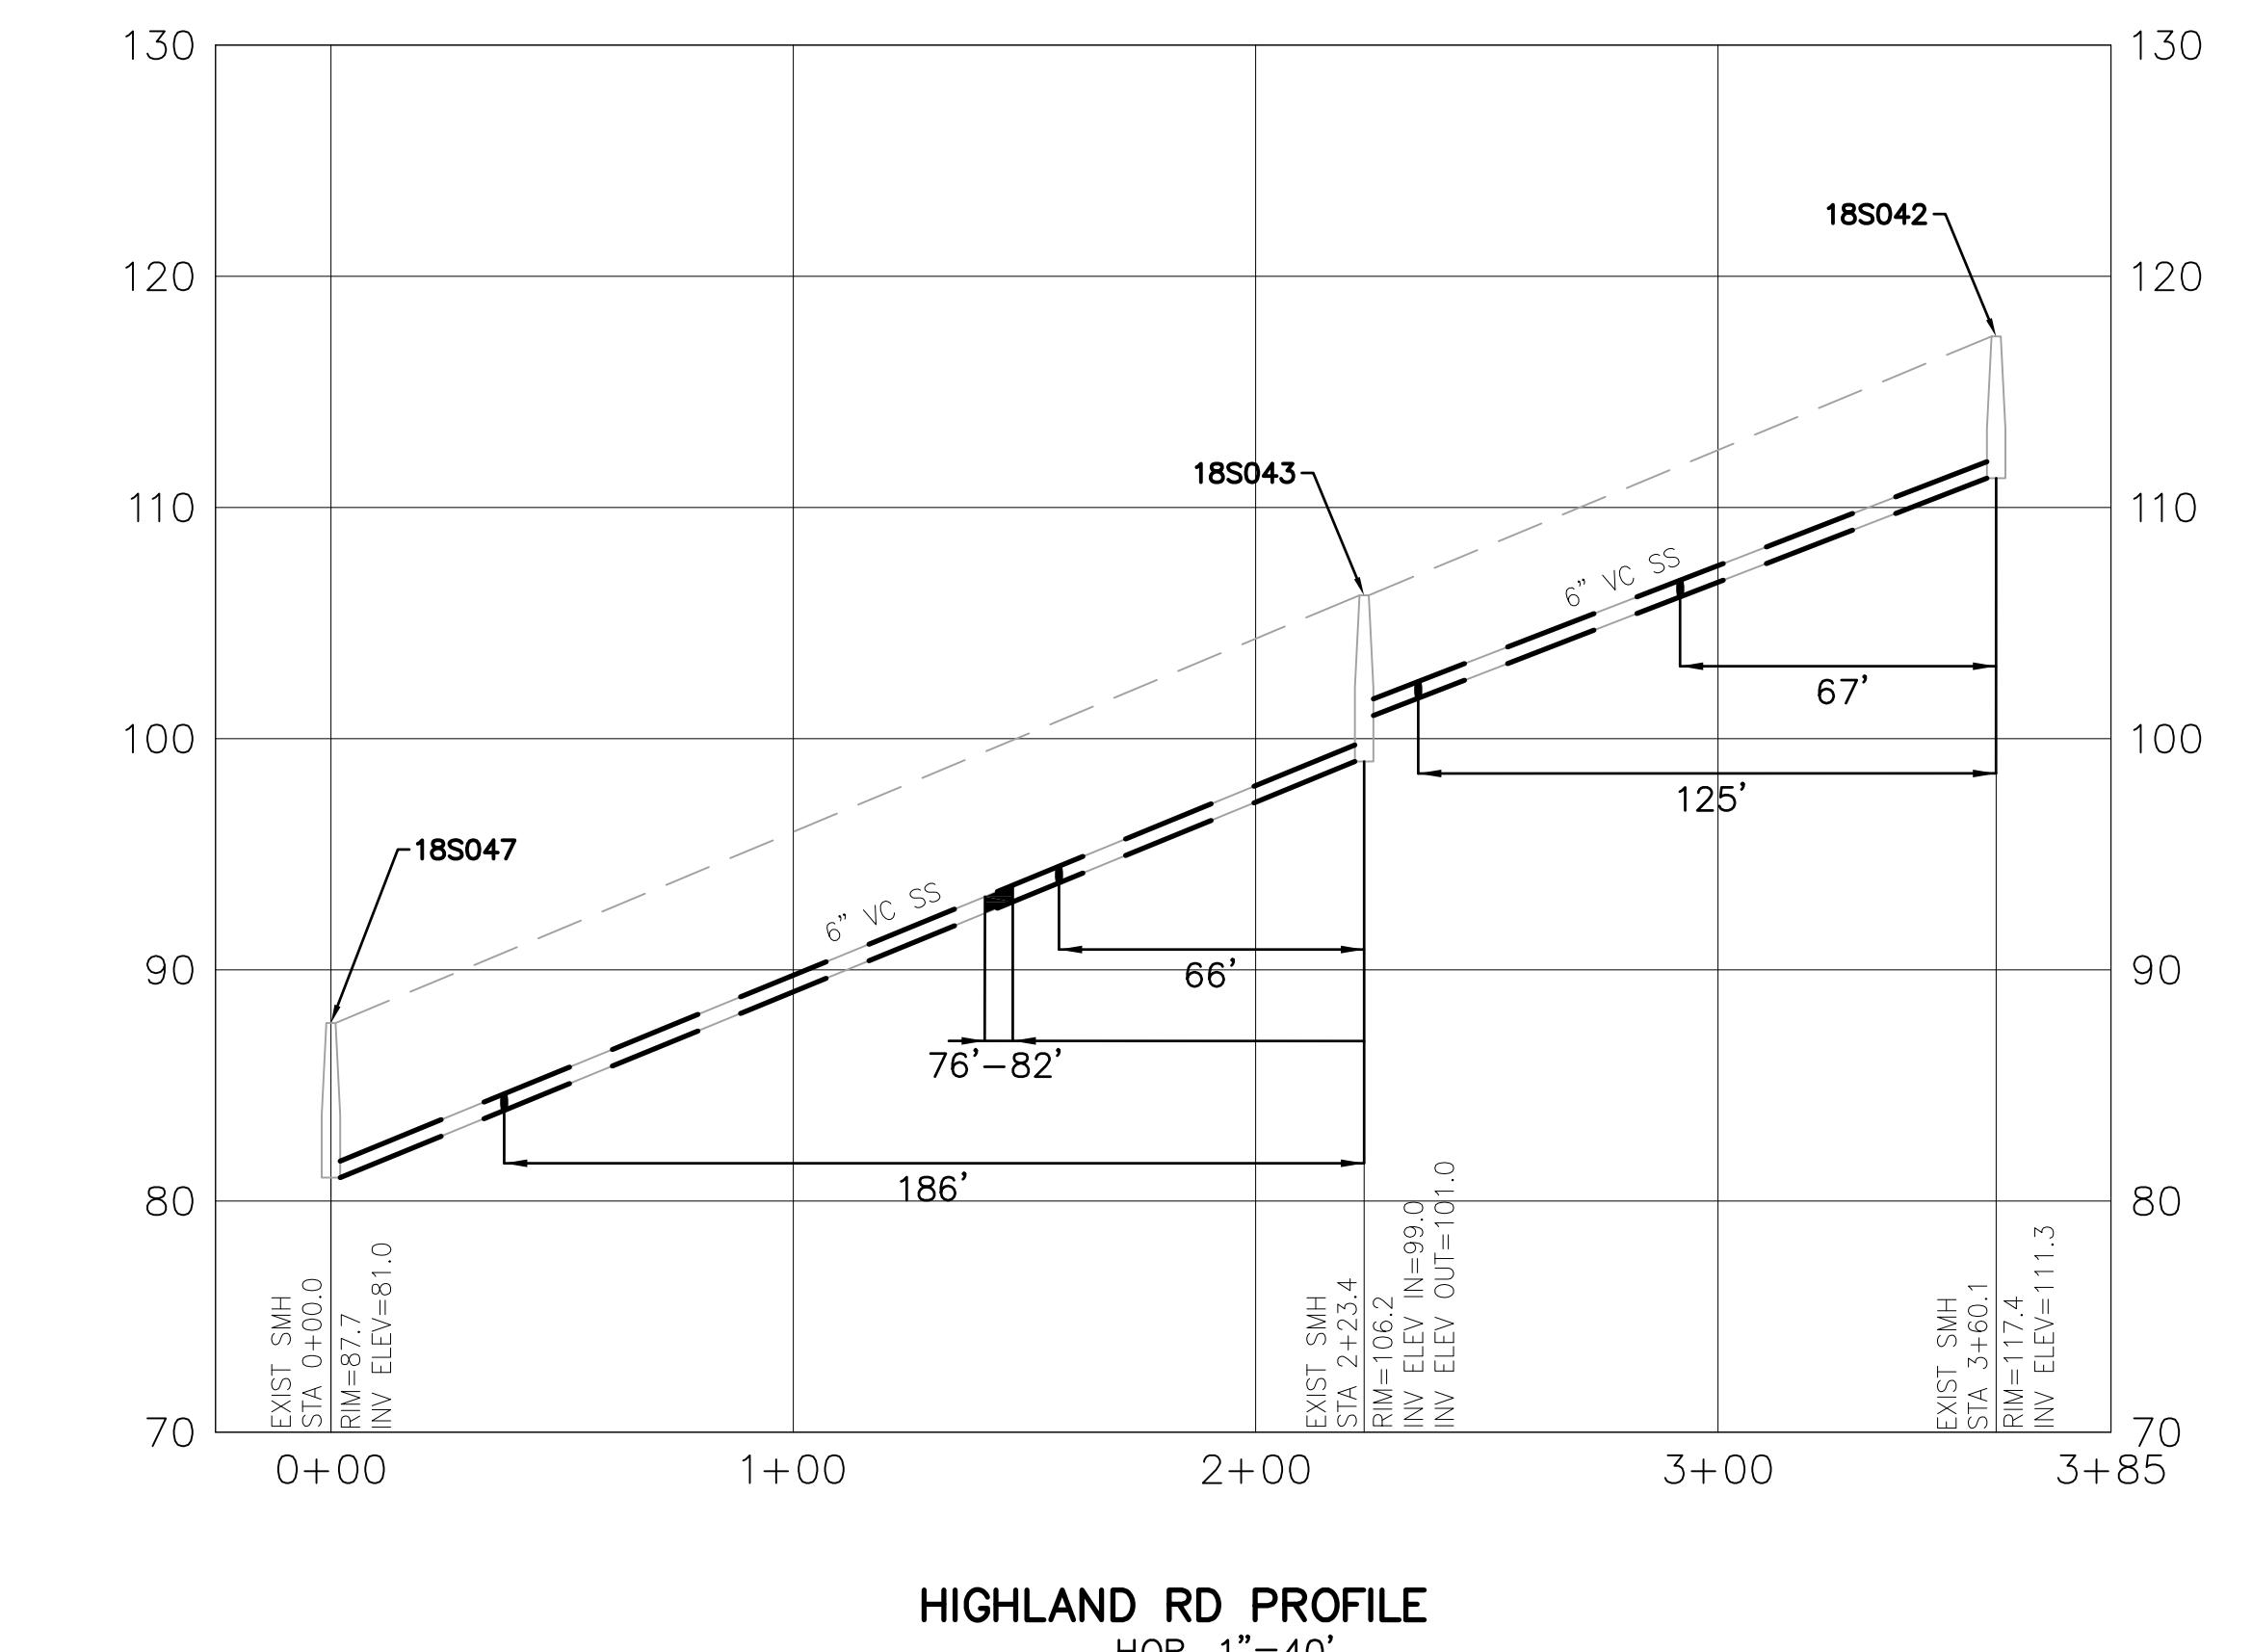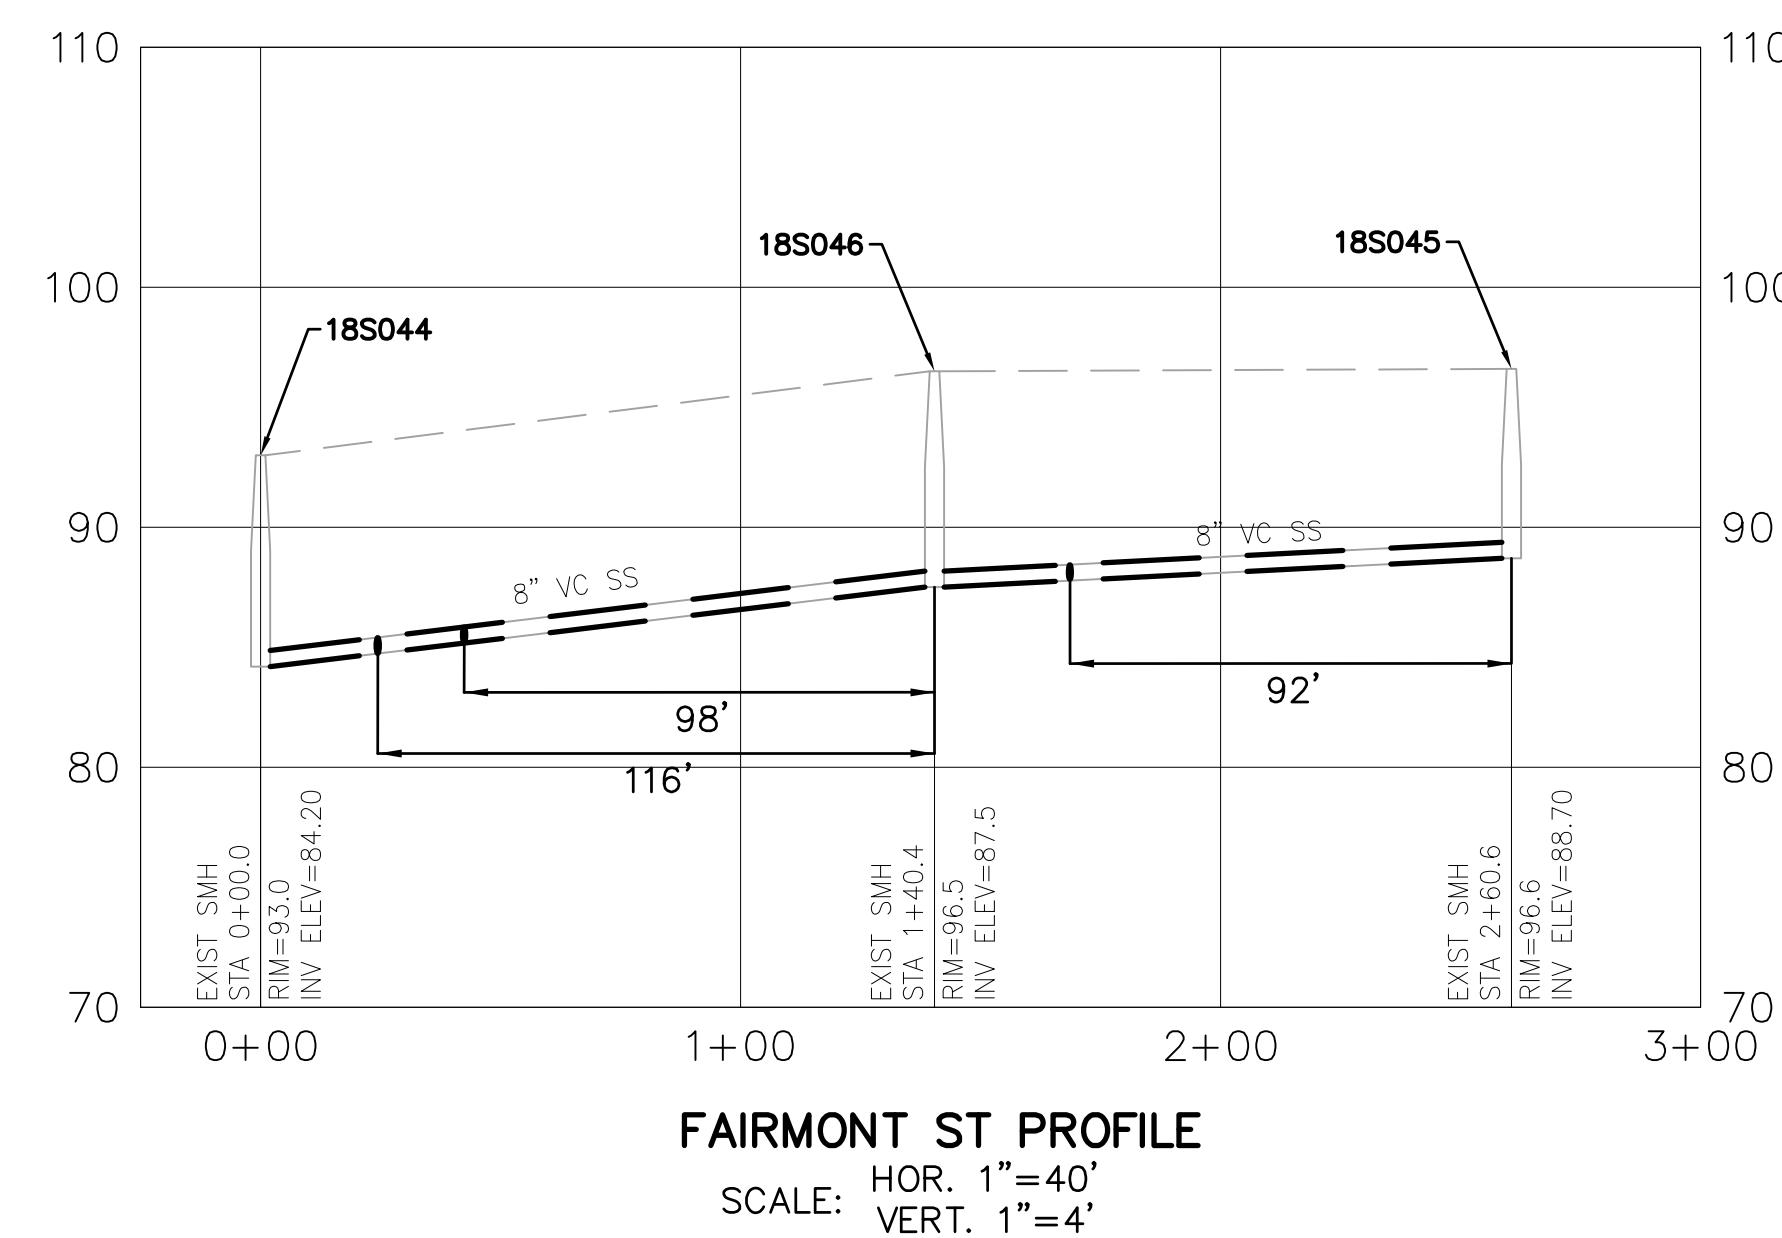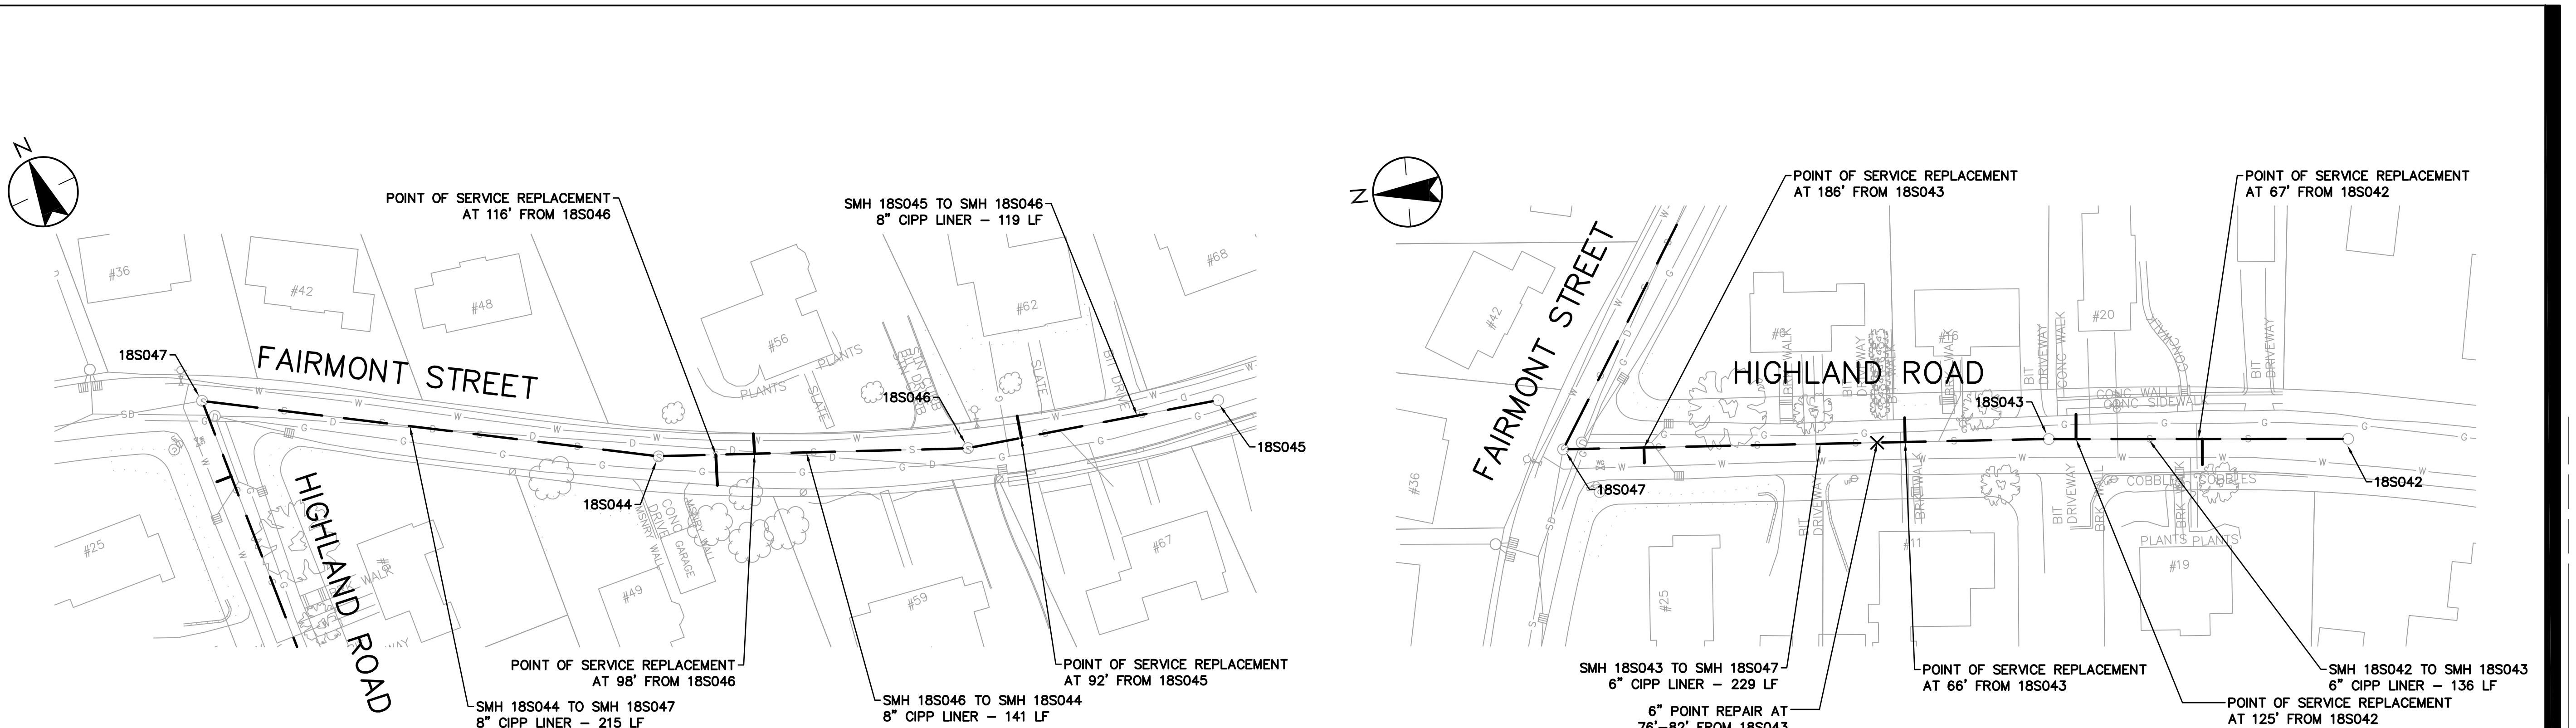

TOWN OF BELMONT, MASSACHUSETTS  
PRIVATE SECTOR SUMP PUMP REMOVAL &  
SEWER SYSTEM REHABILITATION  
MWRA PROJECT NO. WRA-P11-04-3-1124 &  
MWRA PROJECT NO. WRA-P11-04-3-1160  
BELMONT, MASSACHUSETTS  
FAIRMONT STREET AND HIGHLAND ROAD

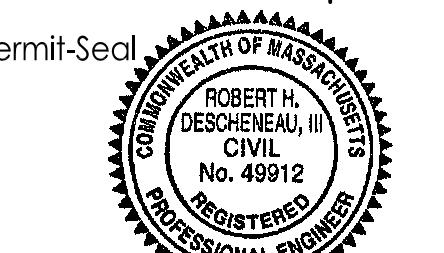


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AMD RHD RPB 21.03.31  
Dwn. Chkd. Disp. YY.MM.DD






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Revision Sheet


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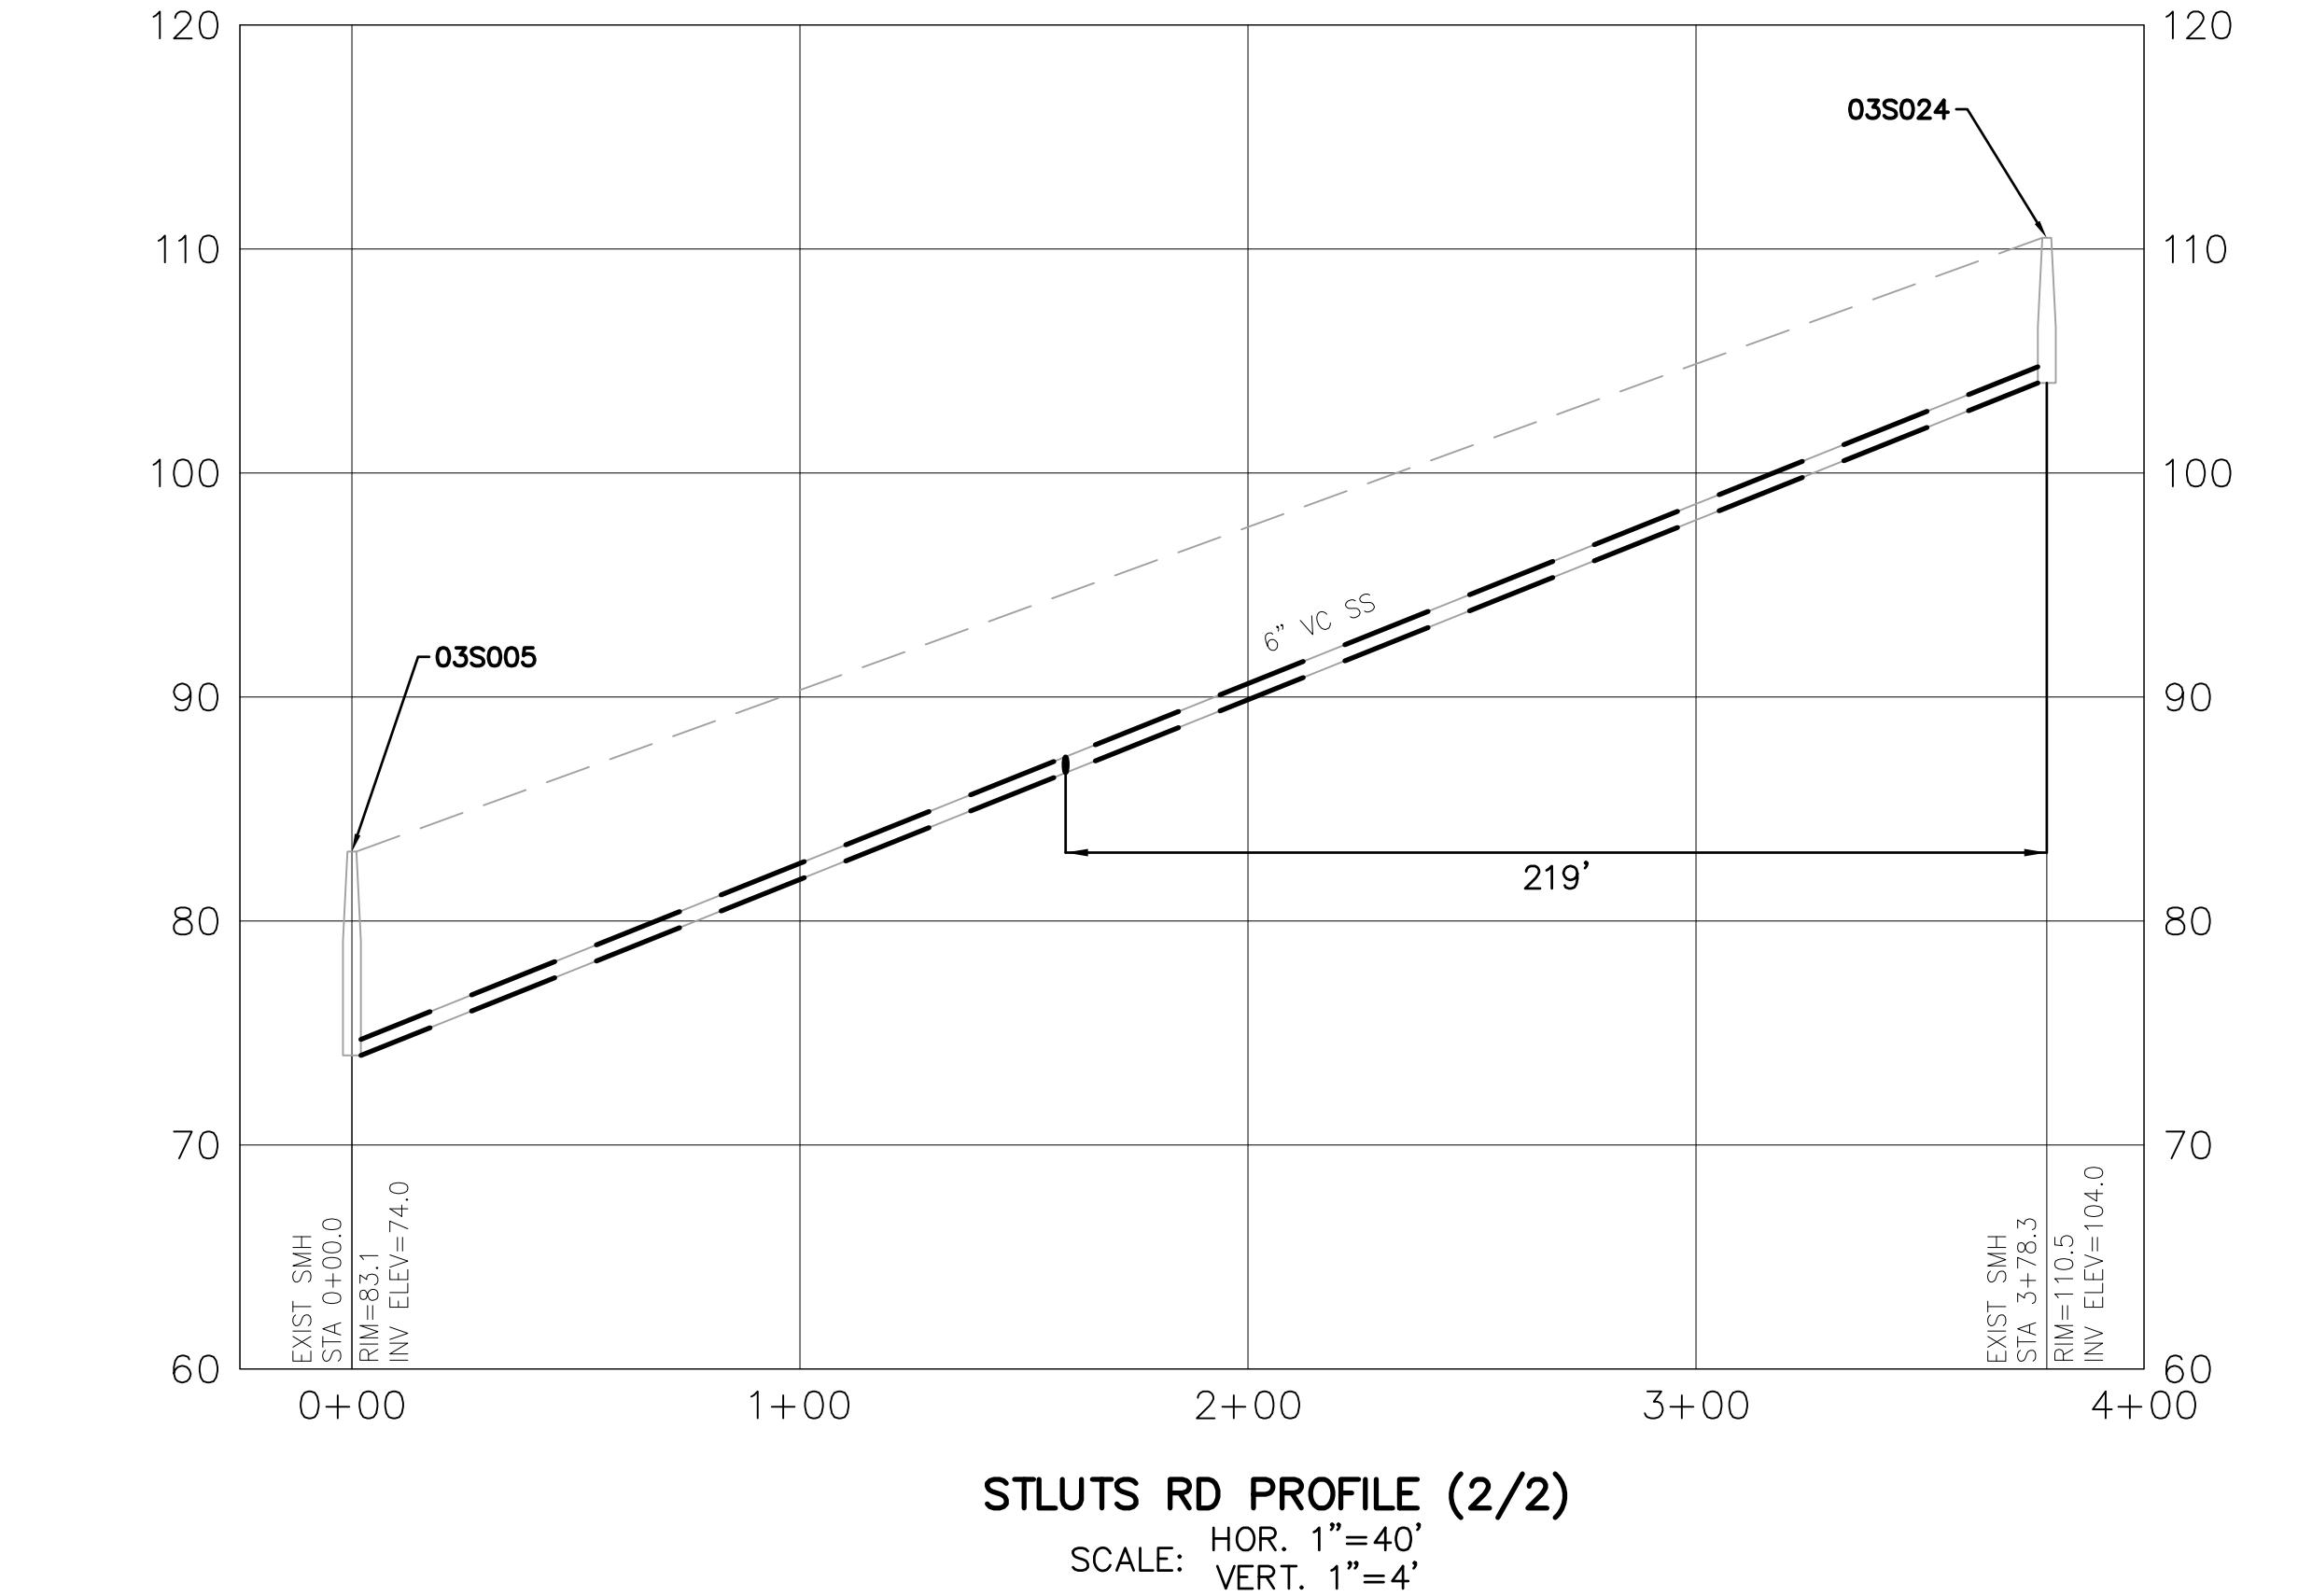
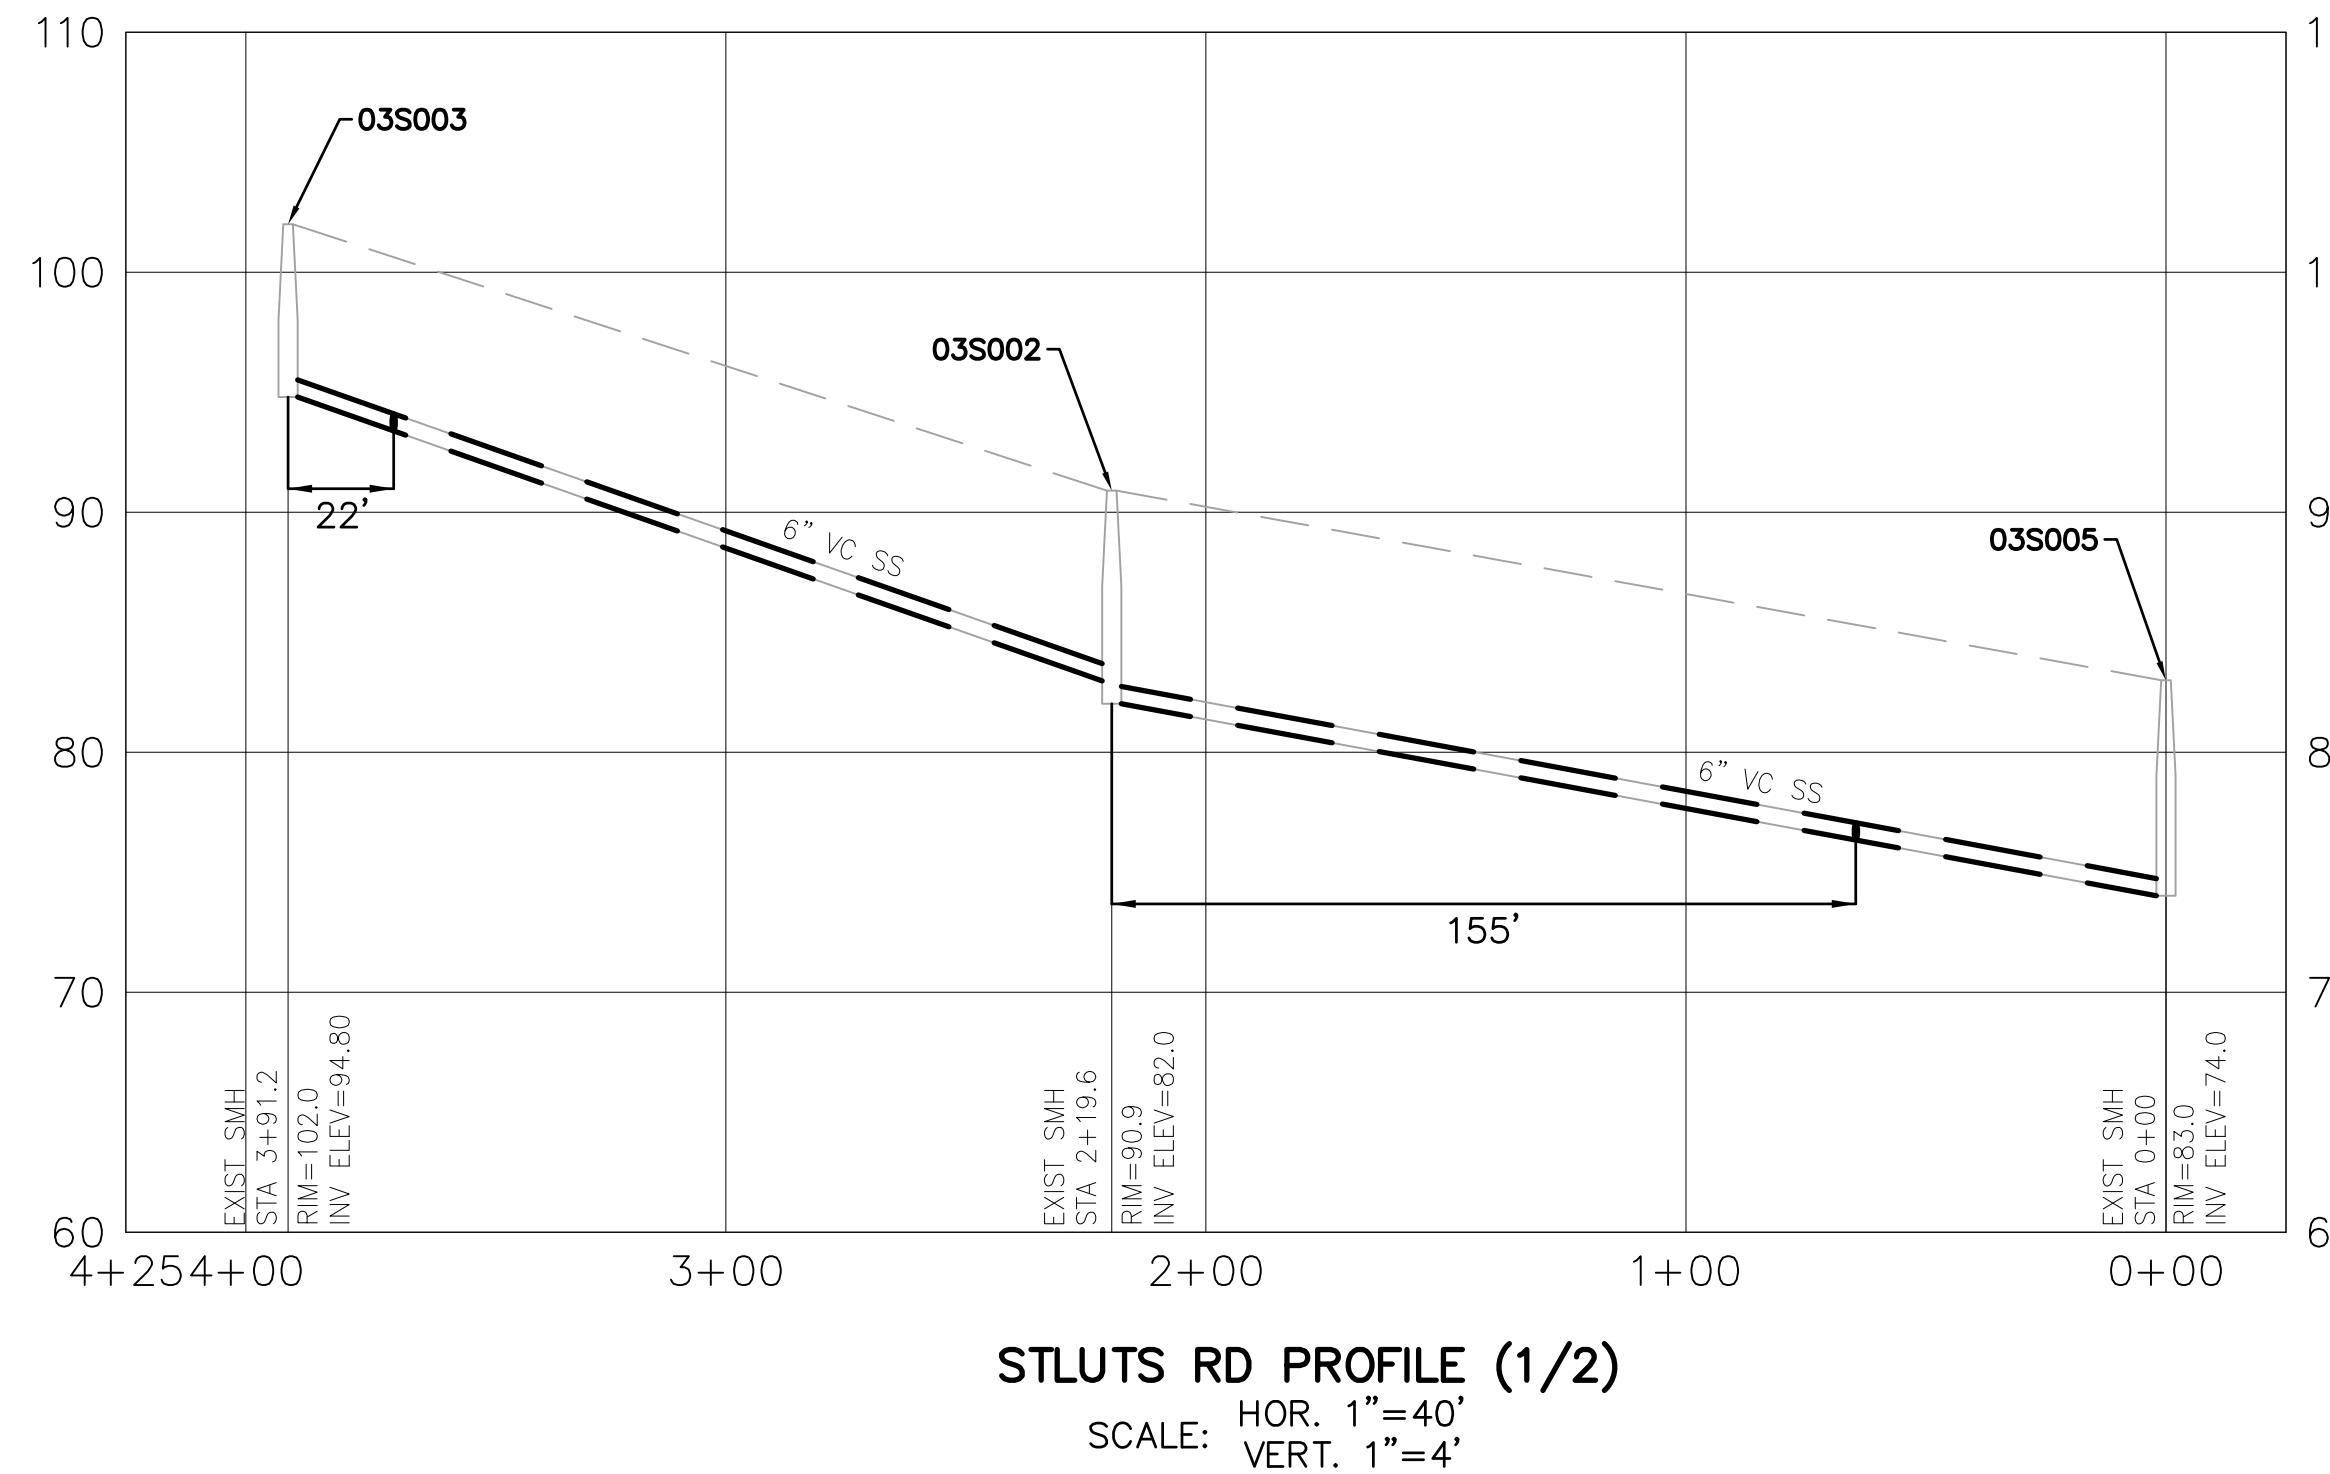
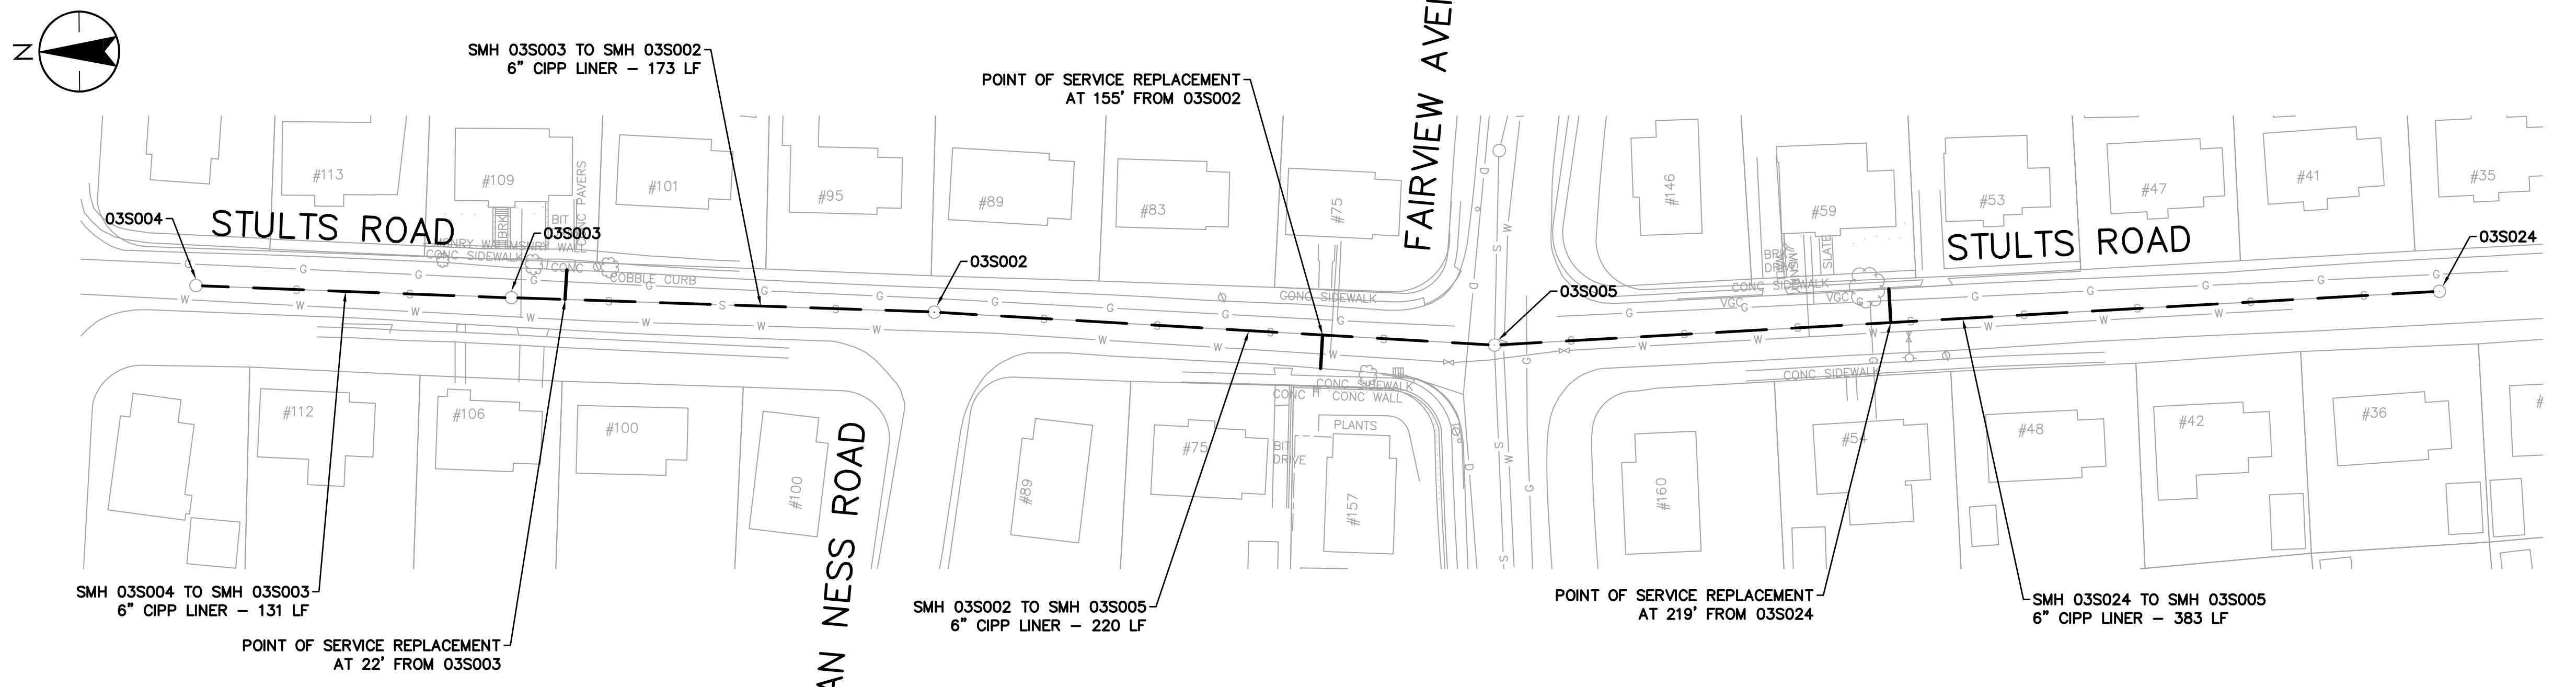
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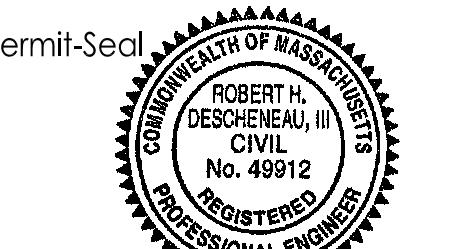
TOWN OF BELMONT, MASSACHUSETTS  
PRIVATE SECTOR SUMP PUMP REMOVAL &  
SEWER SYSTEM REHABILITATION  
  
MWRA PROJECT NO. WRA-P11-04-3-1124 &  
MWRA PROJECT NO. WRA-P-11-04-3-1160  
  
BELMONT, MASSACHUSETTS  
HILL CREST ROAD



Project Number:	195113362		
File Name:			
AMD	RHD	RPB	21.03.31
Dwn.	Chkd.	Dsgn.	YY.MM.DD
Drawing No.		C-115	
Revision	Sheet		
0	19 of		

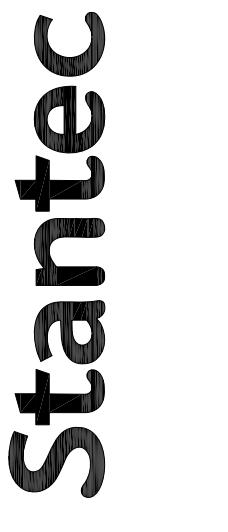

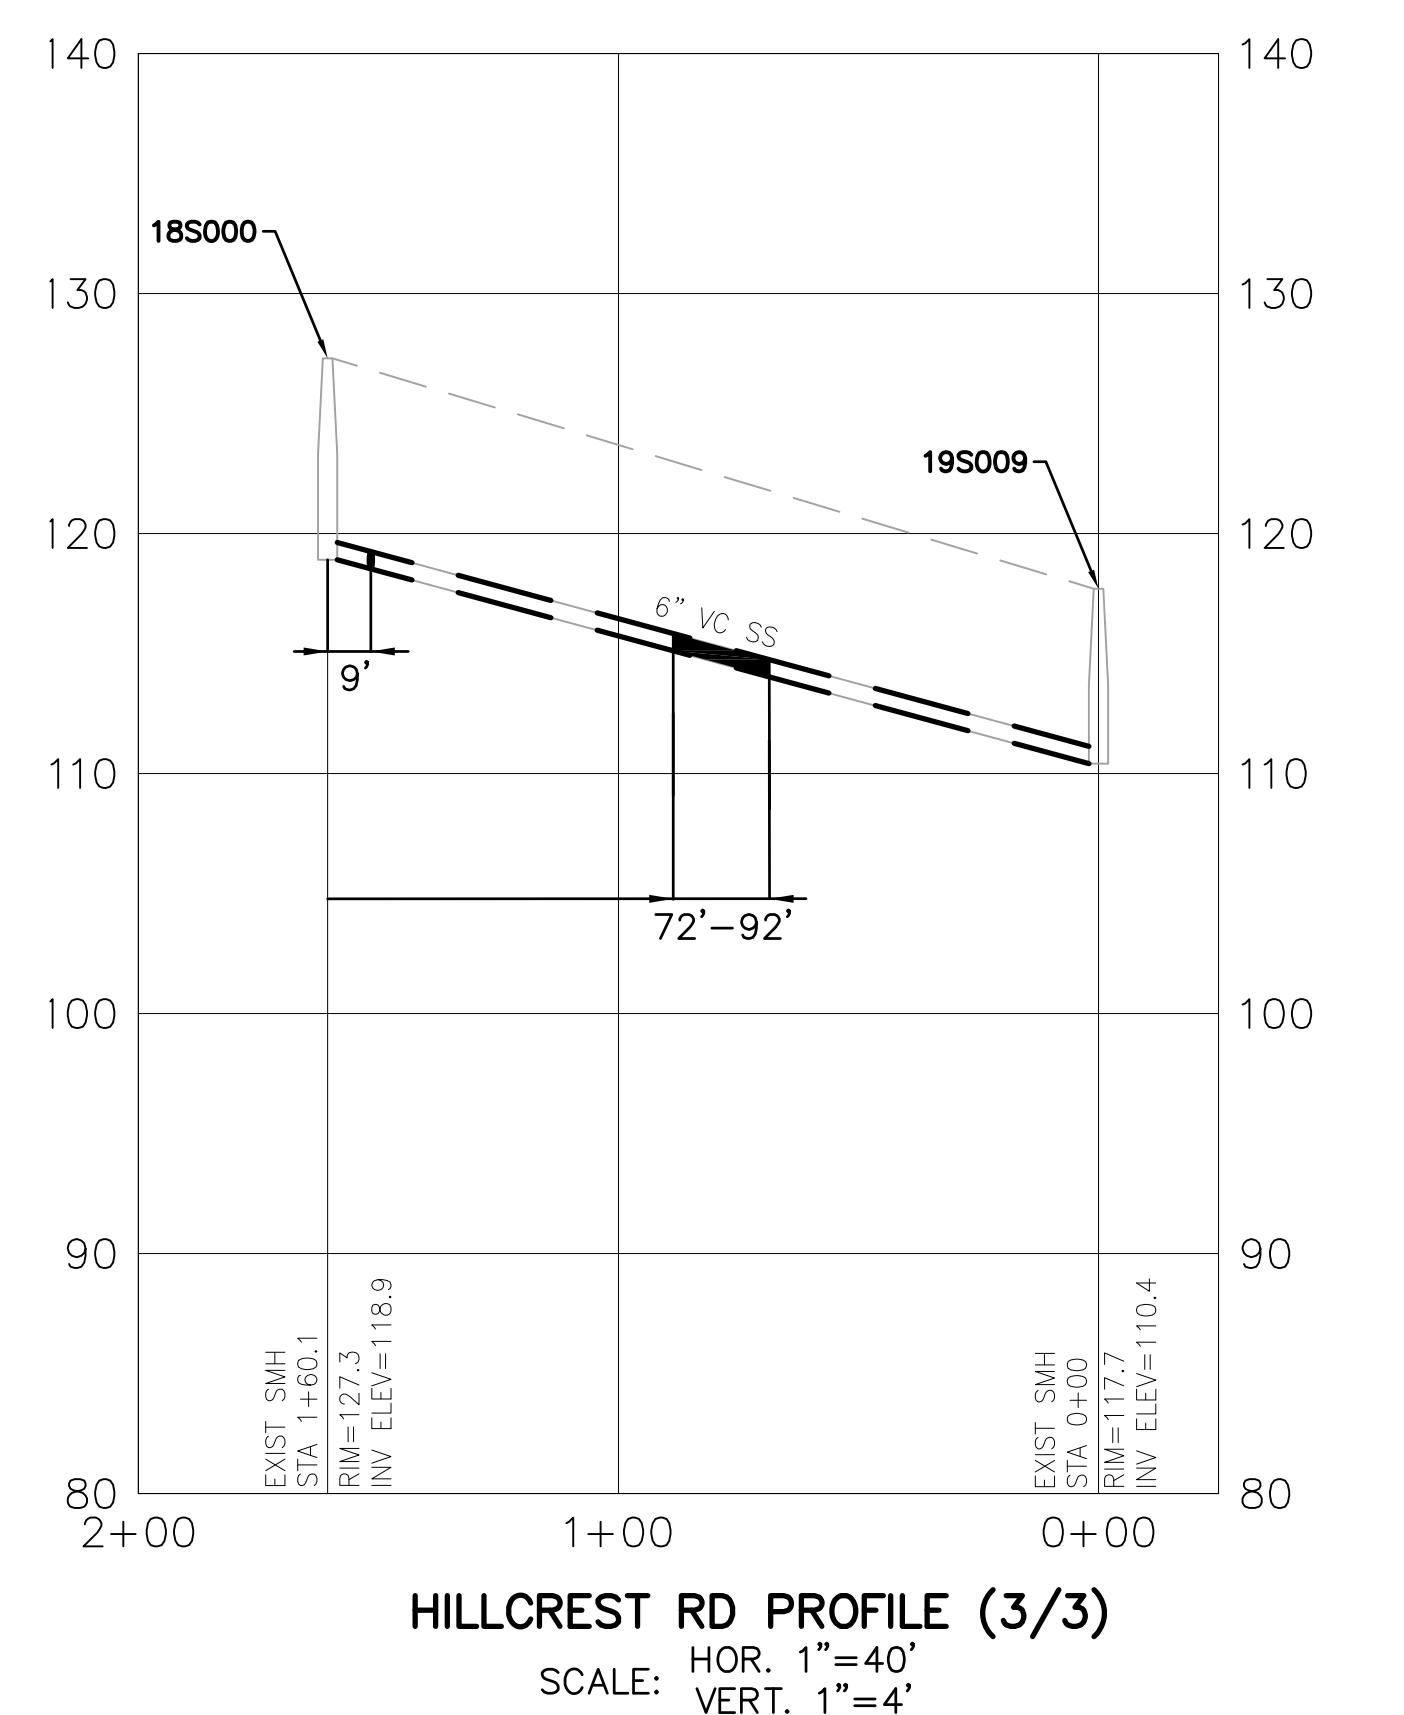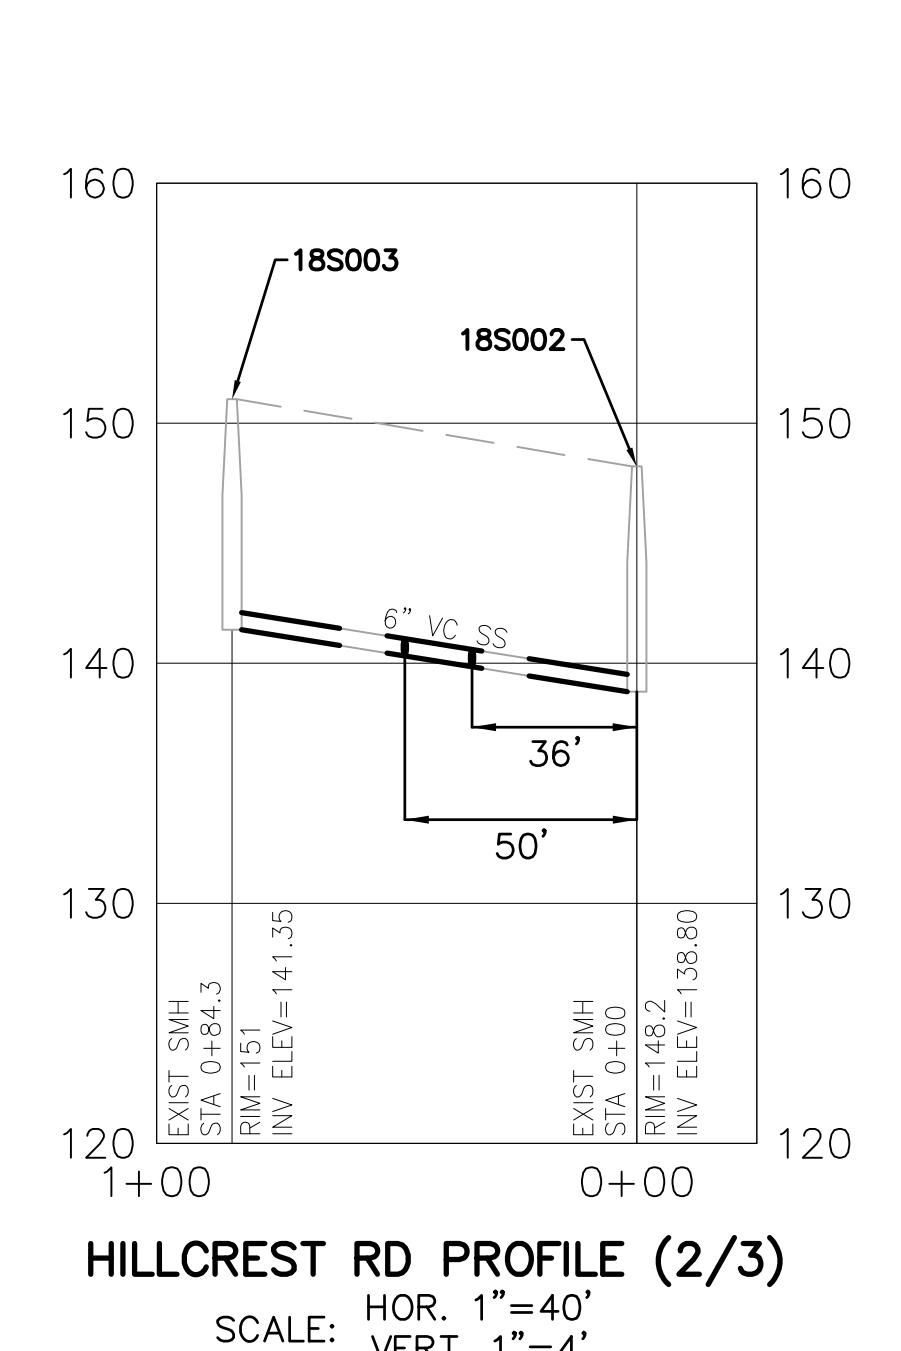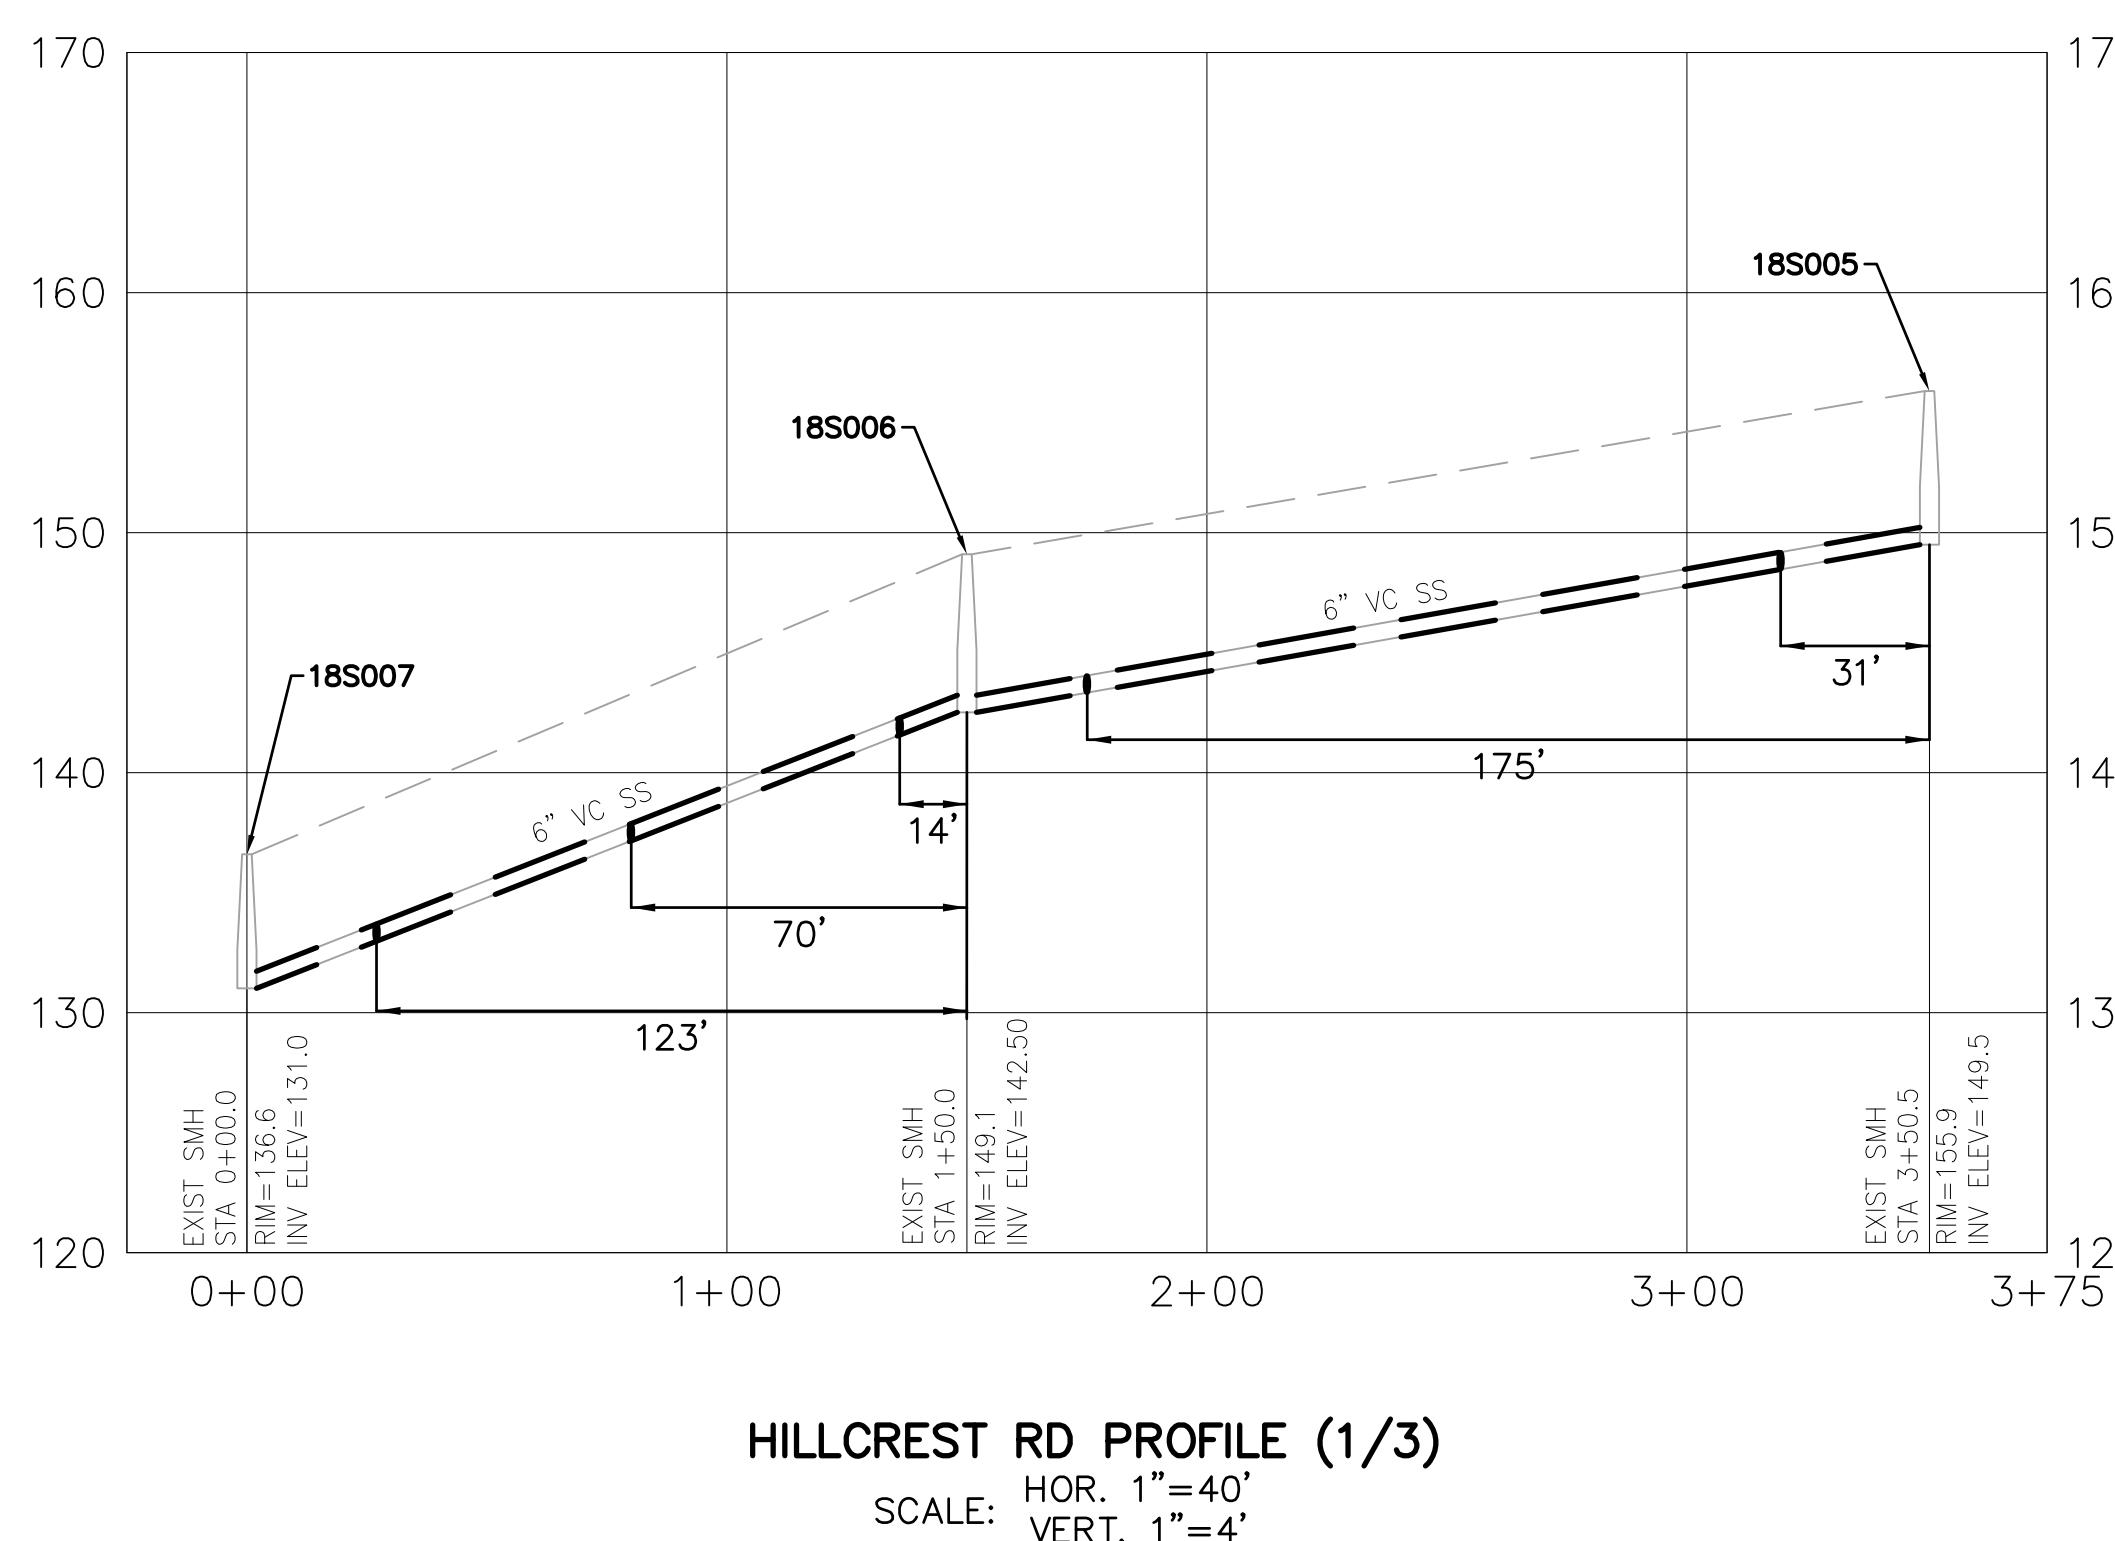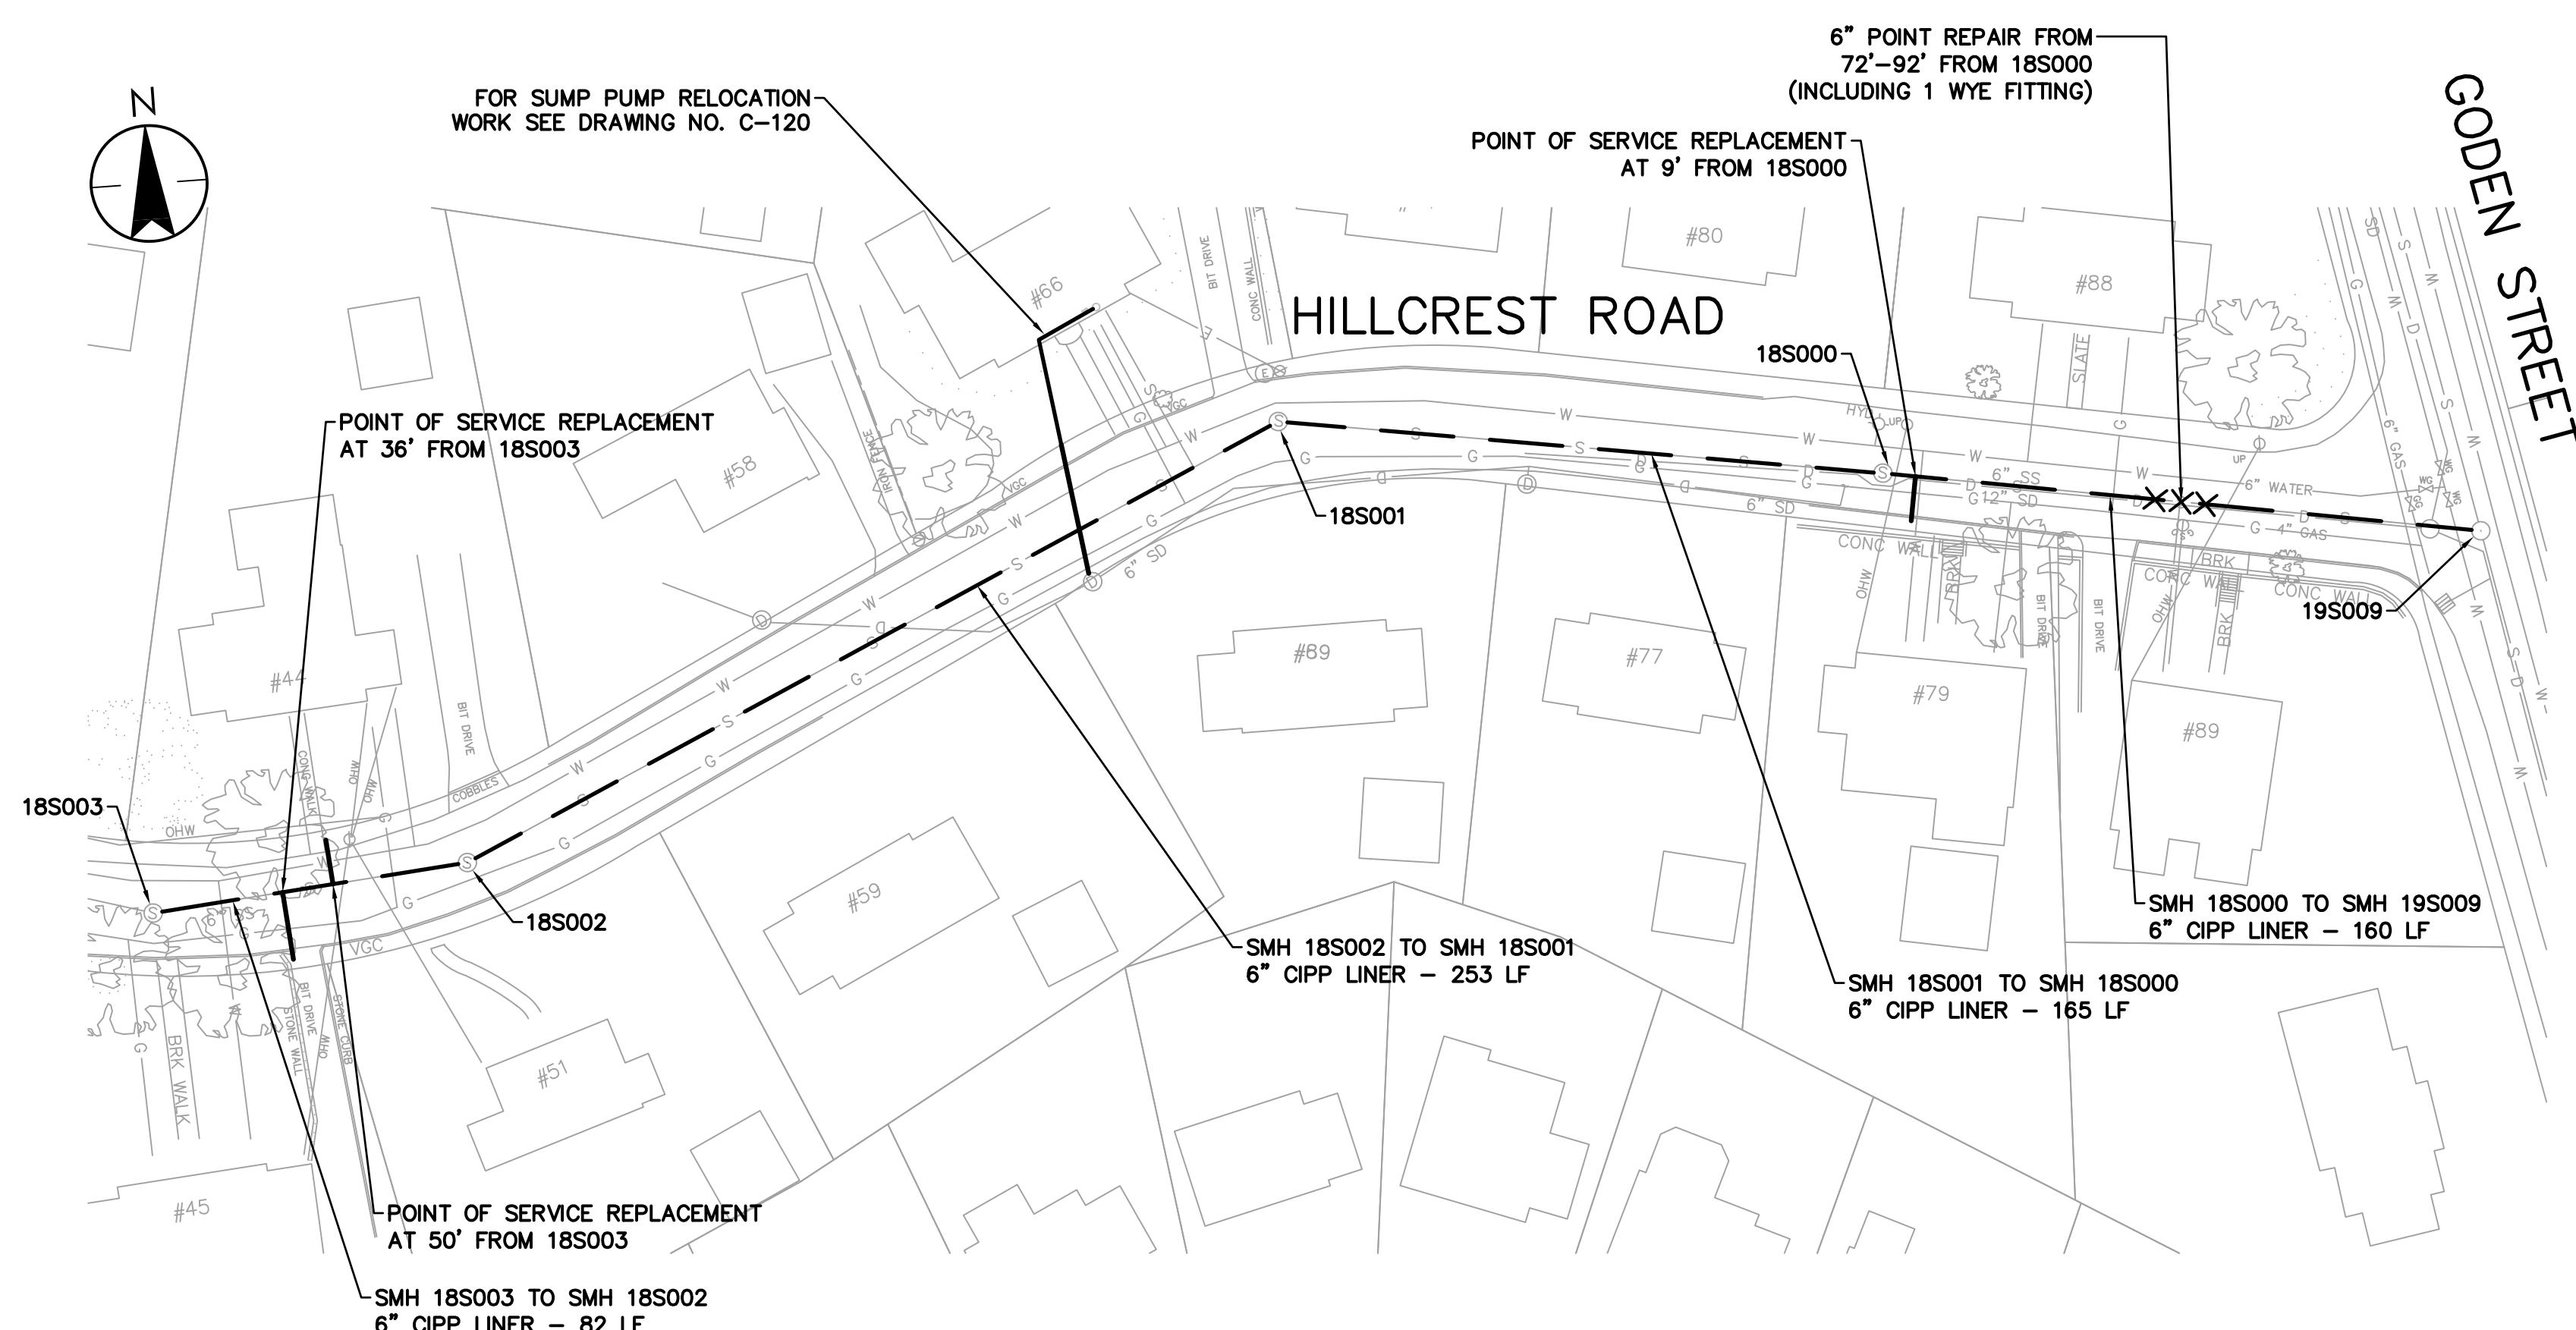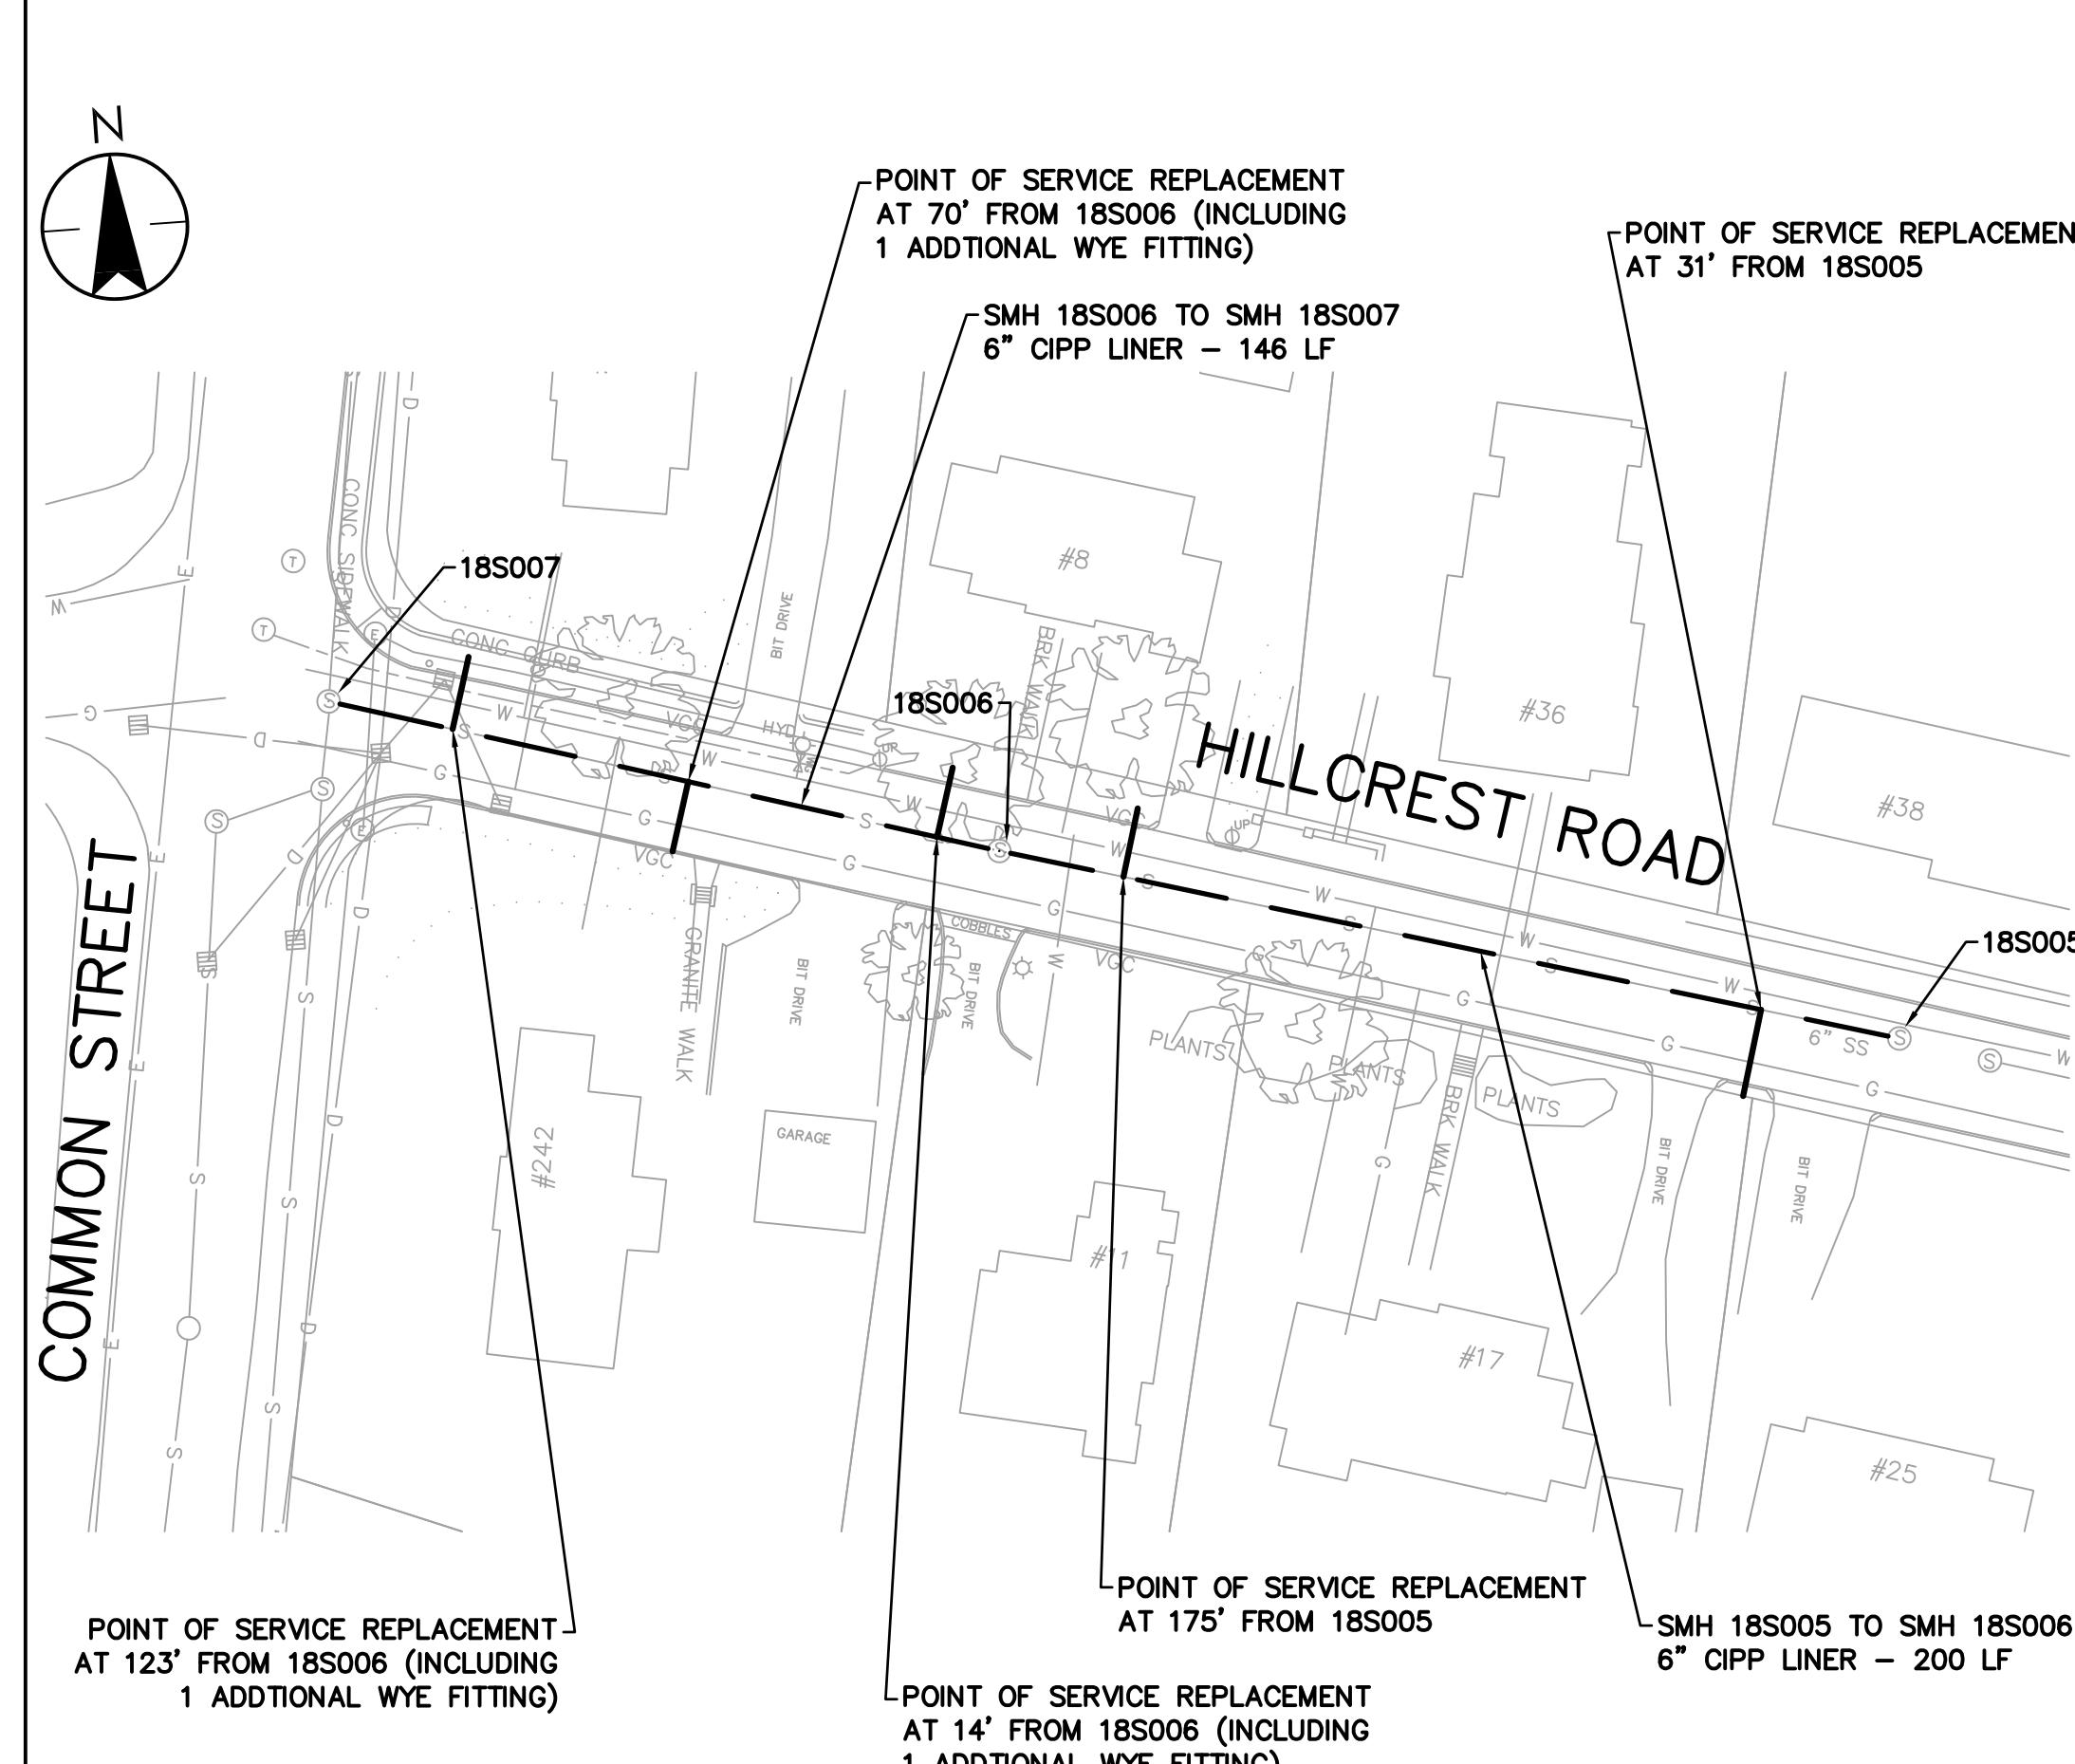TOWN OF BELMONT, MASSACHUSETTS  
PRIVATE SECTOR SUMP PUMP REMOVAL &  
SEWER SYSTEM REHABILITATION  
MWRA PROJECT NO. WRA-P11-04-3-1124 &  
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BELMONT, MASSACHUSETTS

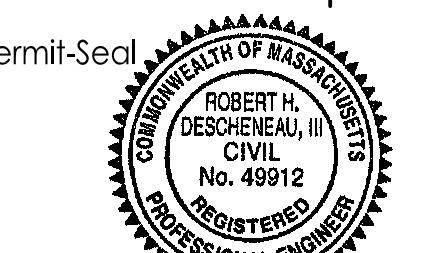


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AMD RHD RPB 21.03.31  
Dwn. Chkd. Disp. YY.MM.DD  
Drawing No. C-116

Revision Sheet

0 20 of

TOWN OF BELMONT, MASSACHUSETTS  
PRIVATE SECTOR SUMP PUMP REMOVAL &  
SEWER SYSTEM REHABILITATION  
MWRA PROJECT NO. WRA-P11-04-3-1124 &  
MWRA PROJECT NO. WRA-P11-04-3-1160  
BELMONT, MASSACHUSETTS  
TOWNSEND ROAD AND PAYSON ROAD

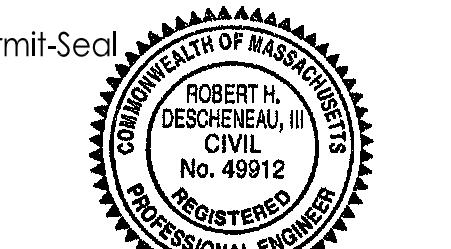

Project Number: 195113362

File Name:


AMD RHD RPB 21.03.31




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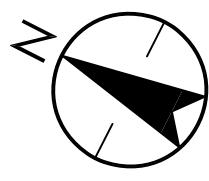
Drawing No. C-117

Revision Sheet

0 21 of



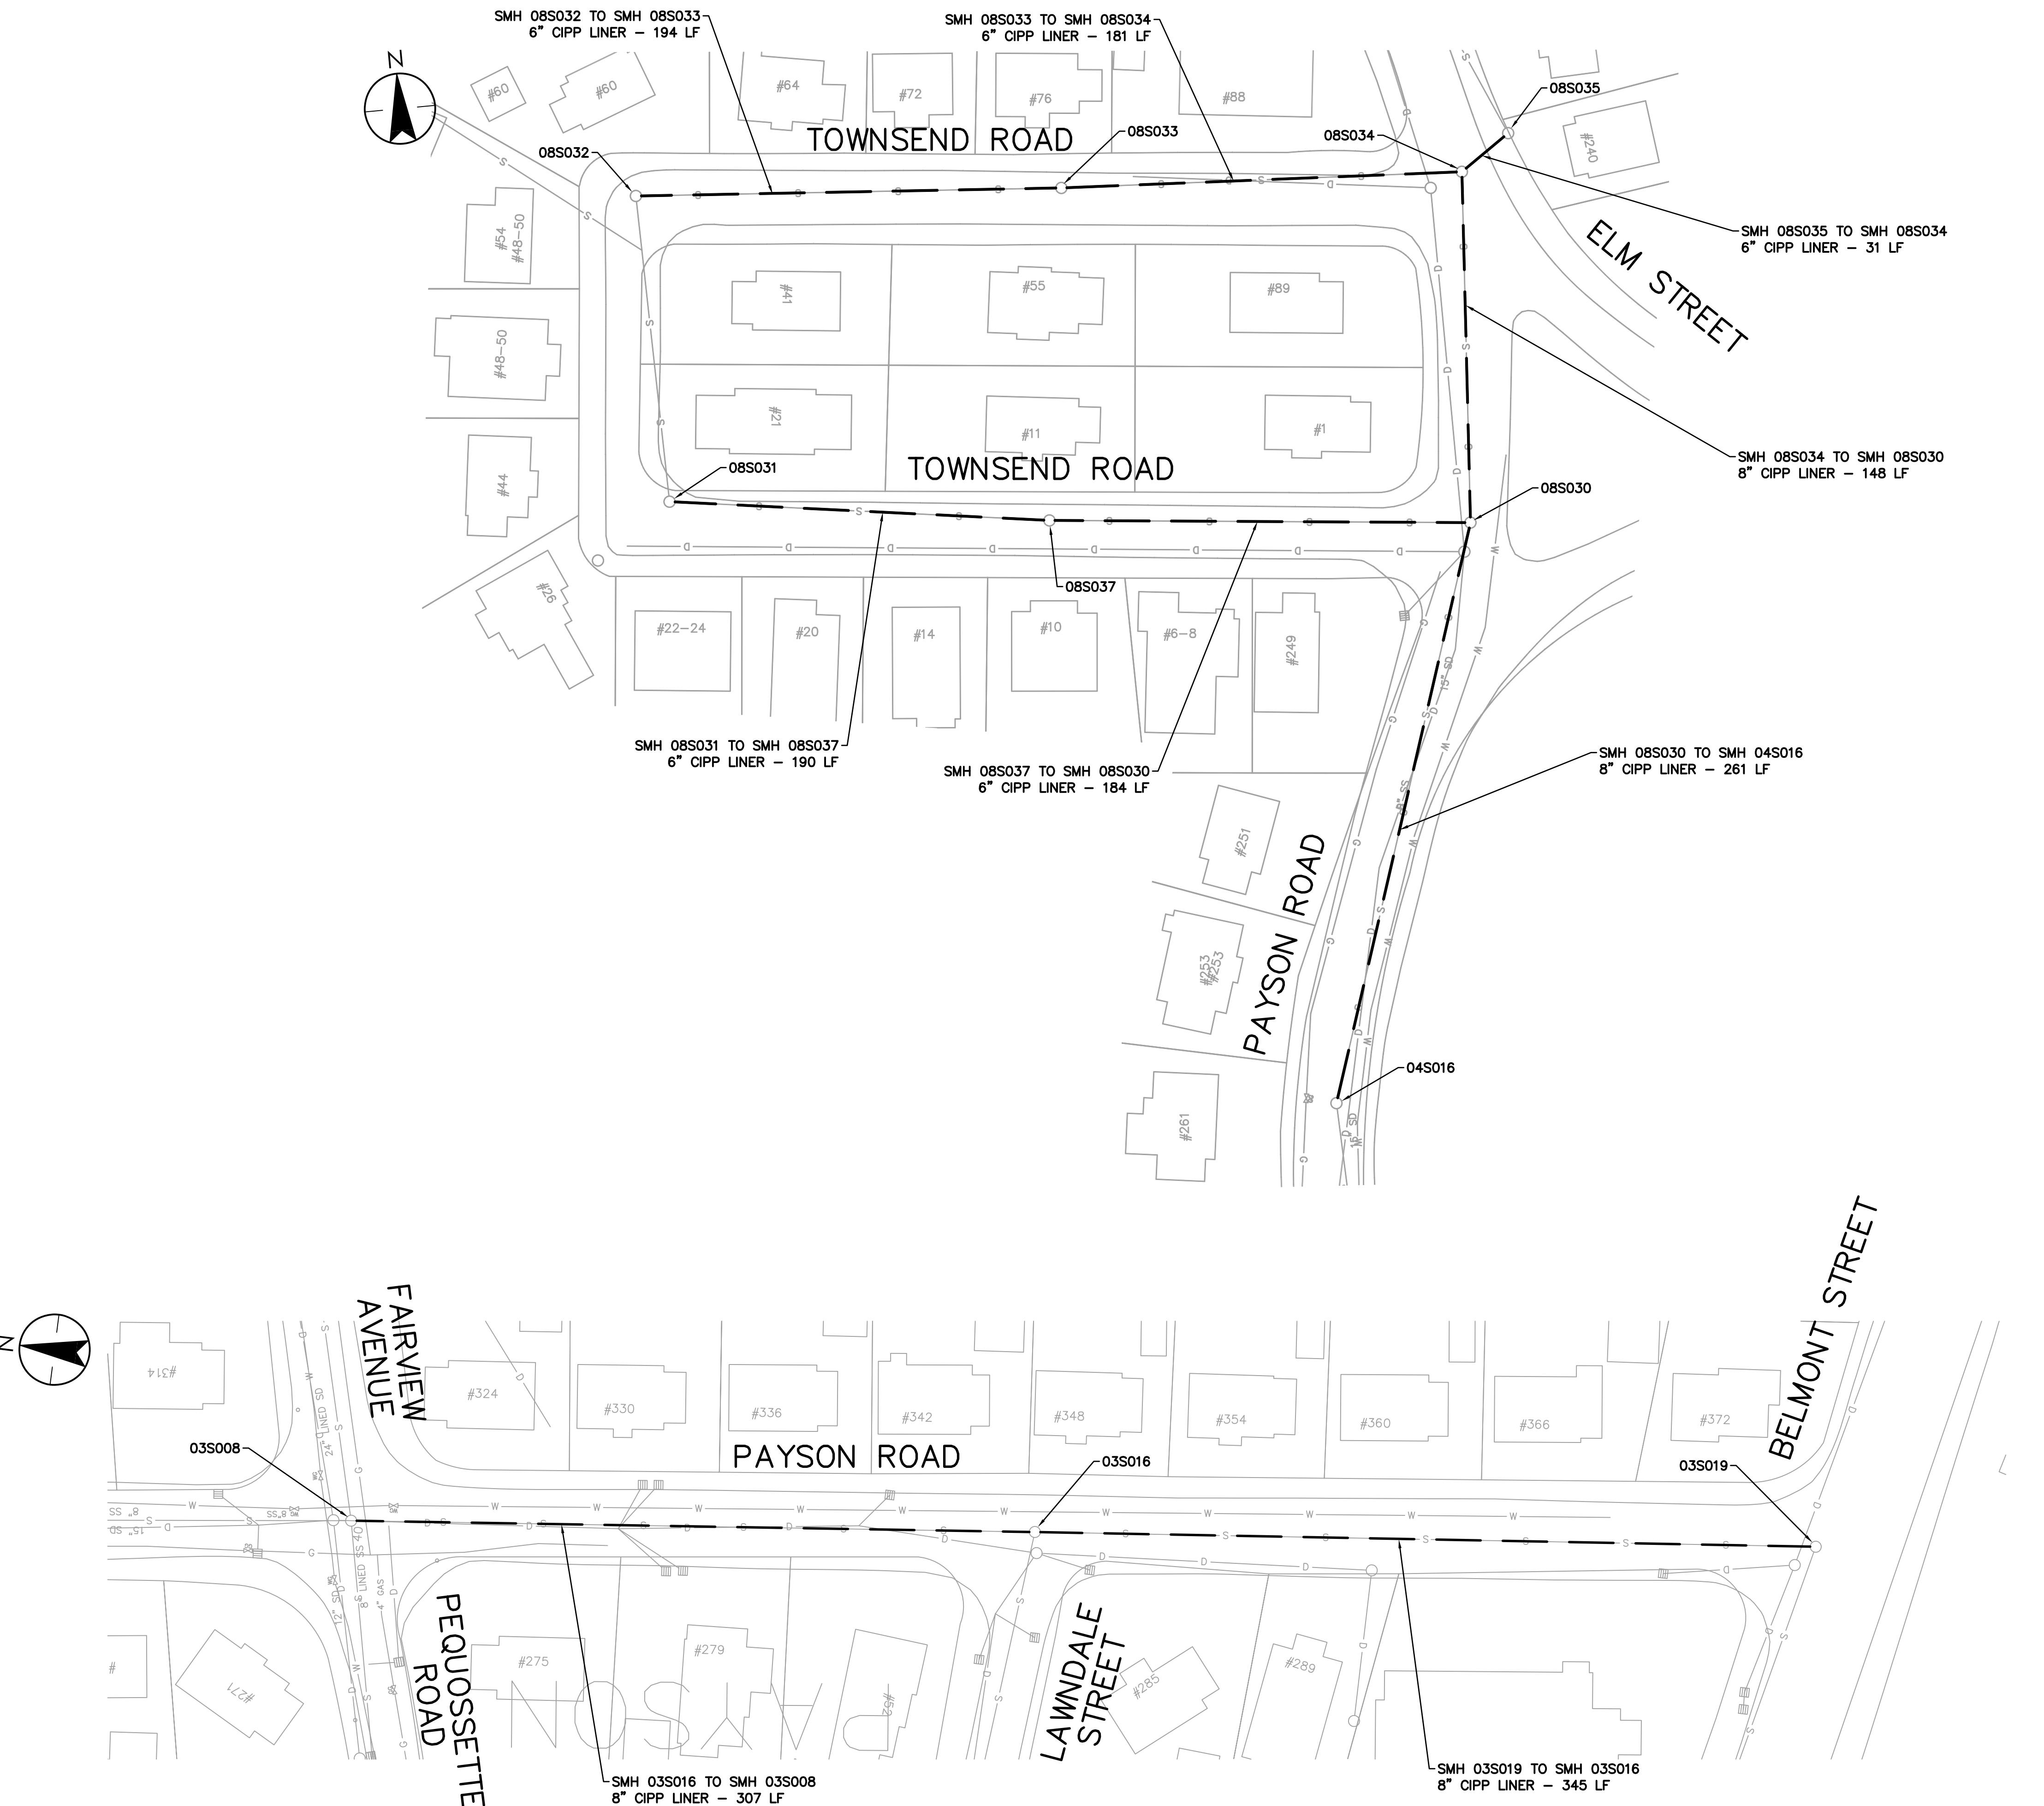

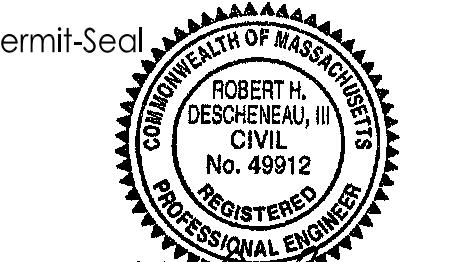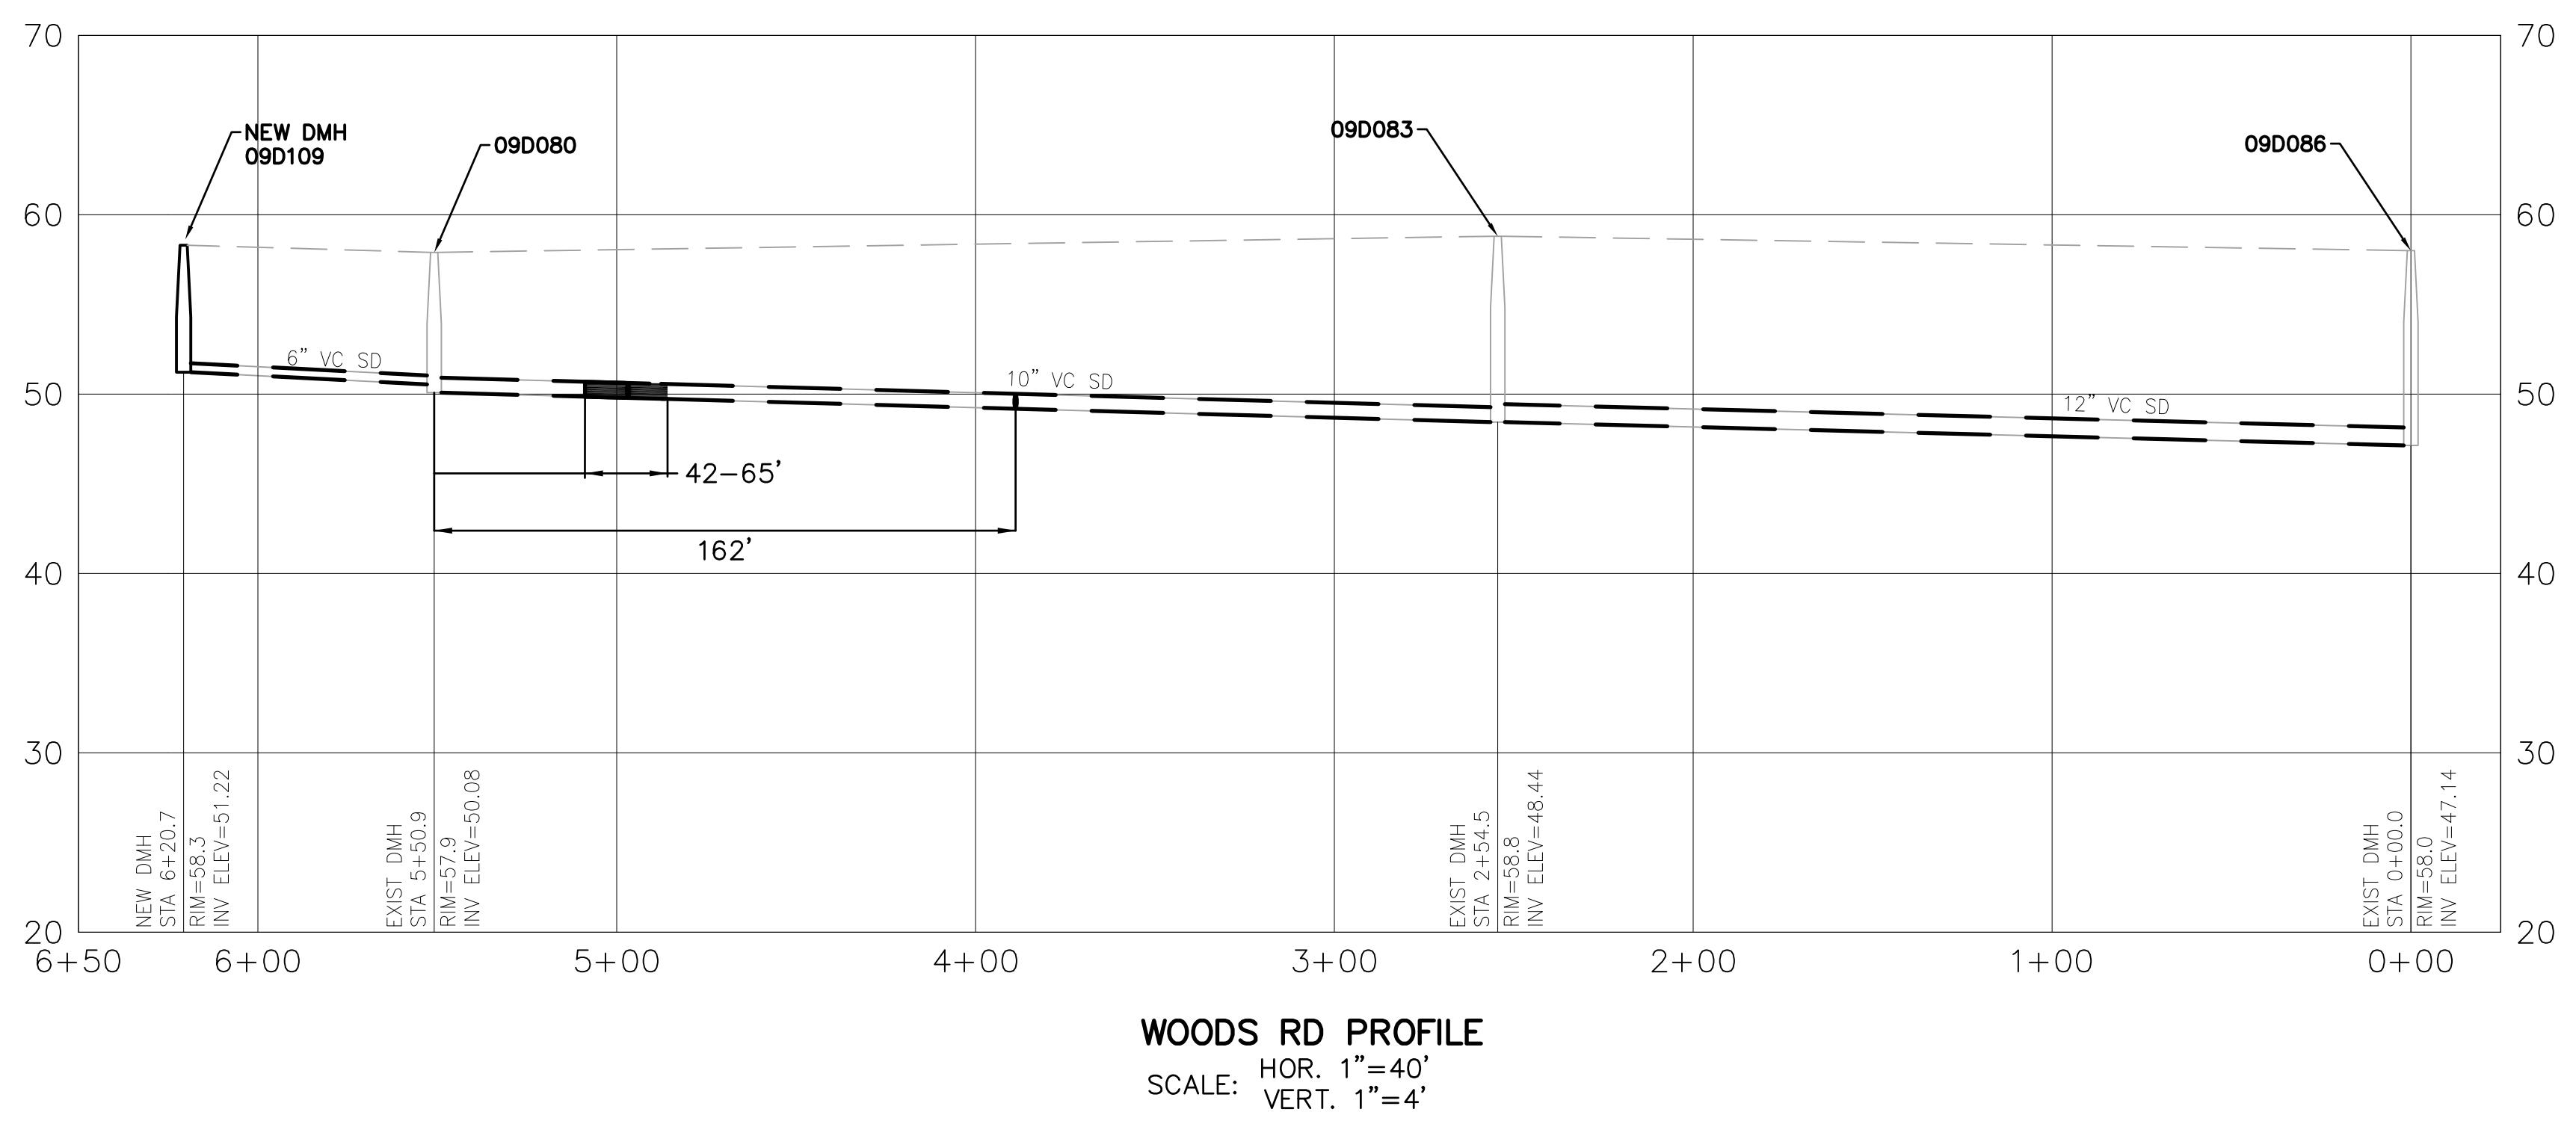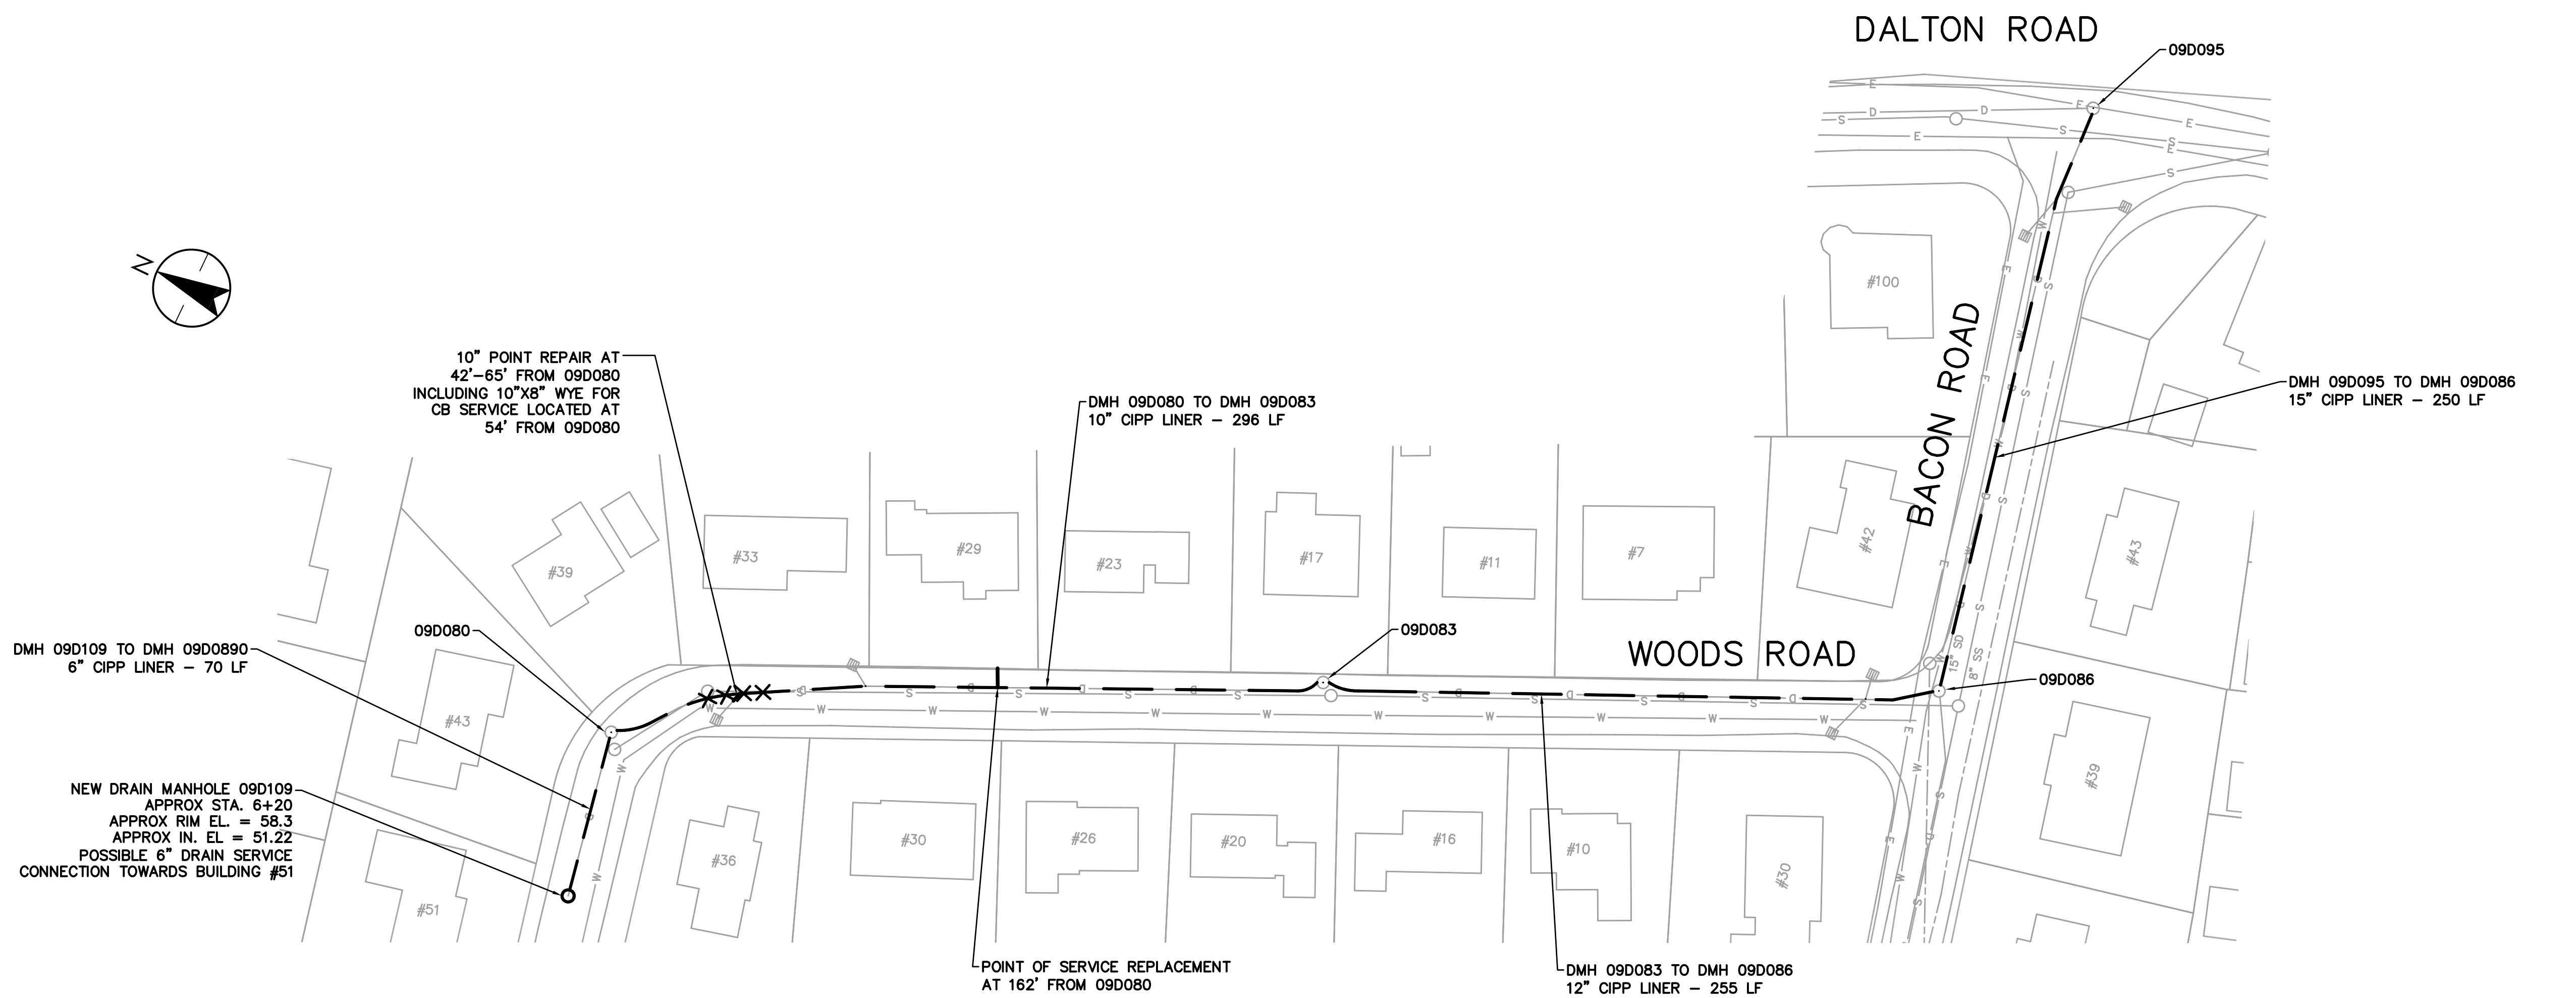

**LIVERMORE ROAD**

**BETTS ROAD**

**DALTON ROAD**

**GROSVENOR ROAD**

#47

#50

#49

#151

#145

#139

#133

#127

#45

#54

#61

#58

#146

#140

#134

#130

#124

#118

#112

09D041

09D003

09D009

E

S

D


W

M

WG

DMH 09D041 TO DMH 09D003  
24" CIPP LINER - 227 LF

DMH 09D003 TO DMH 09D006  
24" CIPP LINER - 511 LF

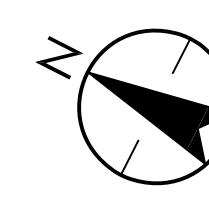


**BETTS ROAD**

**ANIS ROAD**

**GROSVENOR ROAD**

**NEW DRAIN MANHOLE 09D110**  
APPROX STA. 1+95  
APPROX RIM EL. = 56.0  
APPROX IN. EL = 47.74

**SMH 09S009 TO SMH 09S010**  
8" CIPP LINER - 254 LF

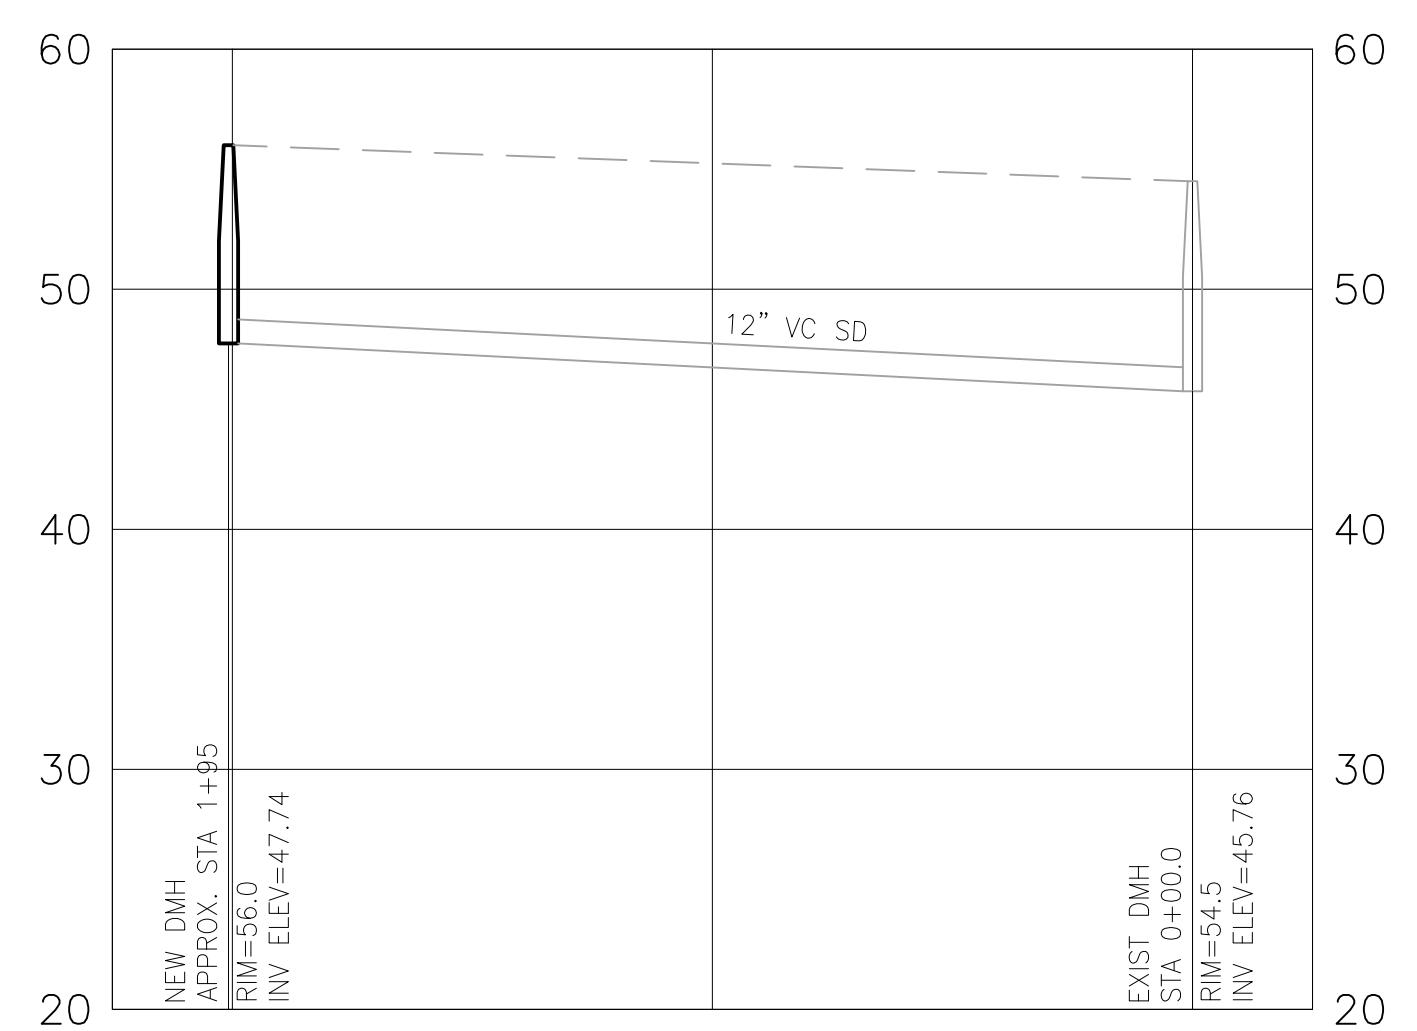

**ANIS RD PROFILE**

V:\1951\active\195113342\5\_design Sump Pump Removal\civil\drawings\cv\l(C-119 DALTON RD.dwg  
2021/03/29 11:26 AM By: DiCecca, Alicia

PRIVATE SECTOR SUMP PUMP REMOVAL &  
SEWER SYSTEM REHABILITATION

MWRA PROJECT NO. WRA-P11-04-3-1124 &  
MWRA PROJECT NO. WRA-P-11-04-3-1160

BELMONT, MASSACHUSETTS

---

DALTON ROAD AND ANIS ROAD

A circular seal with a serrated outer edge. The words "NOTARY PUBLIC" are at the top, "COMMONWEALTH OF MASSACHUSETTS" are in the center, and "REGISTERED" is at the bottom. The name "ROBERT H. DESCHENEAU, III" is in the middle, and "CIVIL No. 49912" is at the bottom.

Object Number: 195113362

Name: \_\_\_\_\_

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MD RHD RPR 21.03





MD	RHD	RFB	
wn.	Chkd.	Dsgn.	YY.MM

rawing No. C-119


## revision Sheet

0 23 of

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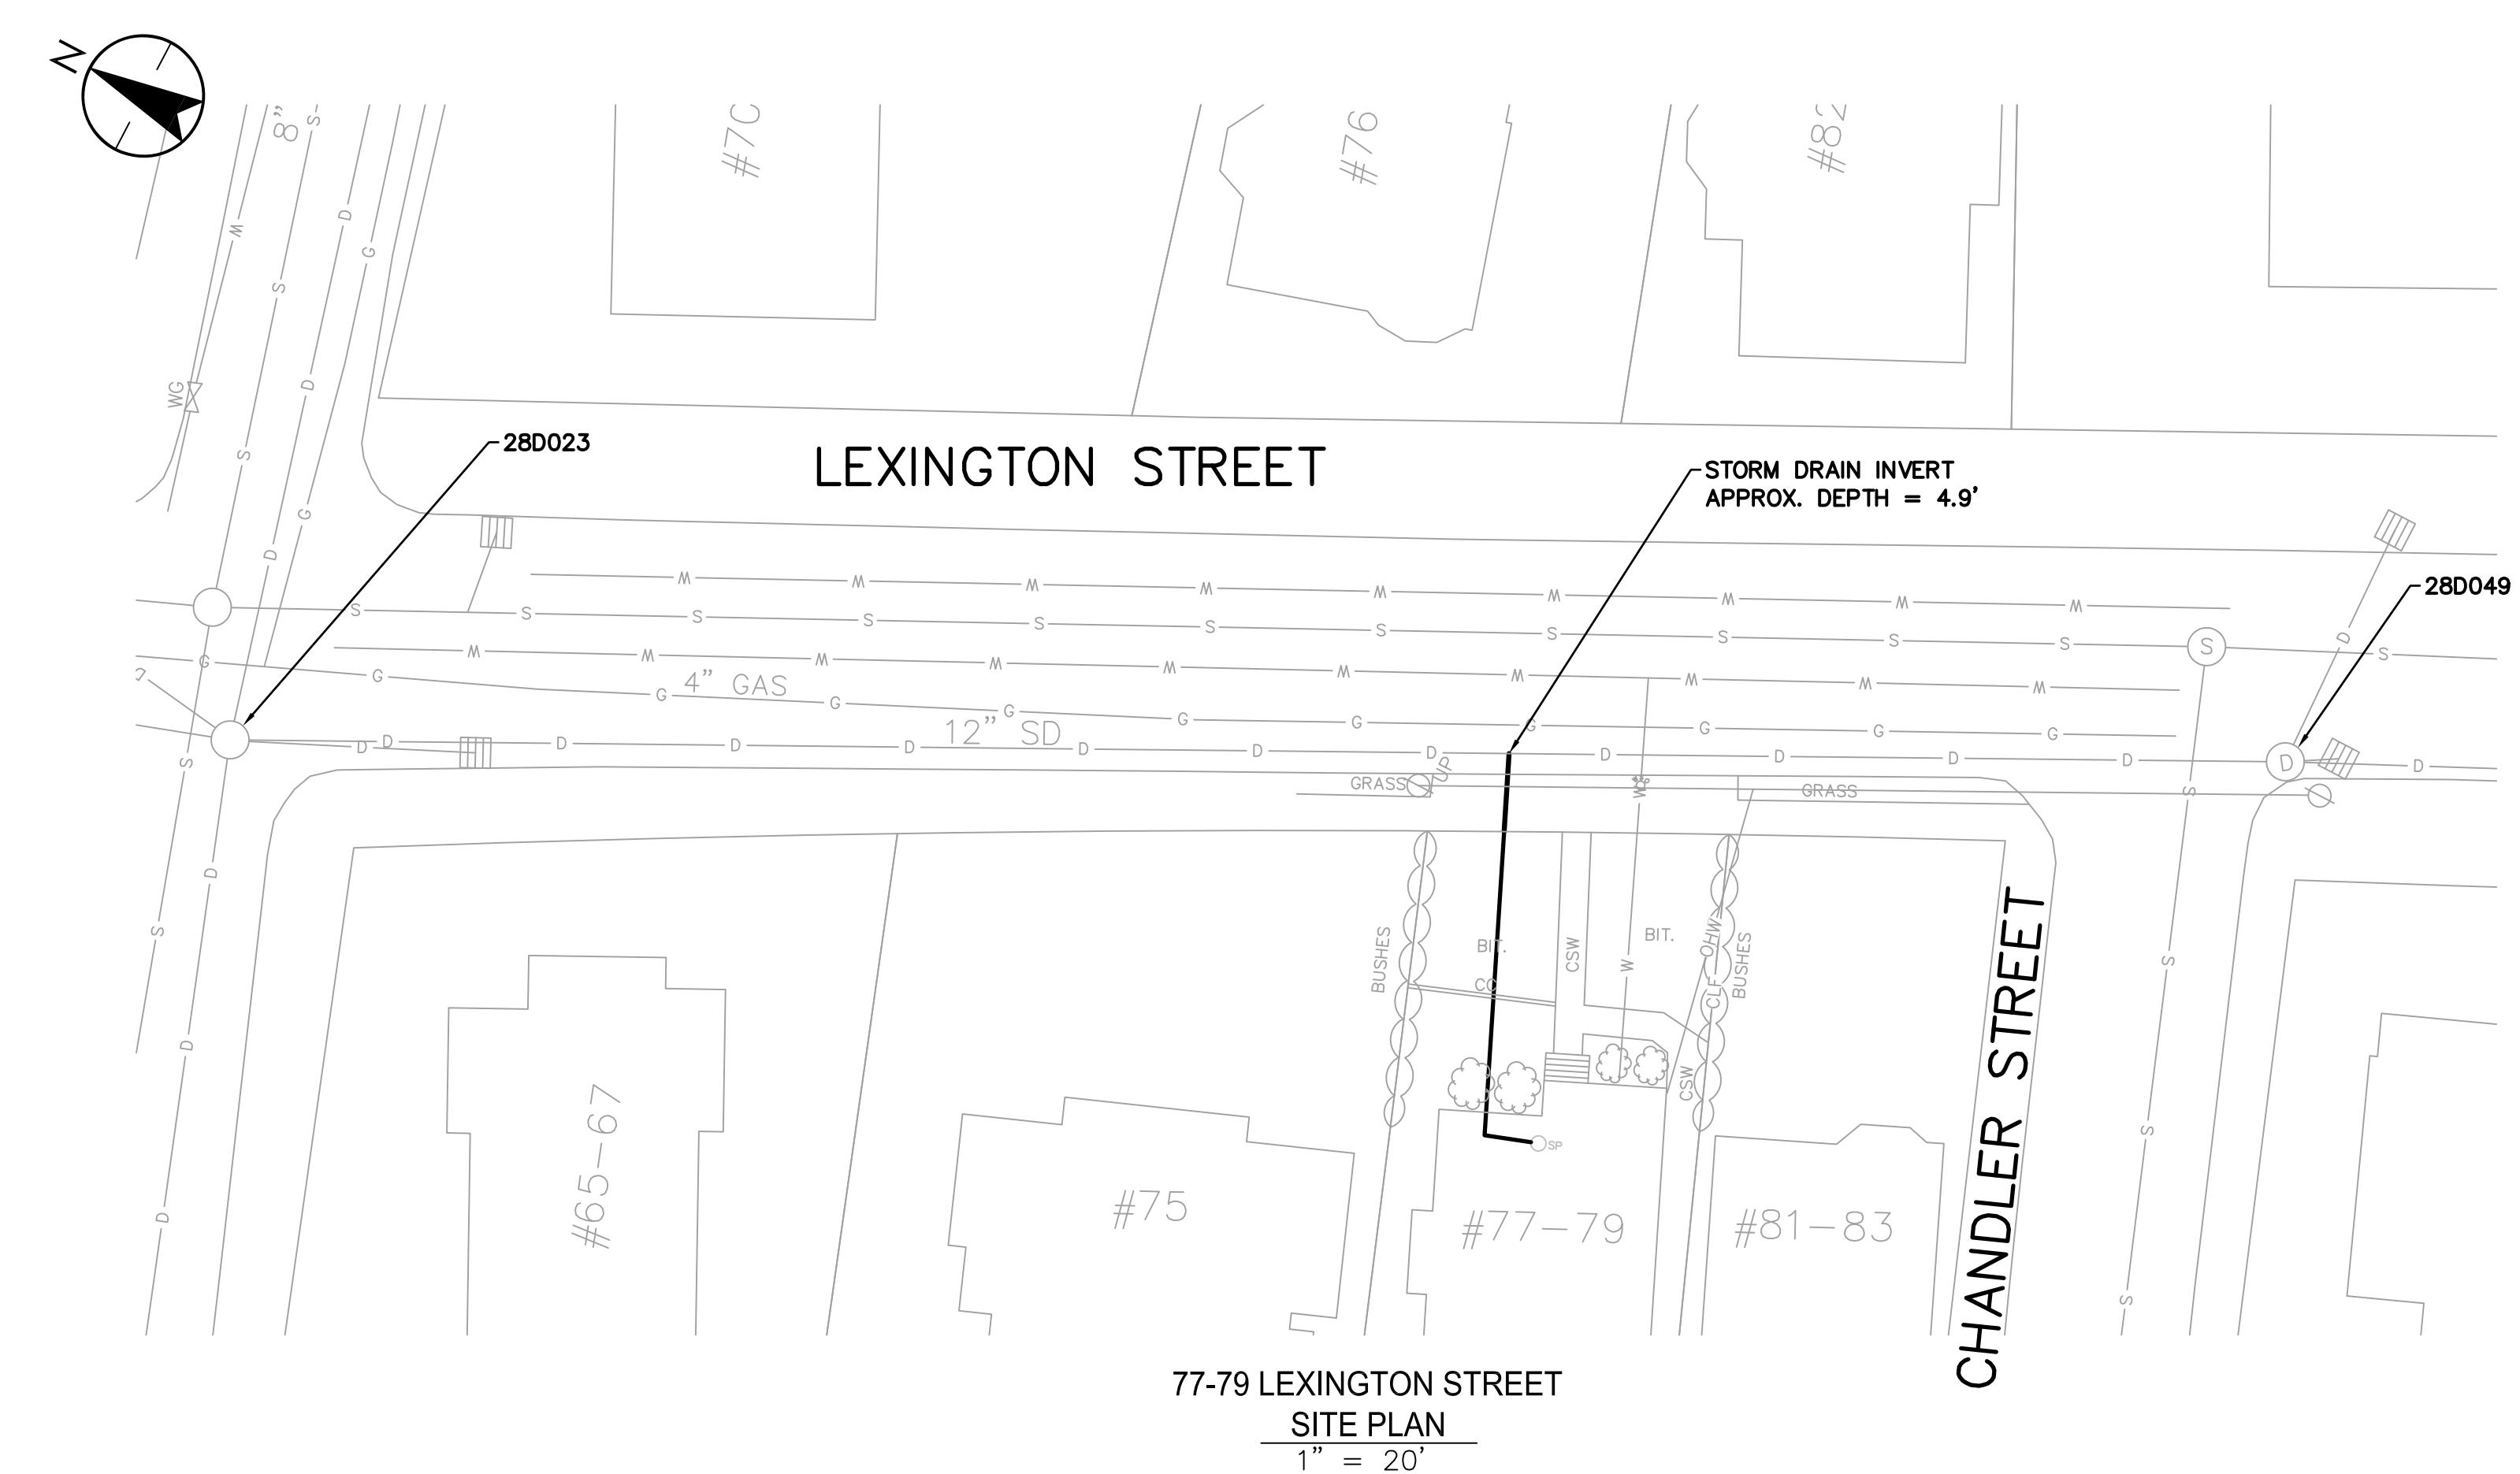
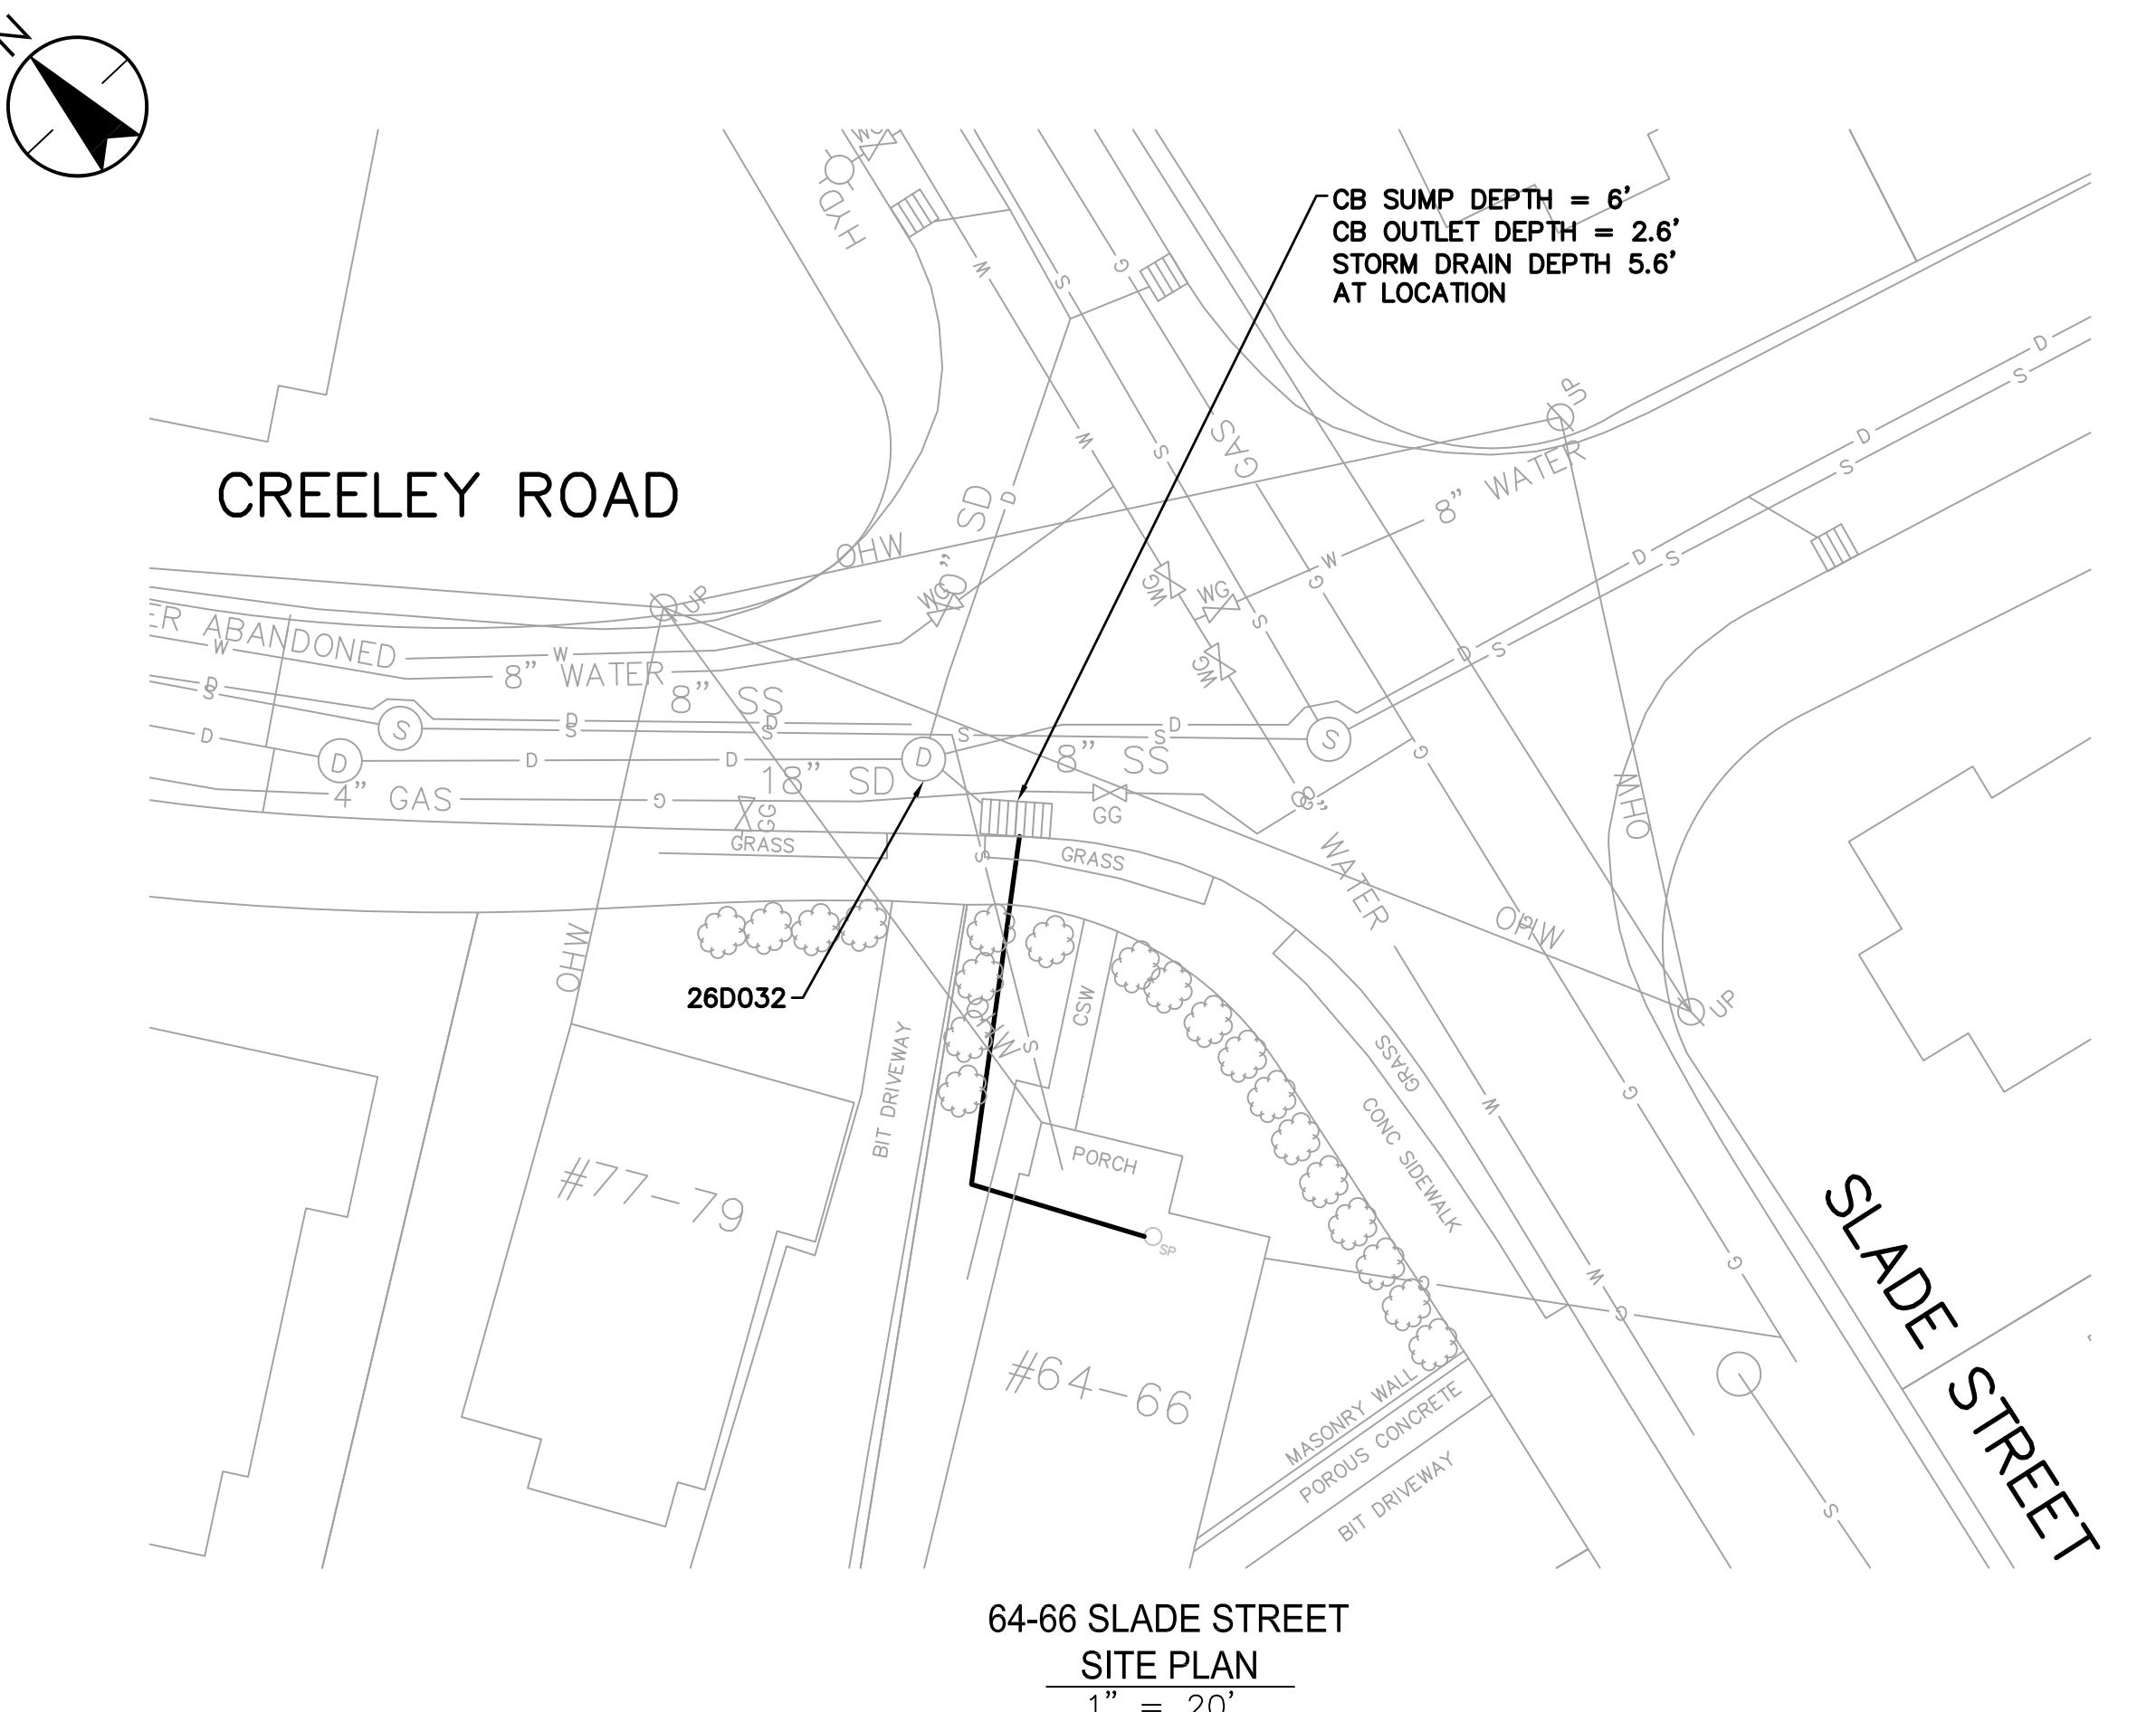
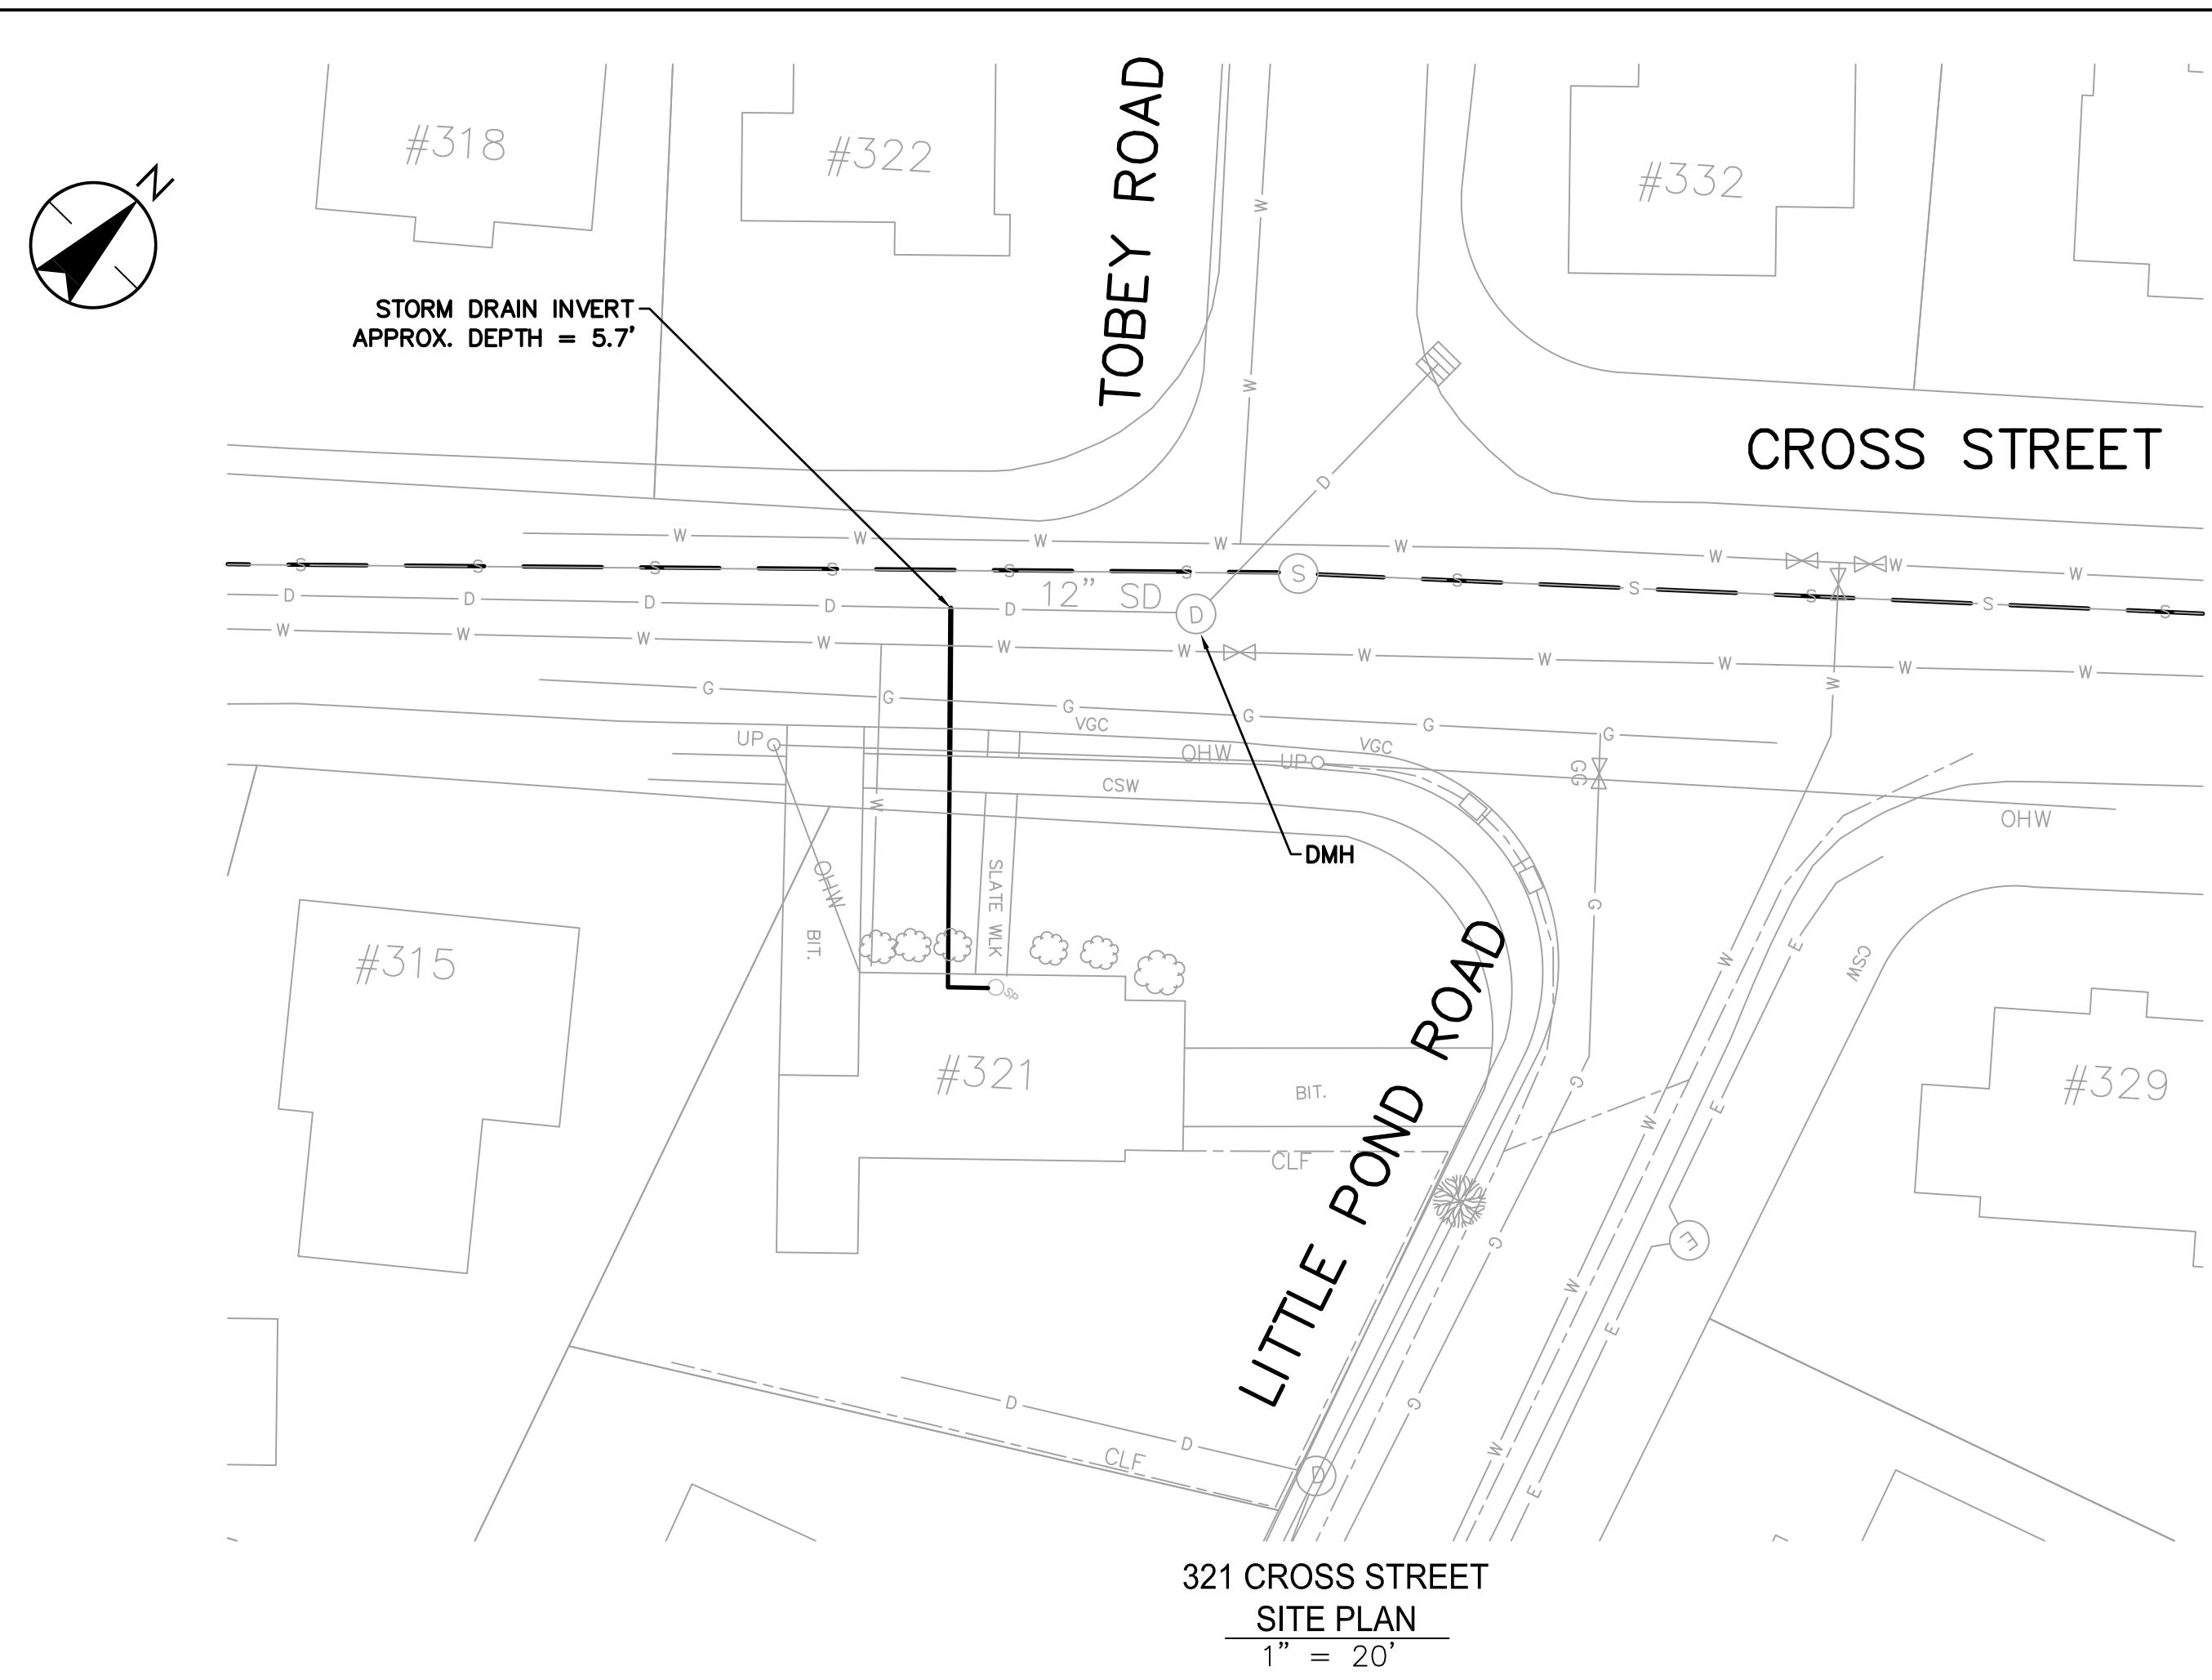


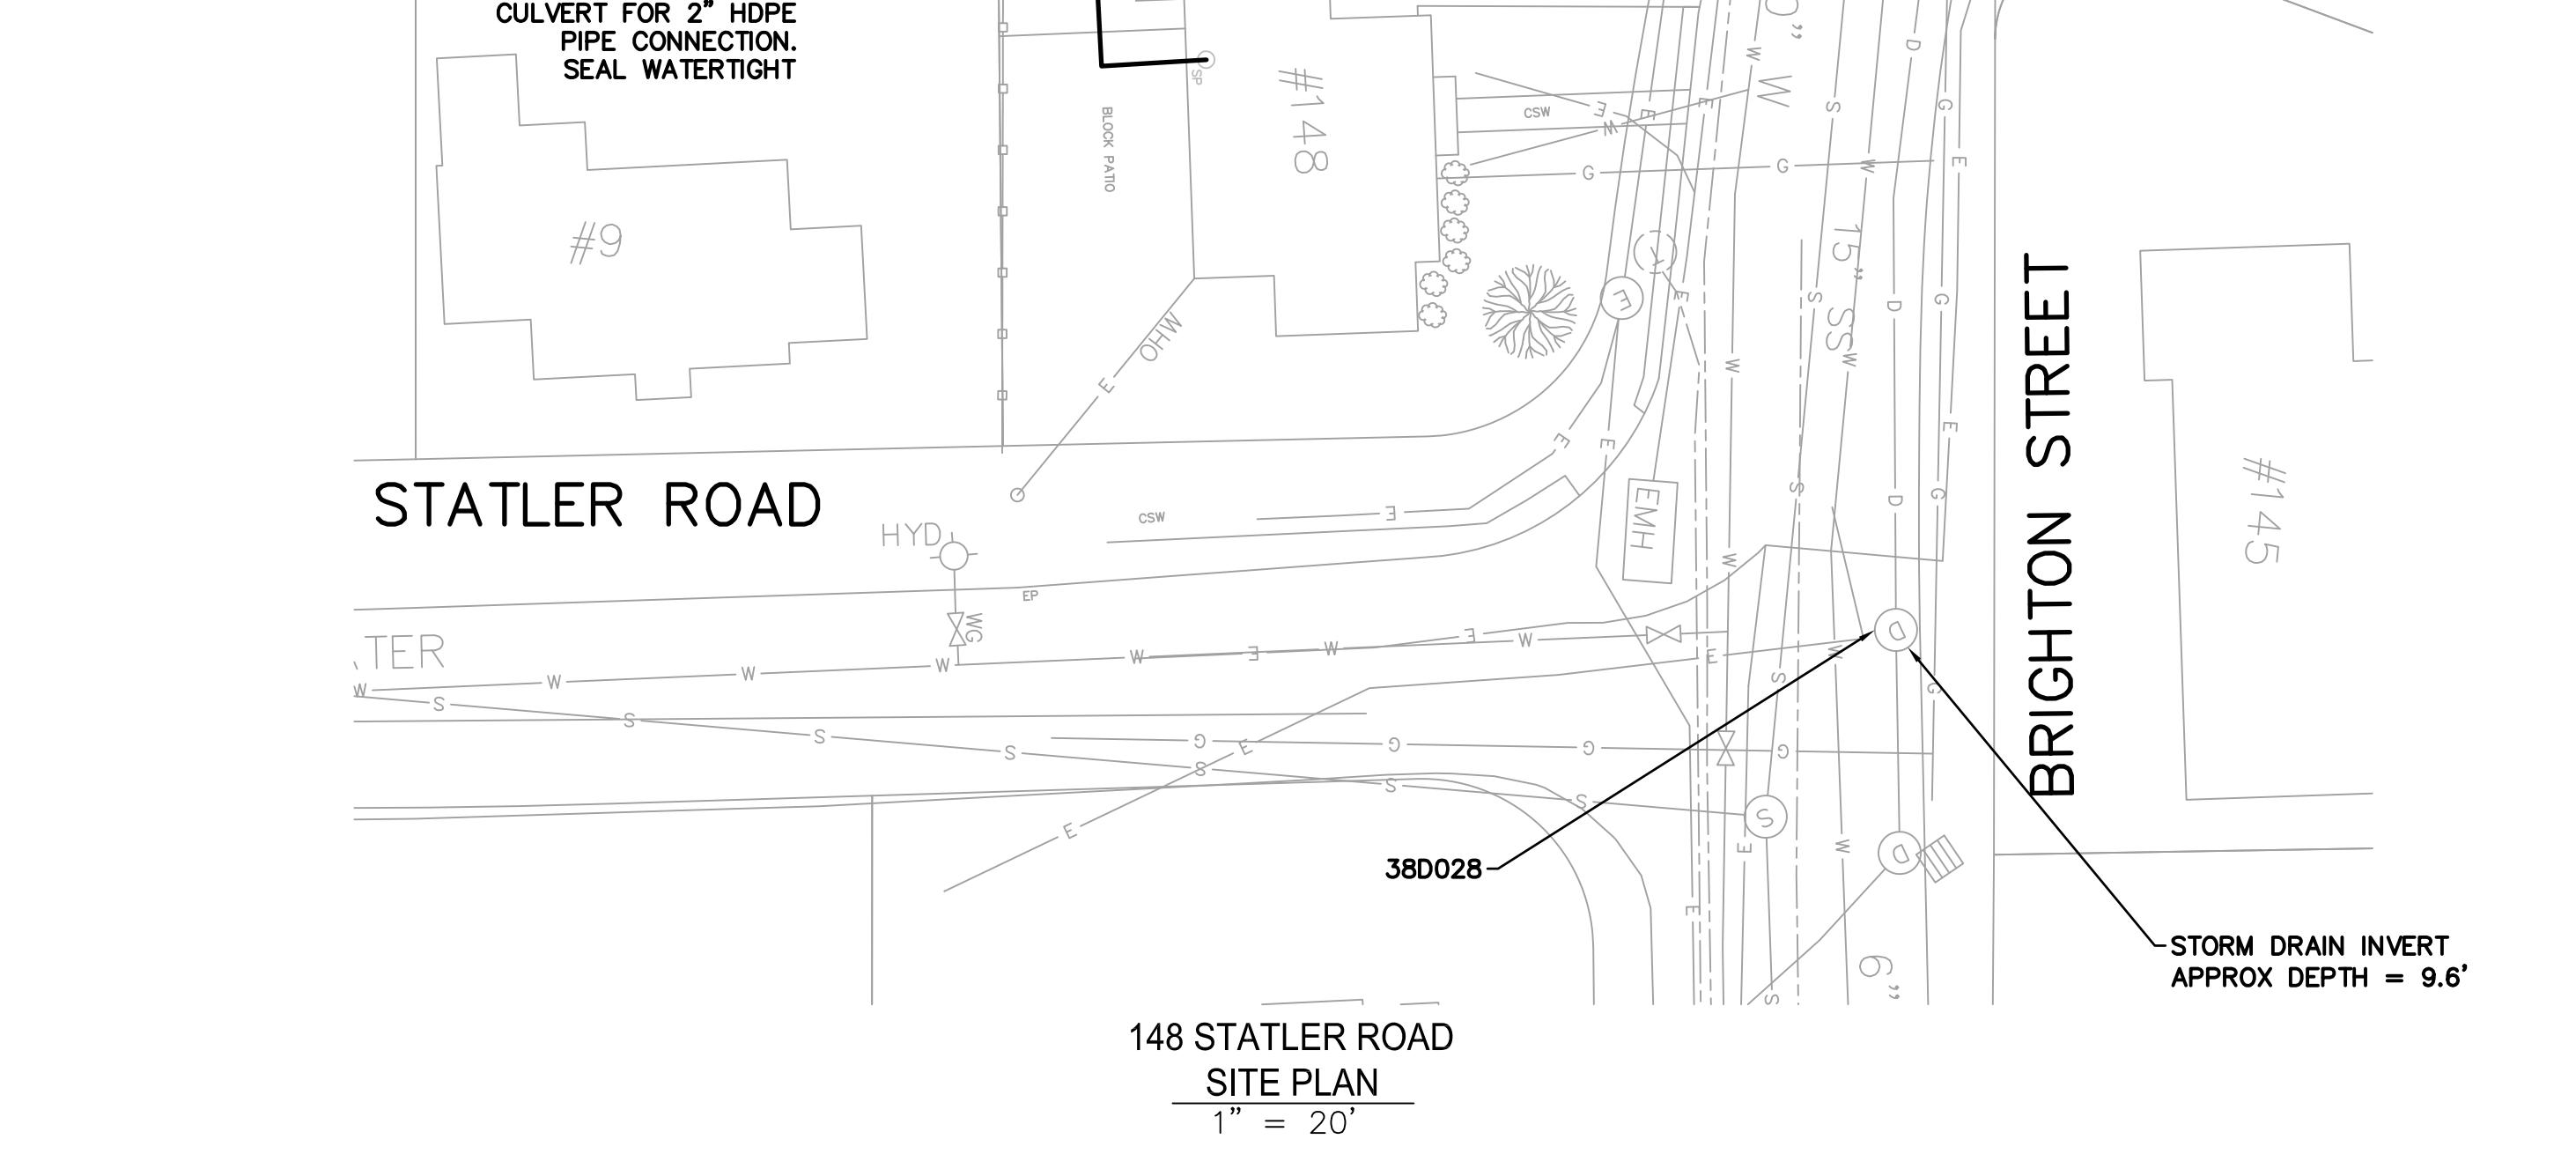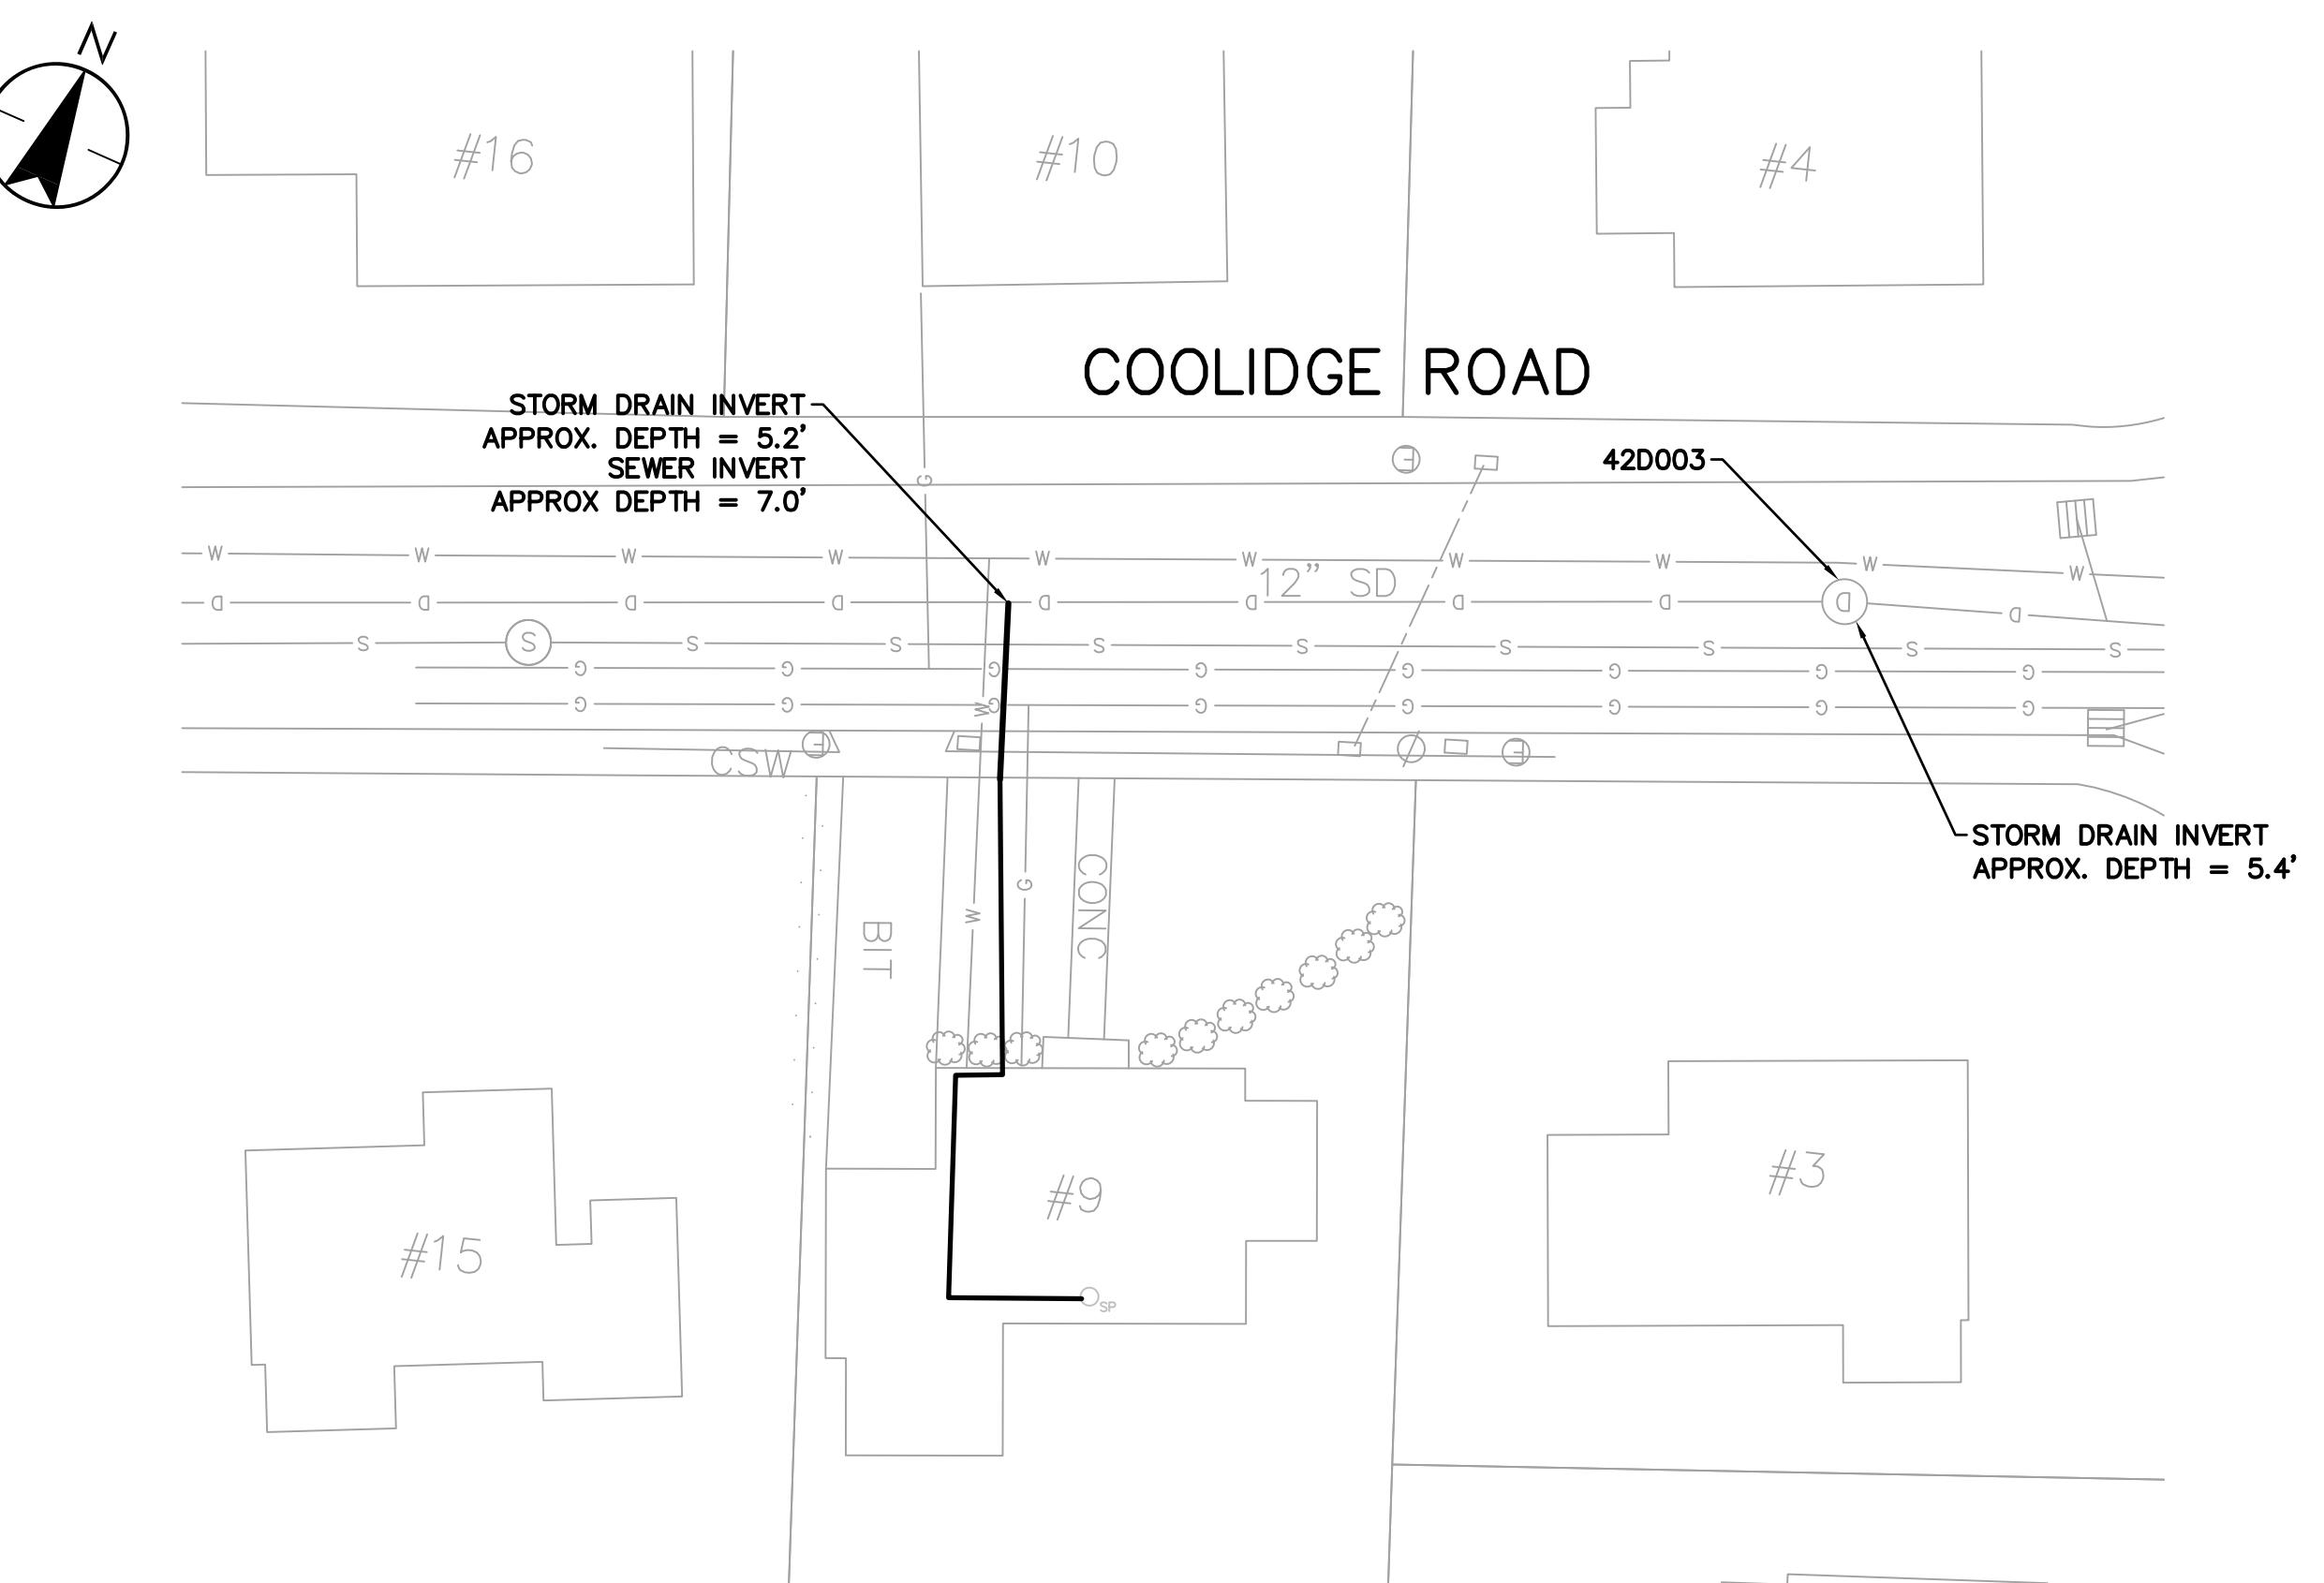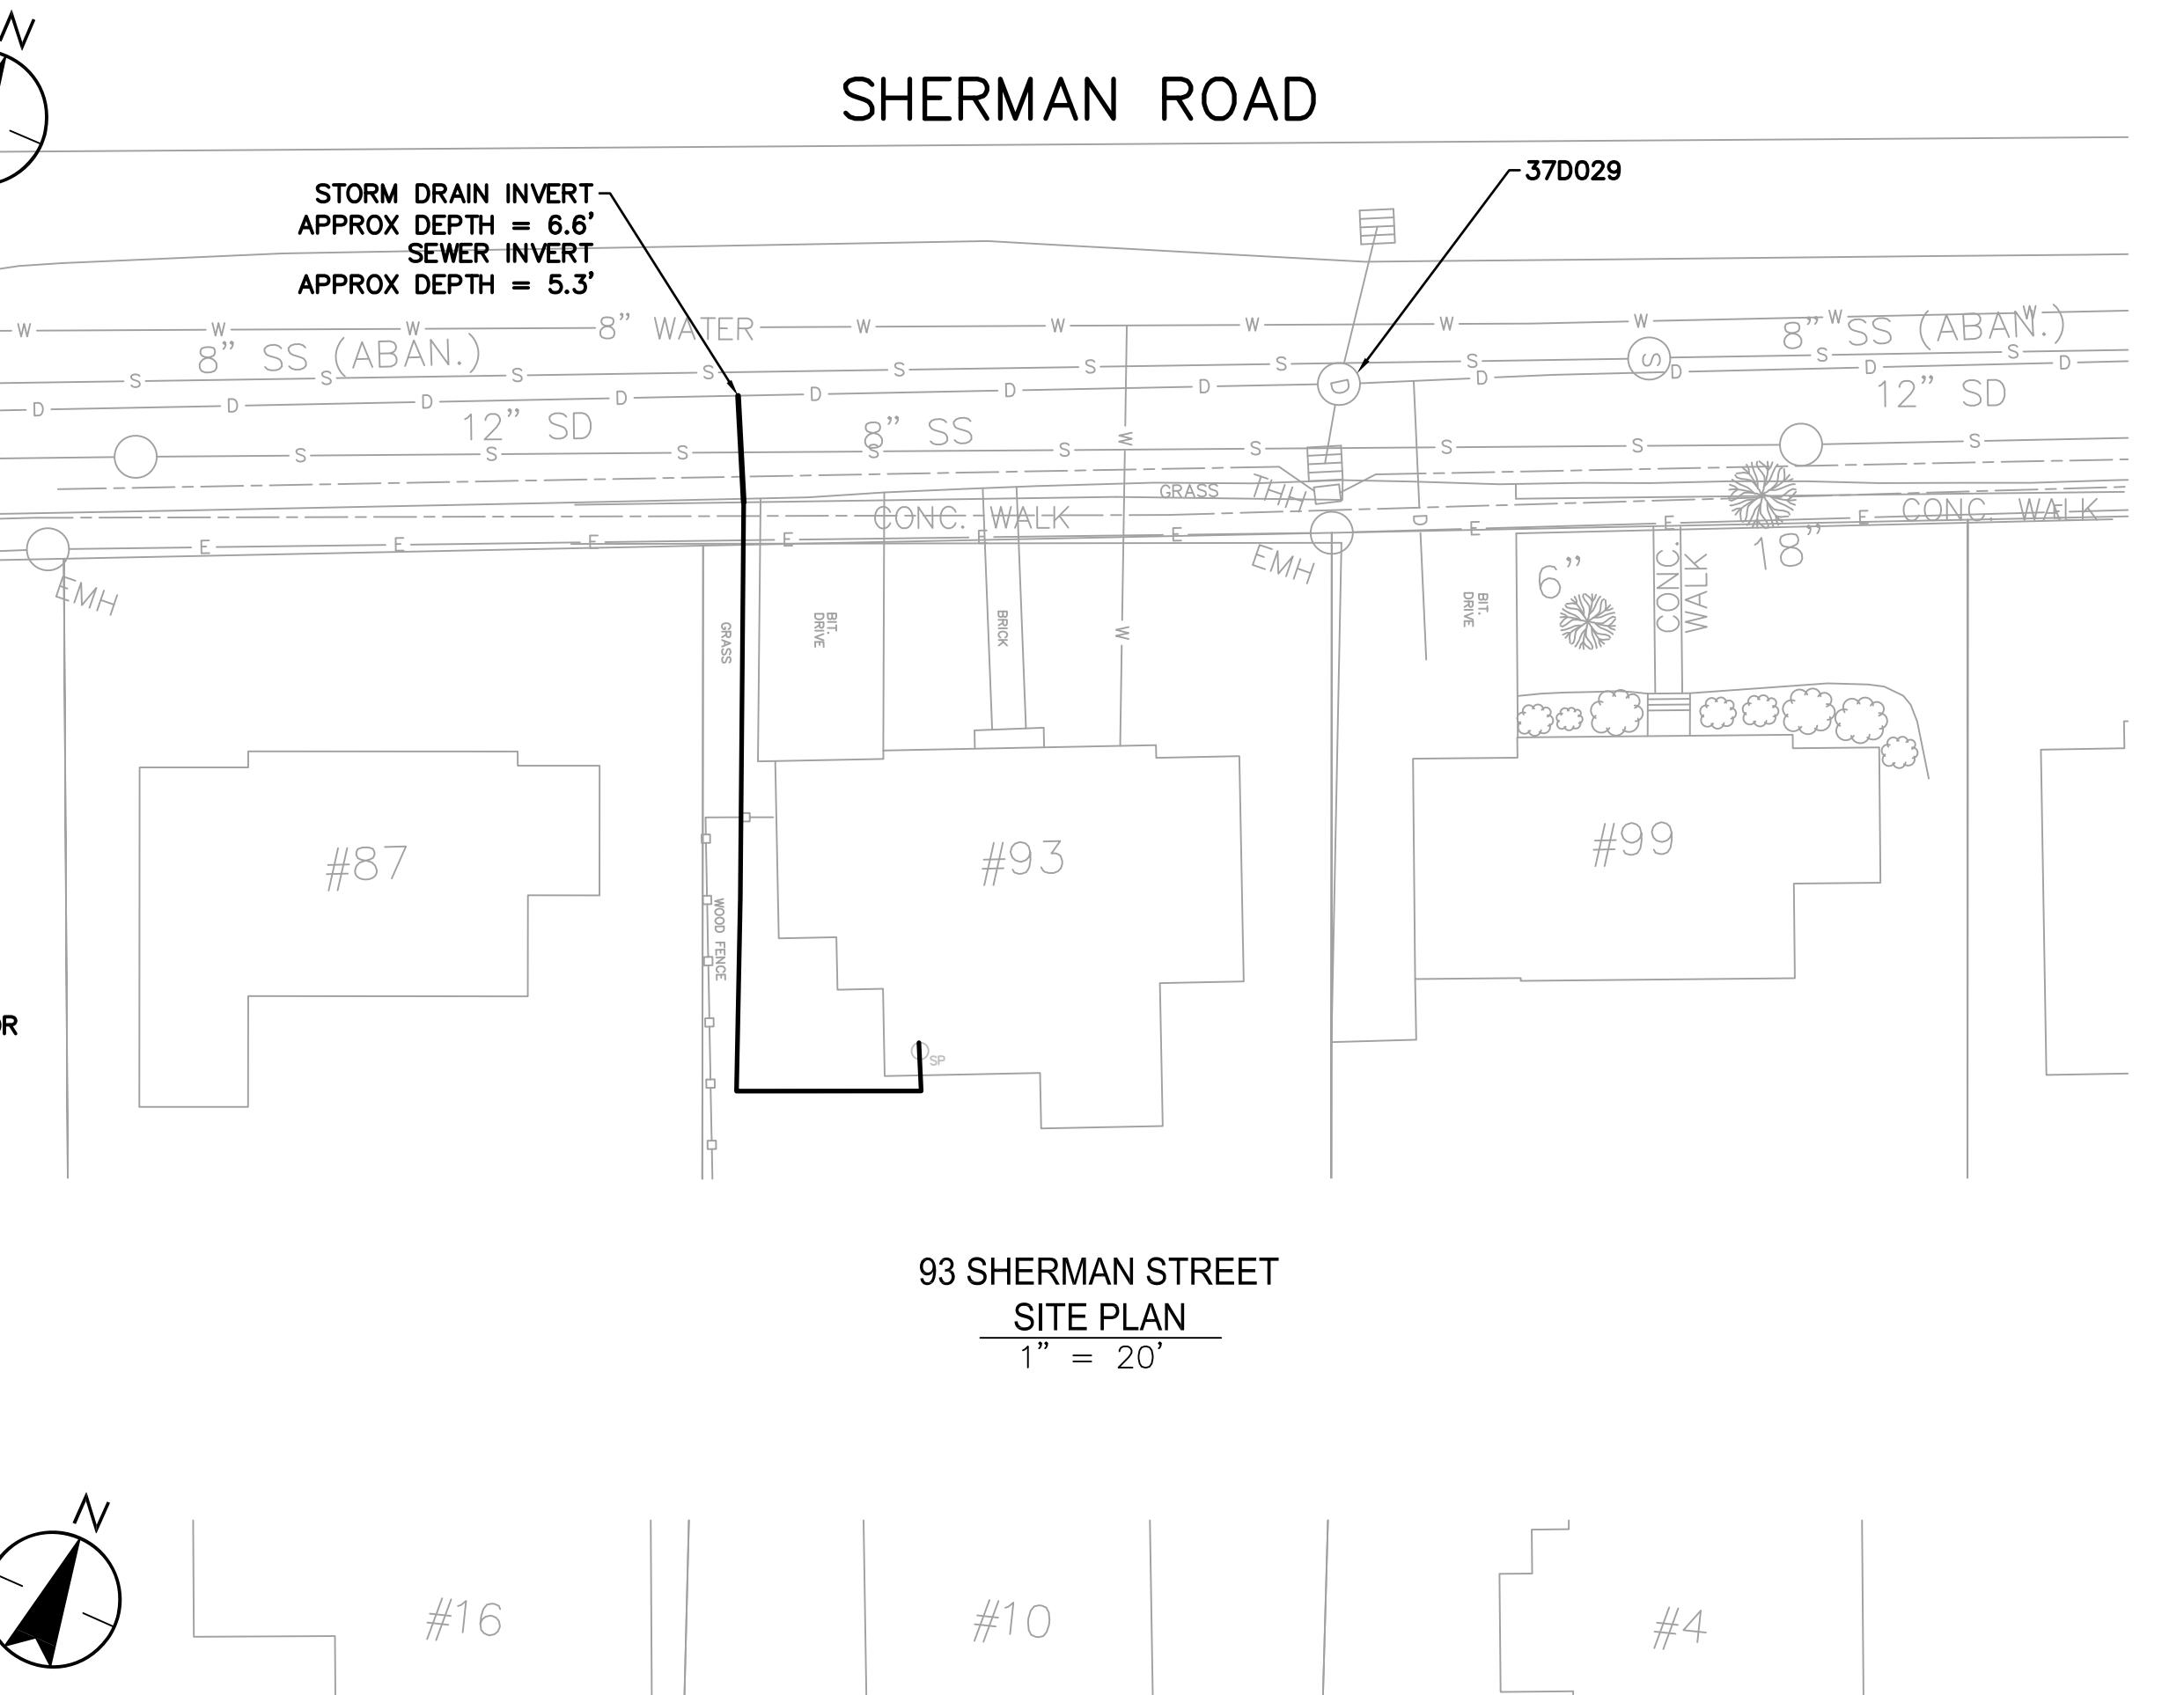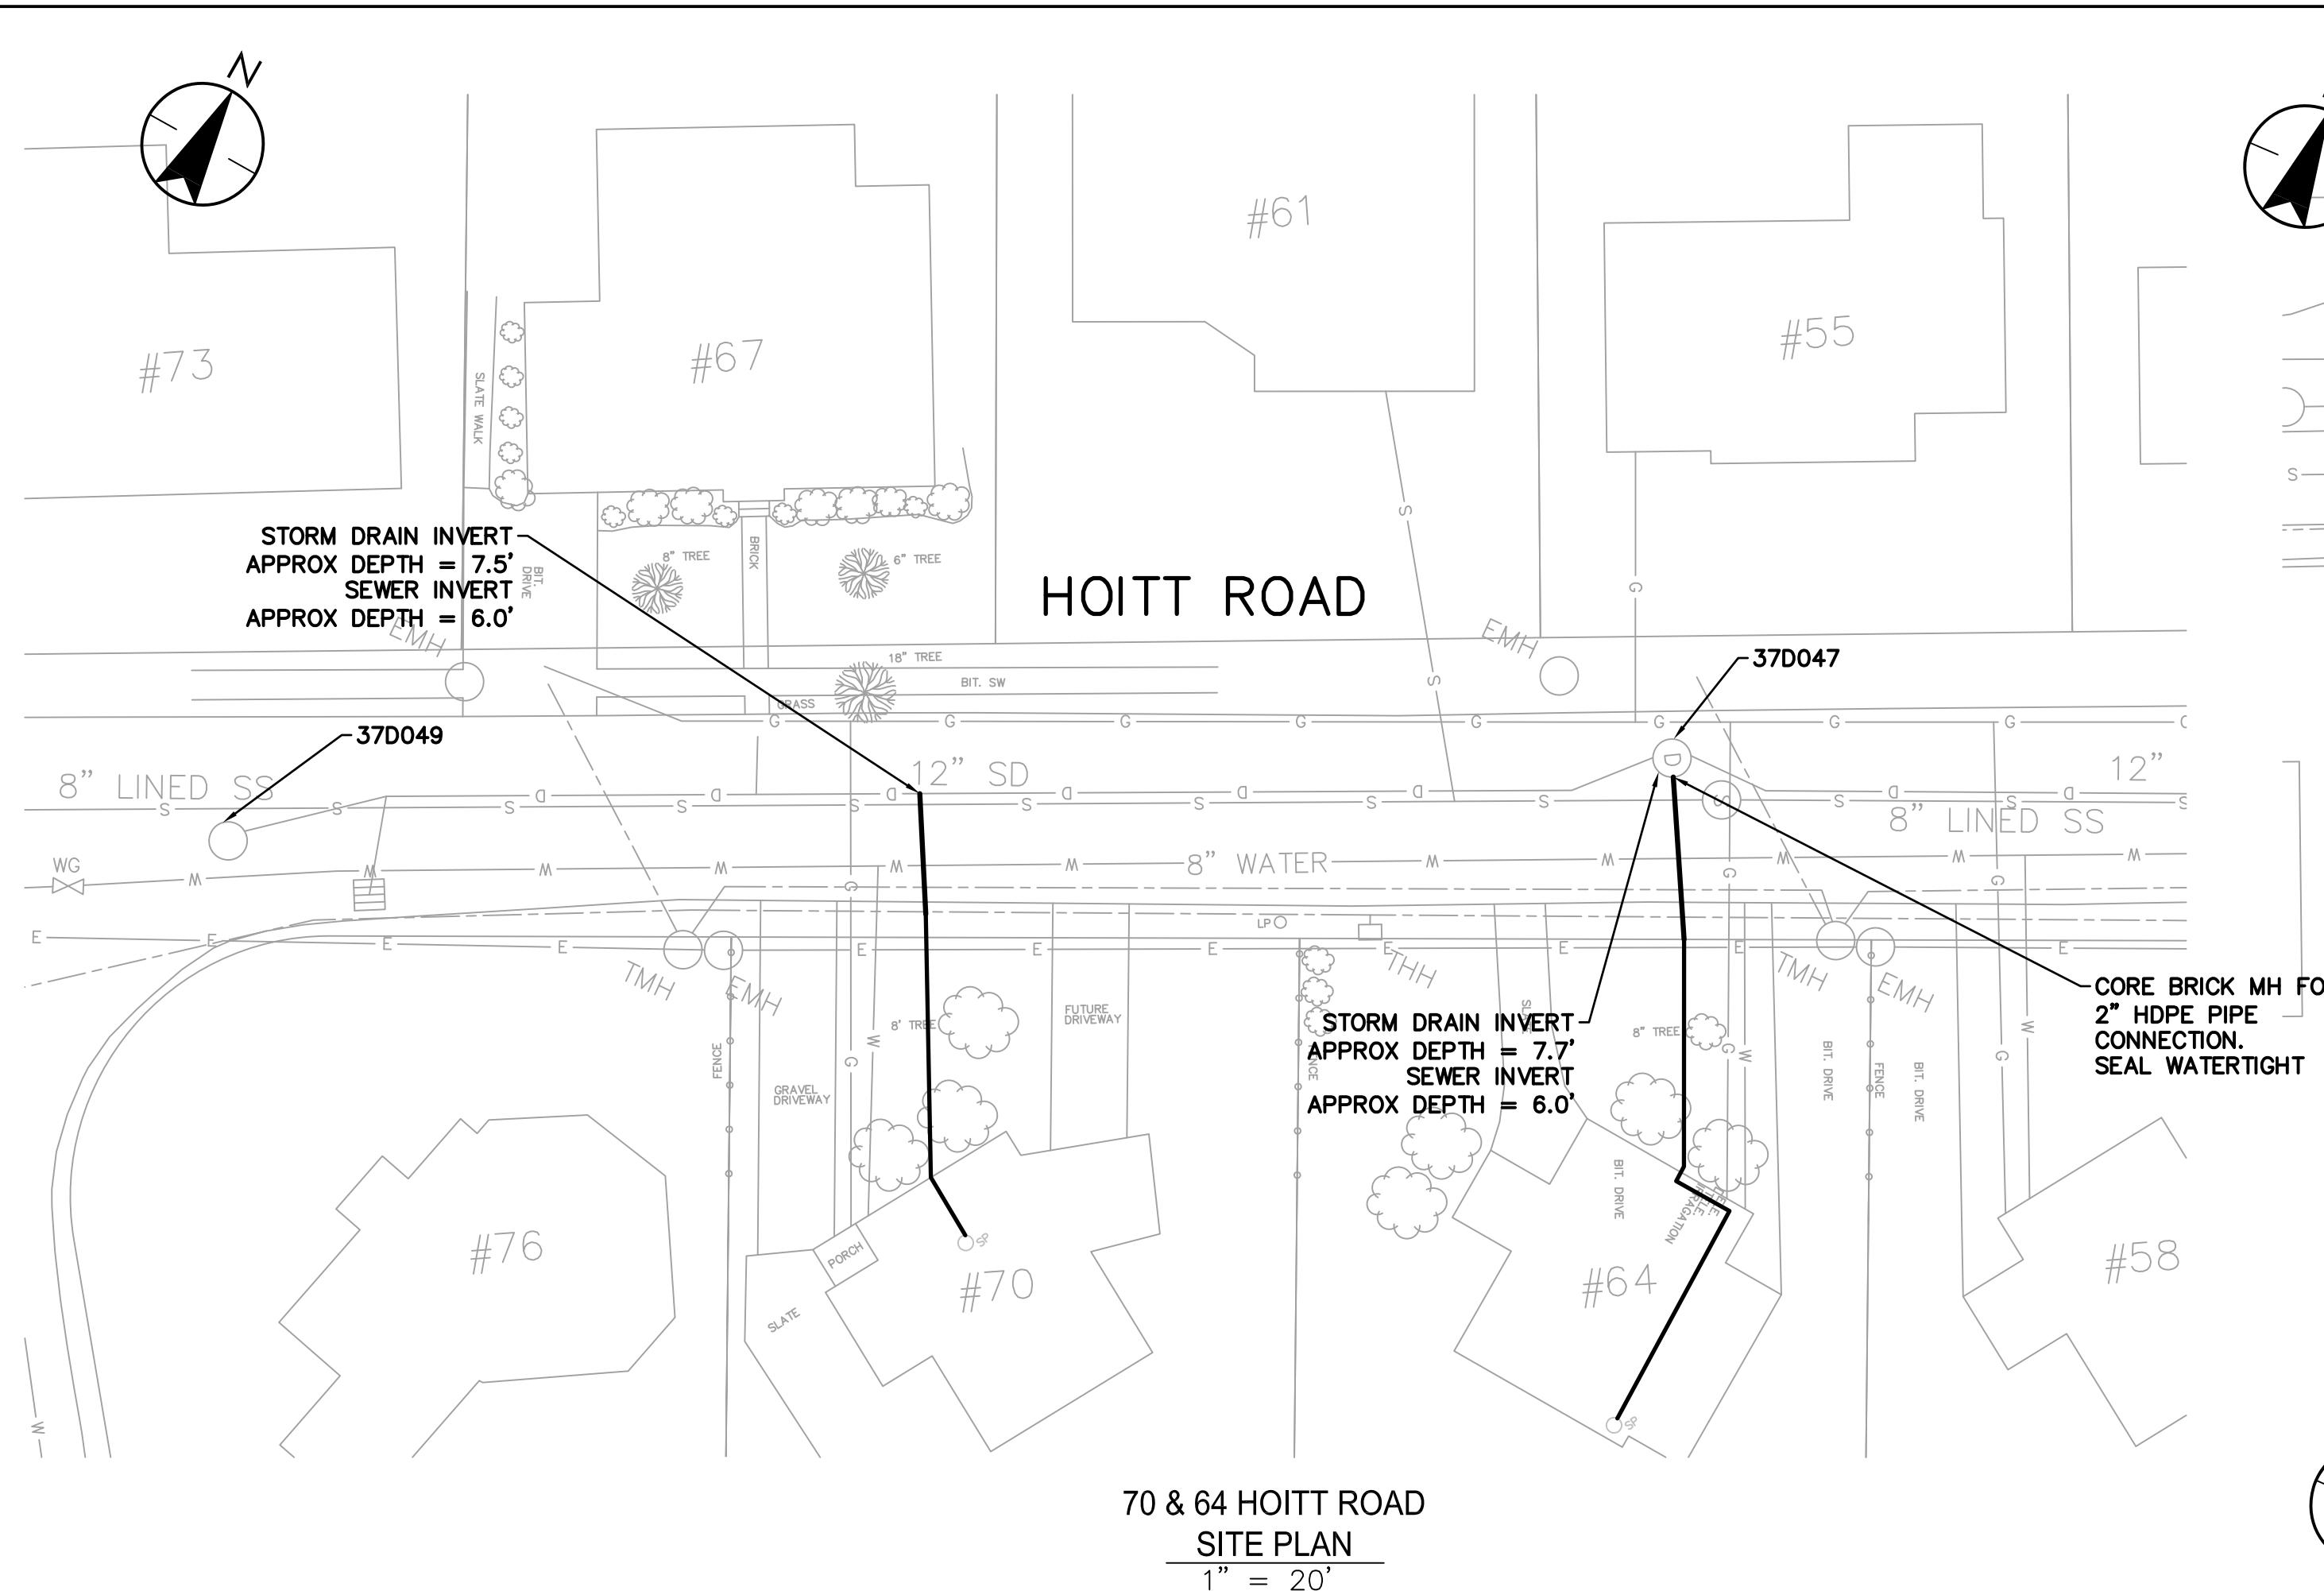TOWN OF BELMONT, MASSACHUSETTS  
PRIVATE SECTOR SUMP PUMP REMOVAL &  
SEWER SYSTEM REHABILITATION  
MWRA PROJECT NO. WRA-P11-04-3-1124 &  
MWRA PROJECT NO. WRA-P11-04-3-1160  
BELMONT, MASSACHUSETTS  
SUMP PUMP - HOITT RD, SHERMAN ST, BRIGHTON ST AND COOLIDGE RD

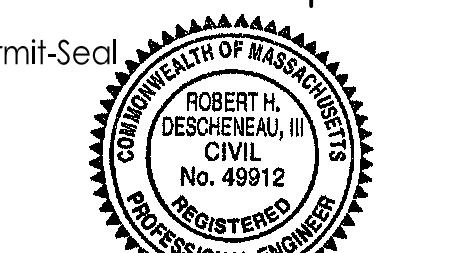

Project Number: 195113362  
File Name:  
AMD RHD RPB 21.03.31  
Dwn. Chkd. Disp. YY.MM.DD  
Drawing No. C-120  
Revision Sheet  
0 24 of

- NOTES:**
- SEE SHEET NO. 29/DRAWING NO. C-501 FOR SUMP PUMP RELOCATION DETAILS AND NOTES.






## OTES:

- SEE SHEET NO. 29/DRAWING NO. C-501 FOR  
SUMP PUMP RELOCATION DETAILS AND NOTES.



<i>Kurt Carlson</i>			
3-29-2021			
Project Number:	195113362		
File Name:			
AMD	RHD	RPB	21.03.31
Dwn.	Chkd.	Dsgn.	YY.MM.DD
Drawing No.		C-121	
Revision	Sheet		


Revision Sheet

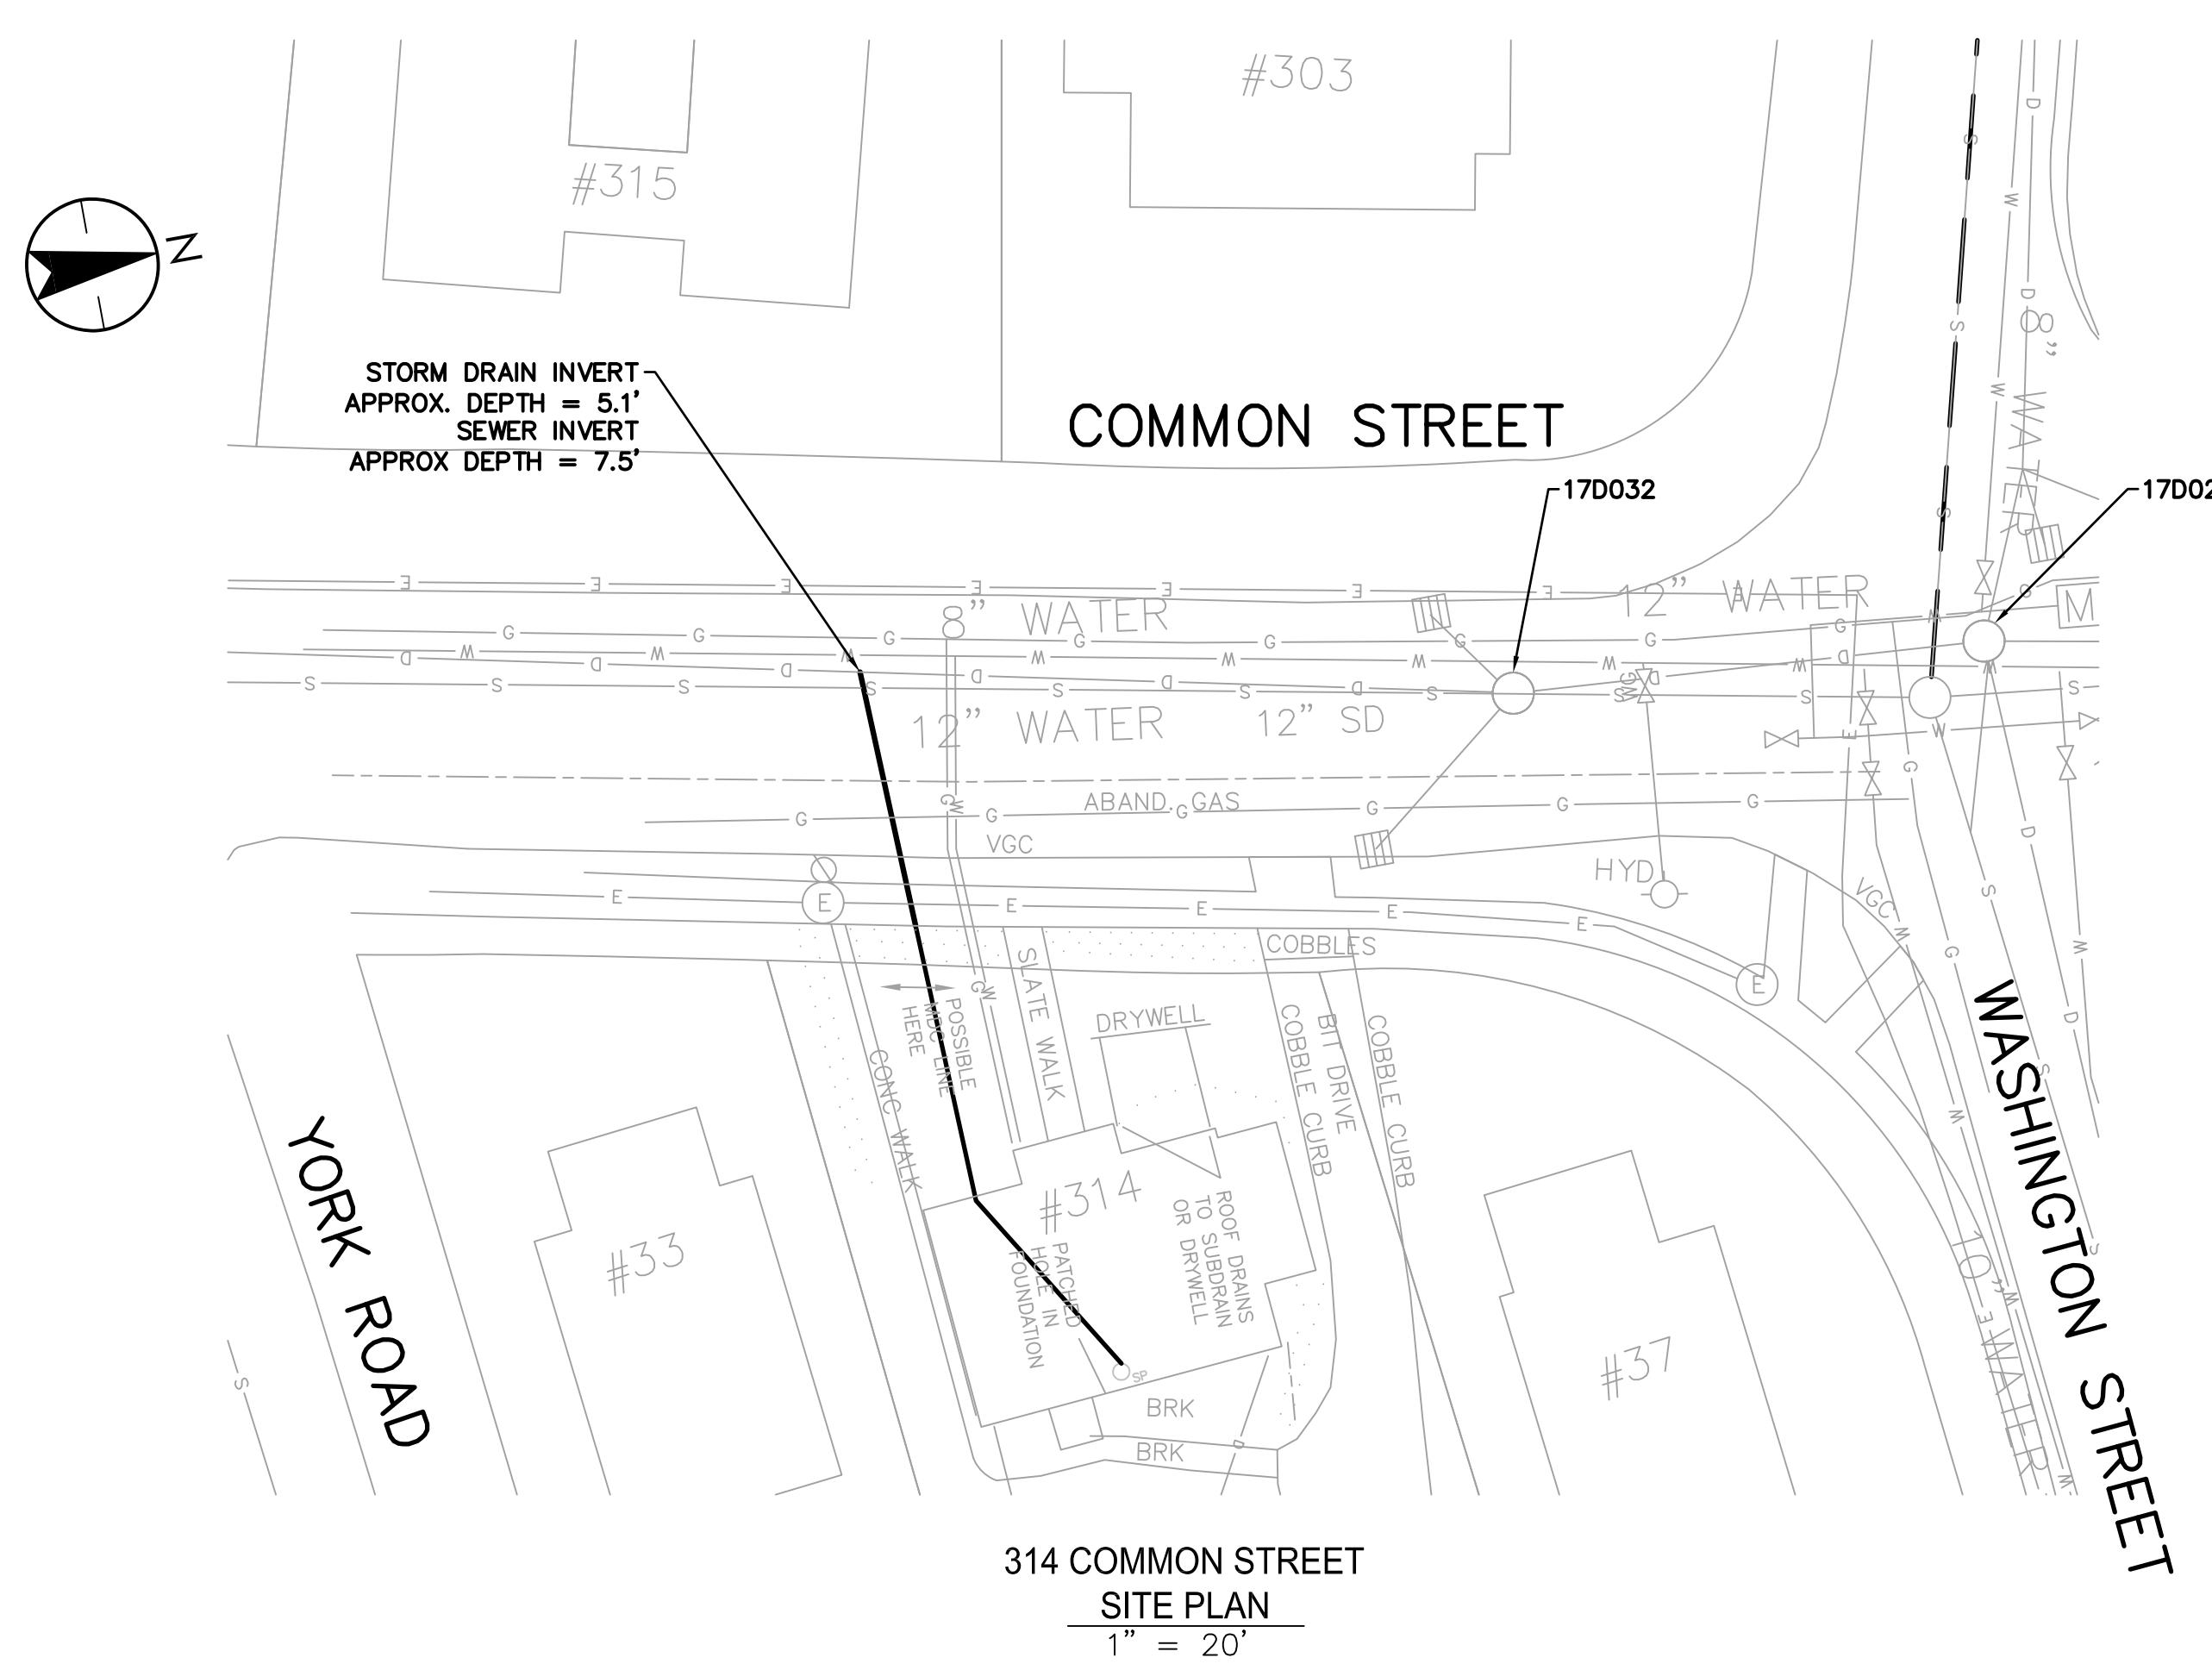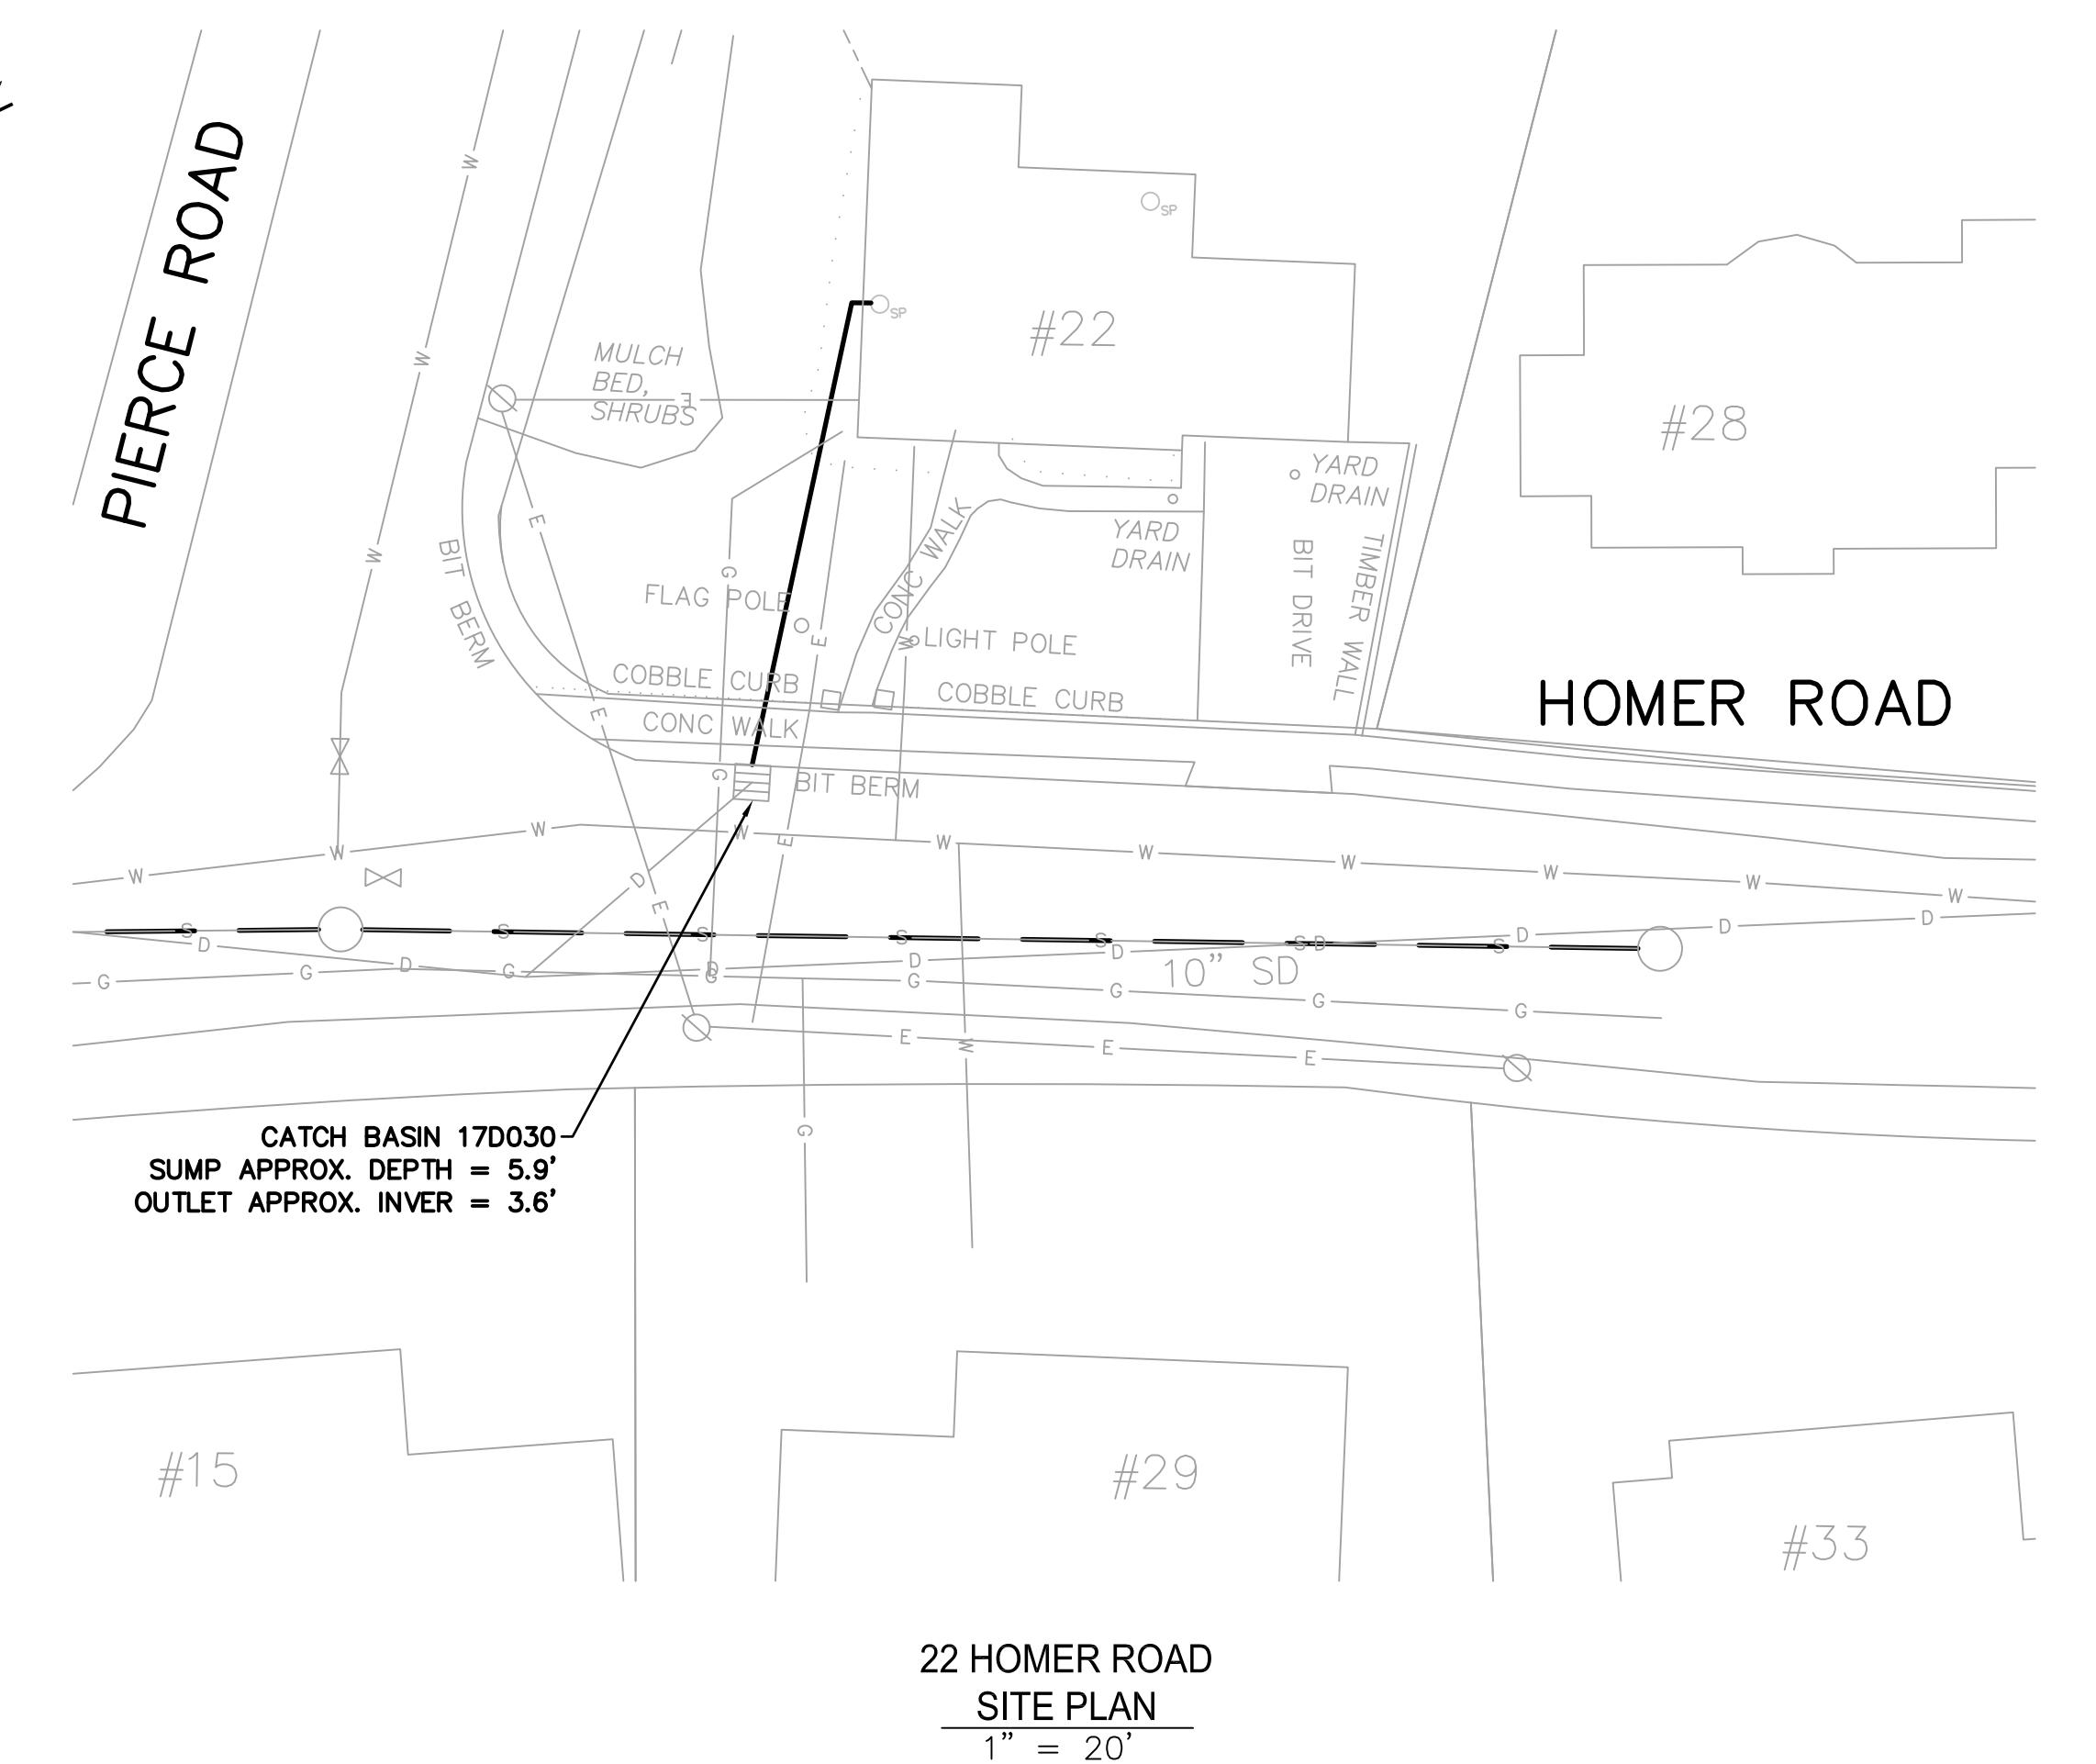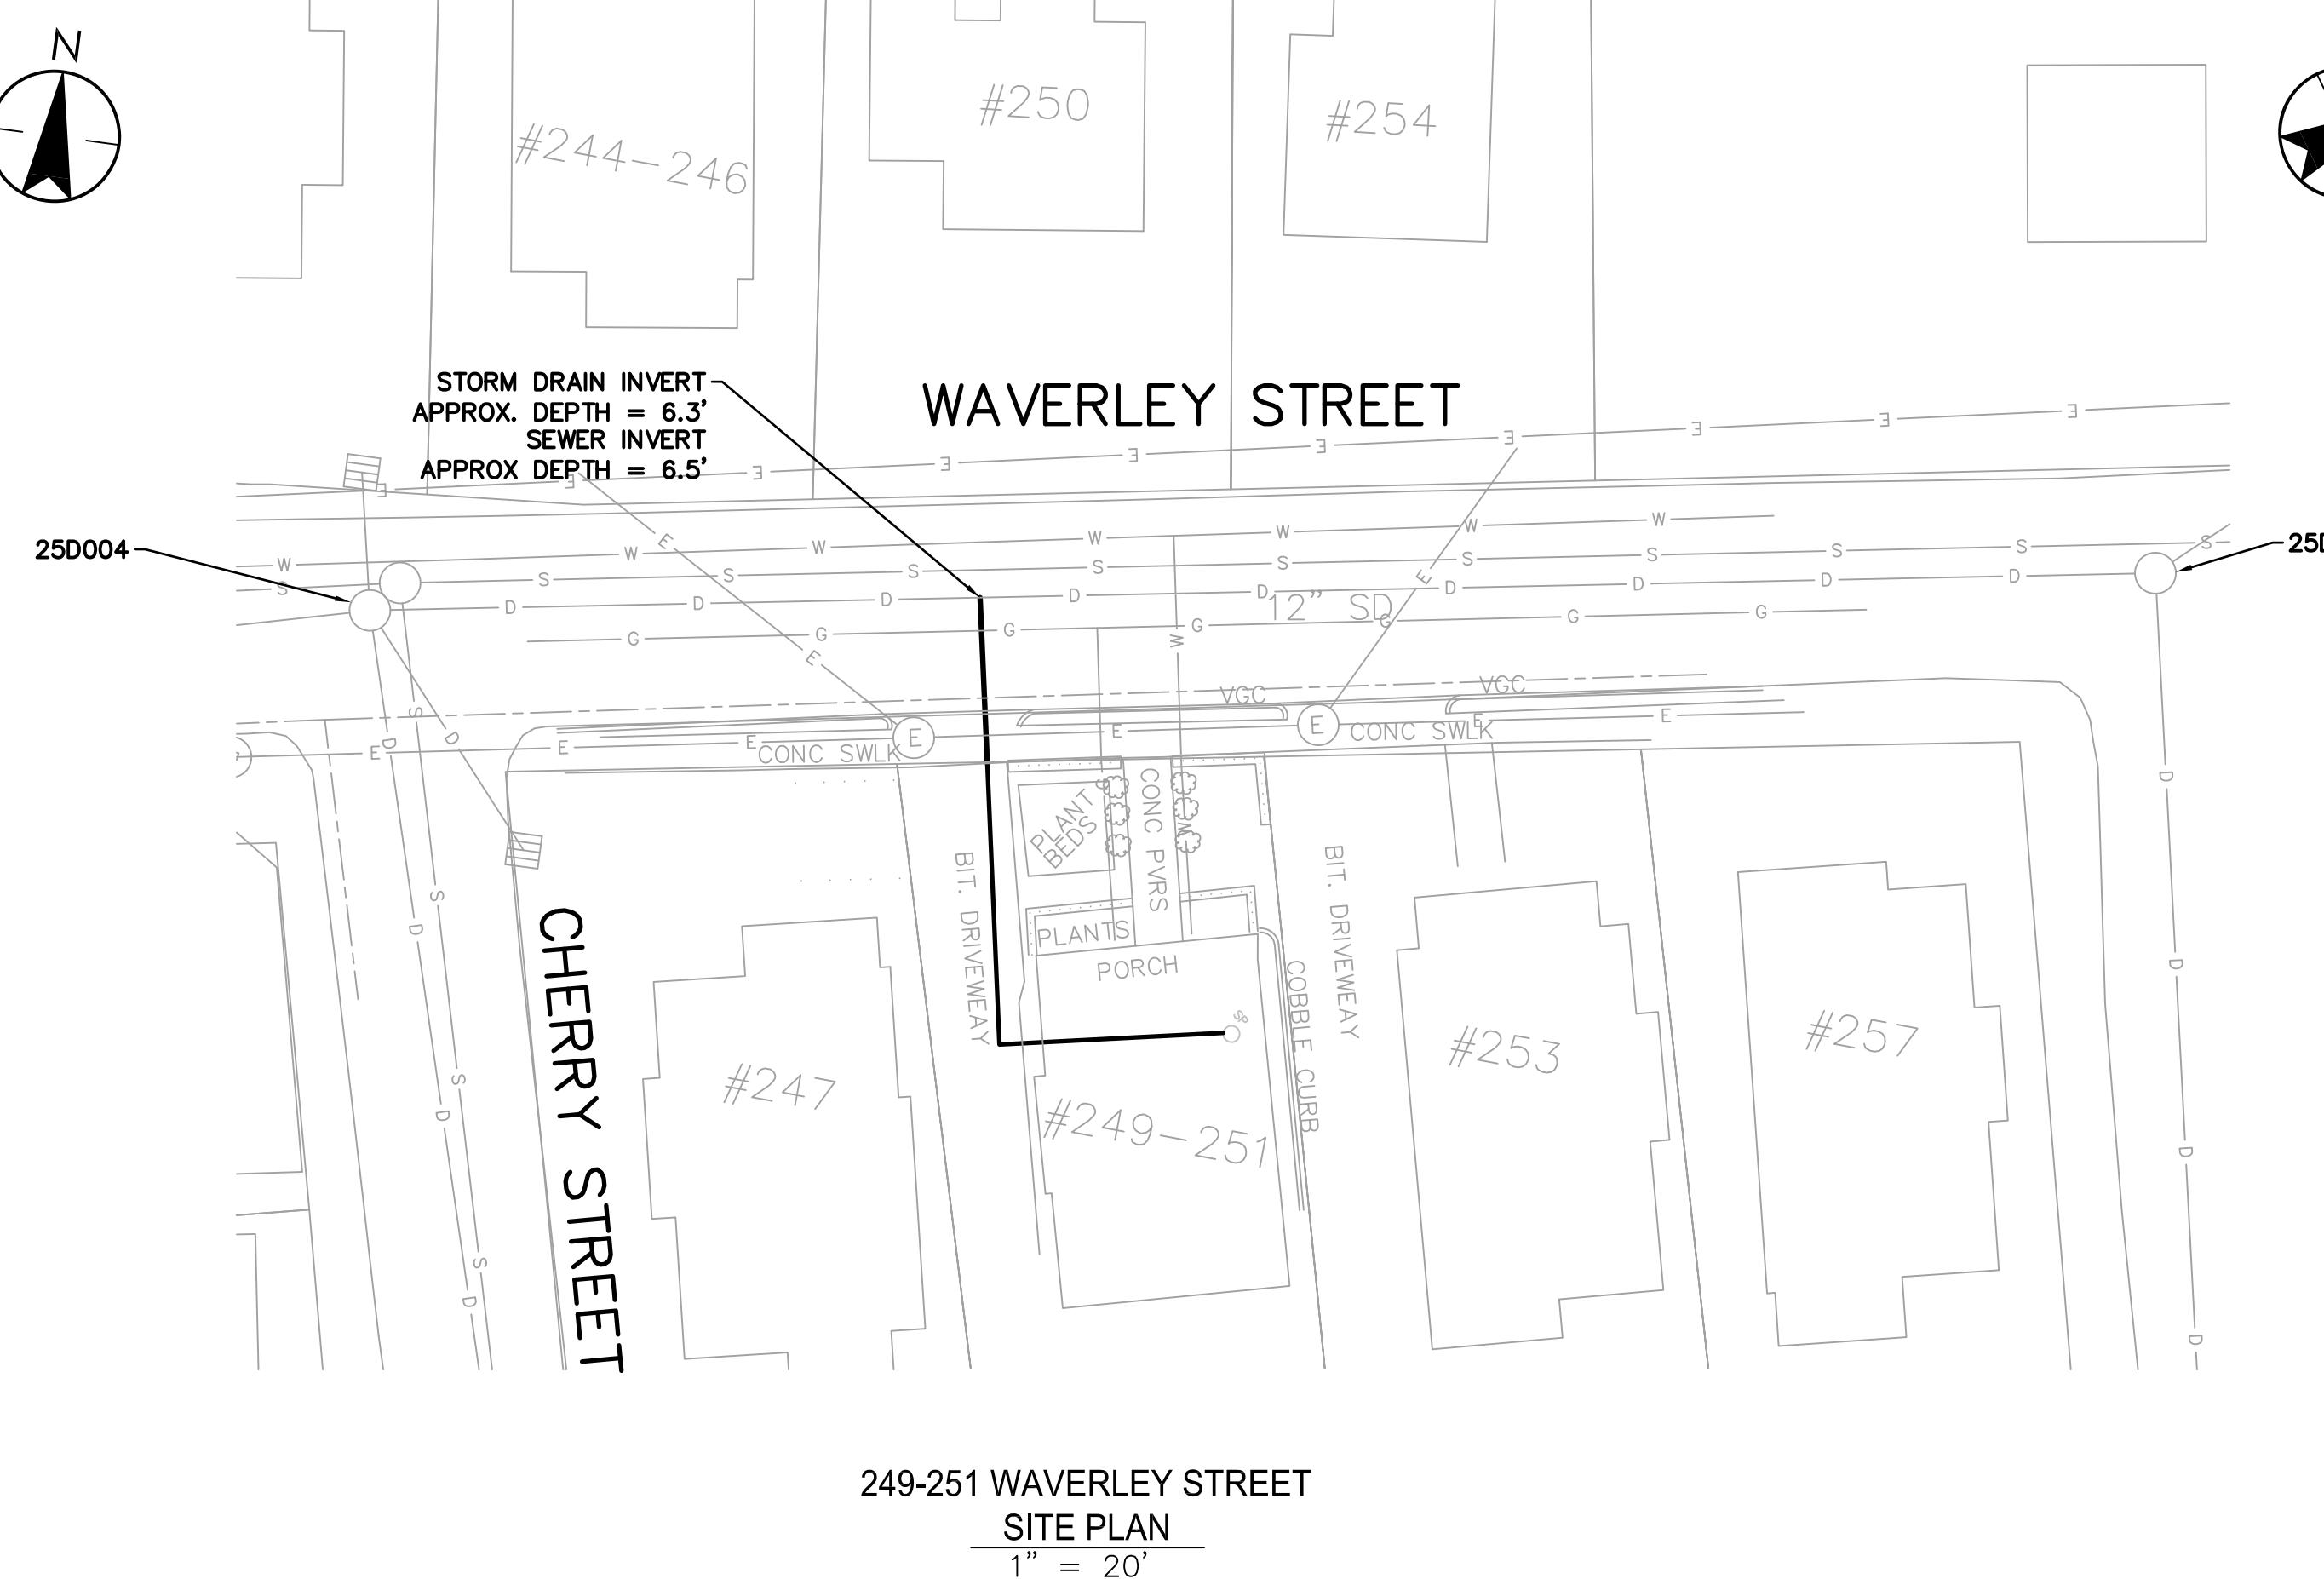

NOTES:

- SEE SHEET NO. 29/DRAWING NO. C-501 FOR SUMP PUMP RELOCATION DETAILS AND NOTES.

TOWN OF BELMONT, MASSACHUSETTS  
PRIVATE SECTOR SUMP PUMP REMOVAL &  
SEWER SYSTEM REHABILITATION  
MWRA PROJECT NO. WRA-P11-04-3-1124 &  
MWRA PROJECT NO. WRA-P11-04-3-1160  
BELMONT, MASSACHUSETTS  
SUMP PUMP - WAVERLEY ST, HOMER RD AND COMMON ST

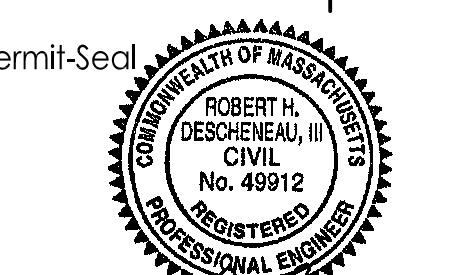

Project Number: 195113362

File Name:


AMD      RHD      RPB      21.03.31  
Dwn.      Chkd.      Disp.      YY.MM.DD

Drawing No. C-122

Revision Sheet

0




26 of

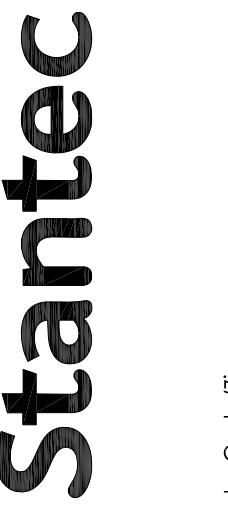

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TOWN OF BELMONT, MASSACHUSETTS  
PRIVATE SECTOR SUMP PUMP REMOVAL &  
SEWER SYSTEM REHABILITATION  
MWRA PROJECT NO. WRA-P11-04-3-1124 &  
MWRA PROJECT NO. WRA-P-11-04-3-1160

For more information about the study, please contact Dr. Michael J. Hwang at (319) 356-4000 or email at [mhwang@uiowa.edu](mailto:mhwang@uiowa.edu).

A circular notary seal for the Commonwealth of Massachusetts. The outer ring contains the words "NOTARY PUBLIC" at the top and "MASSACHUSETTS" at the bottom. The inner circle features the state motto "Ense petit placidam sub libertate quietem" above the name "ROBERT H. DESCHENAU, III". Below that is the word "CIVIL" and the number "No. 49912". The seal is stamped on a white card.

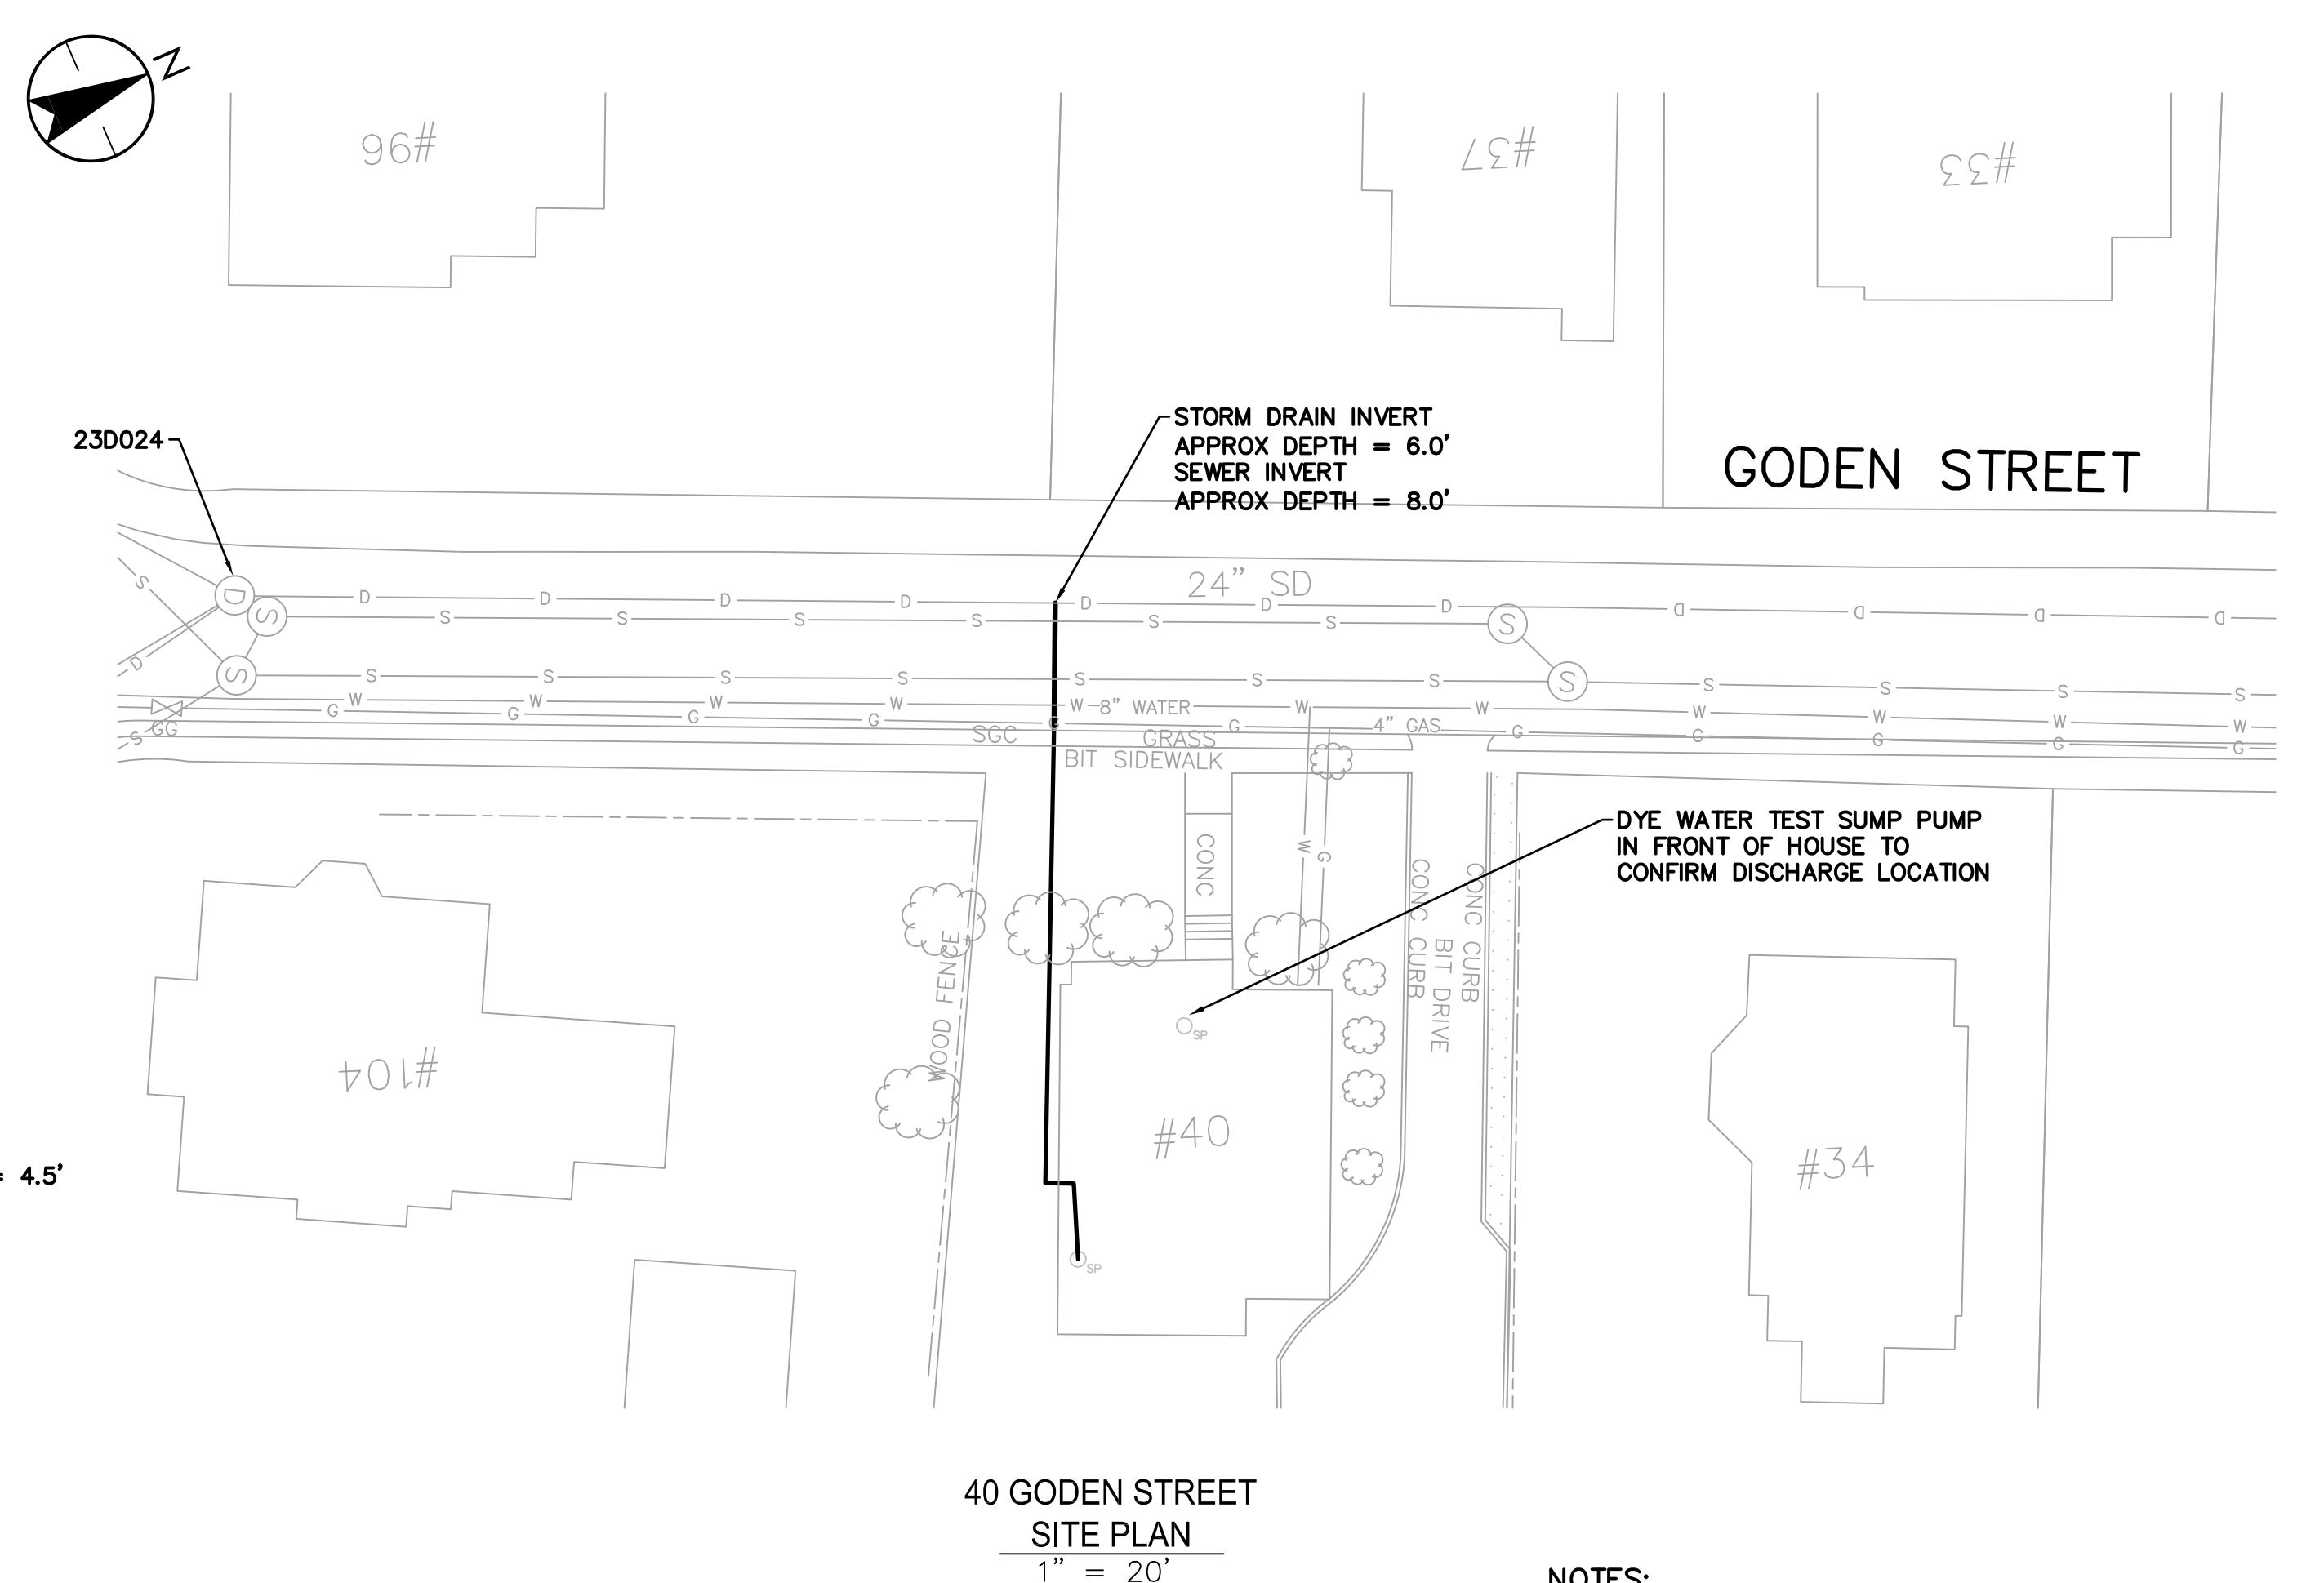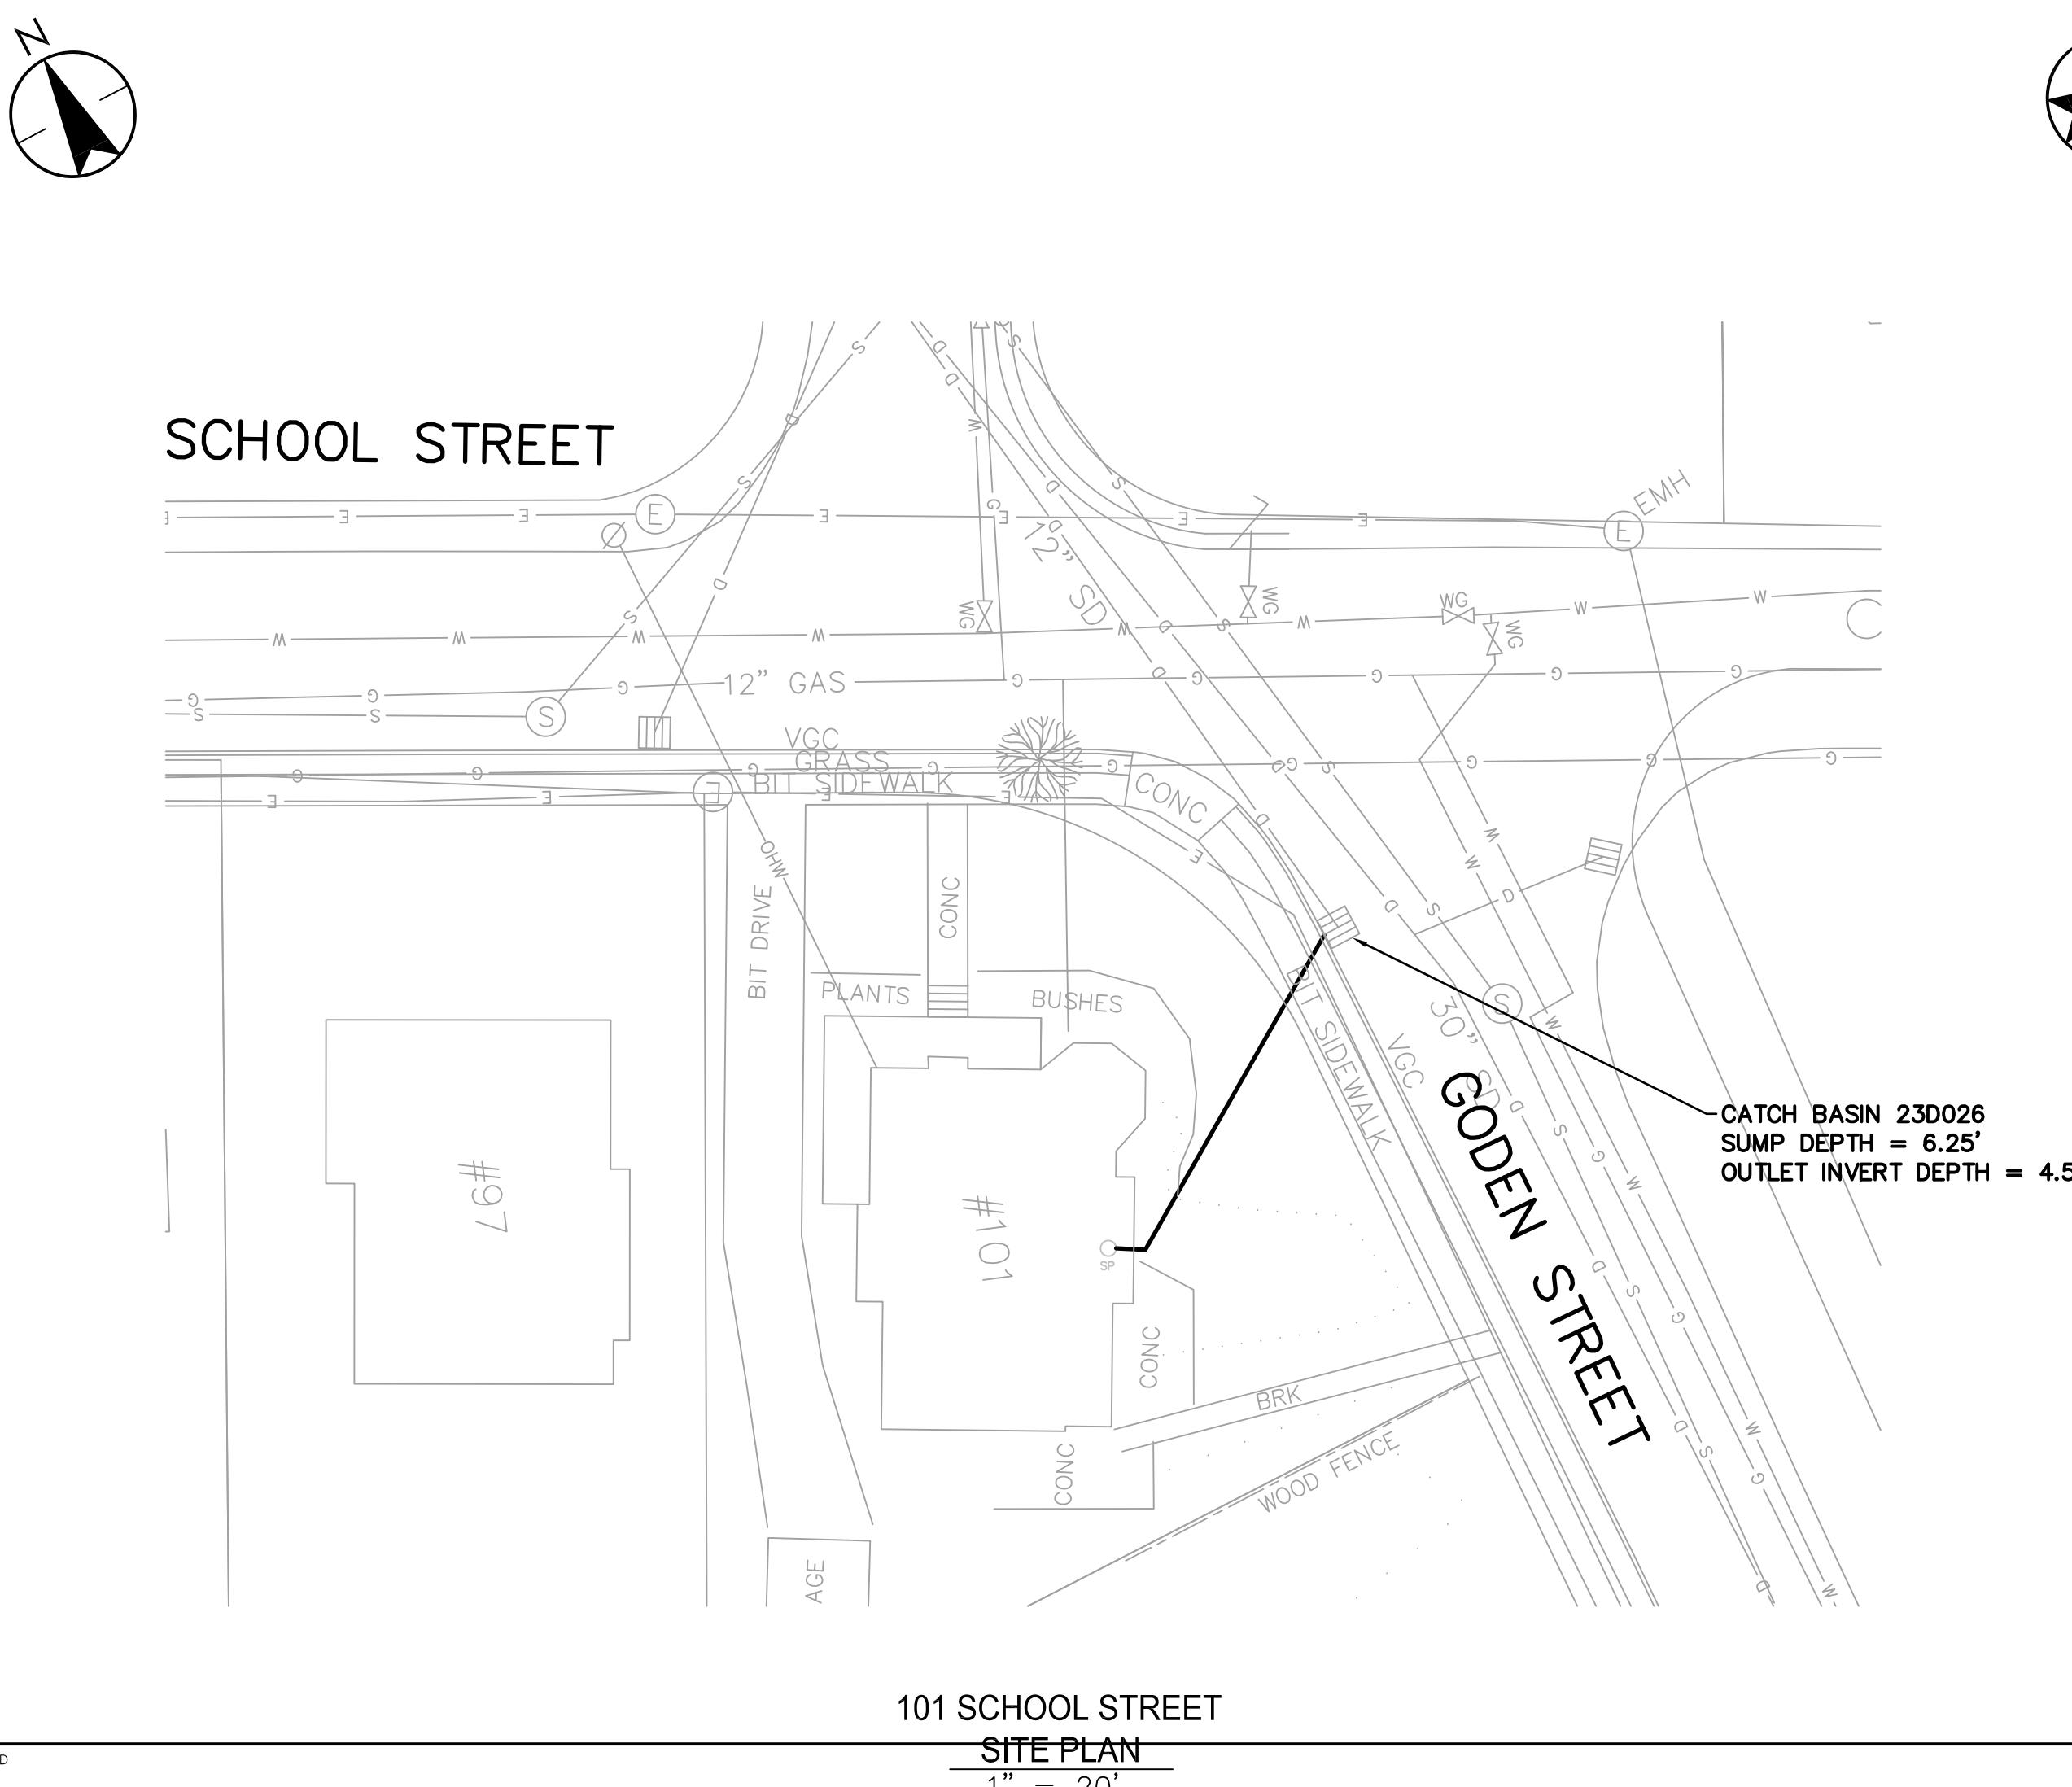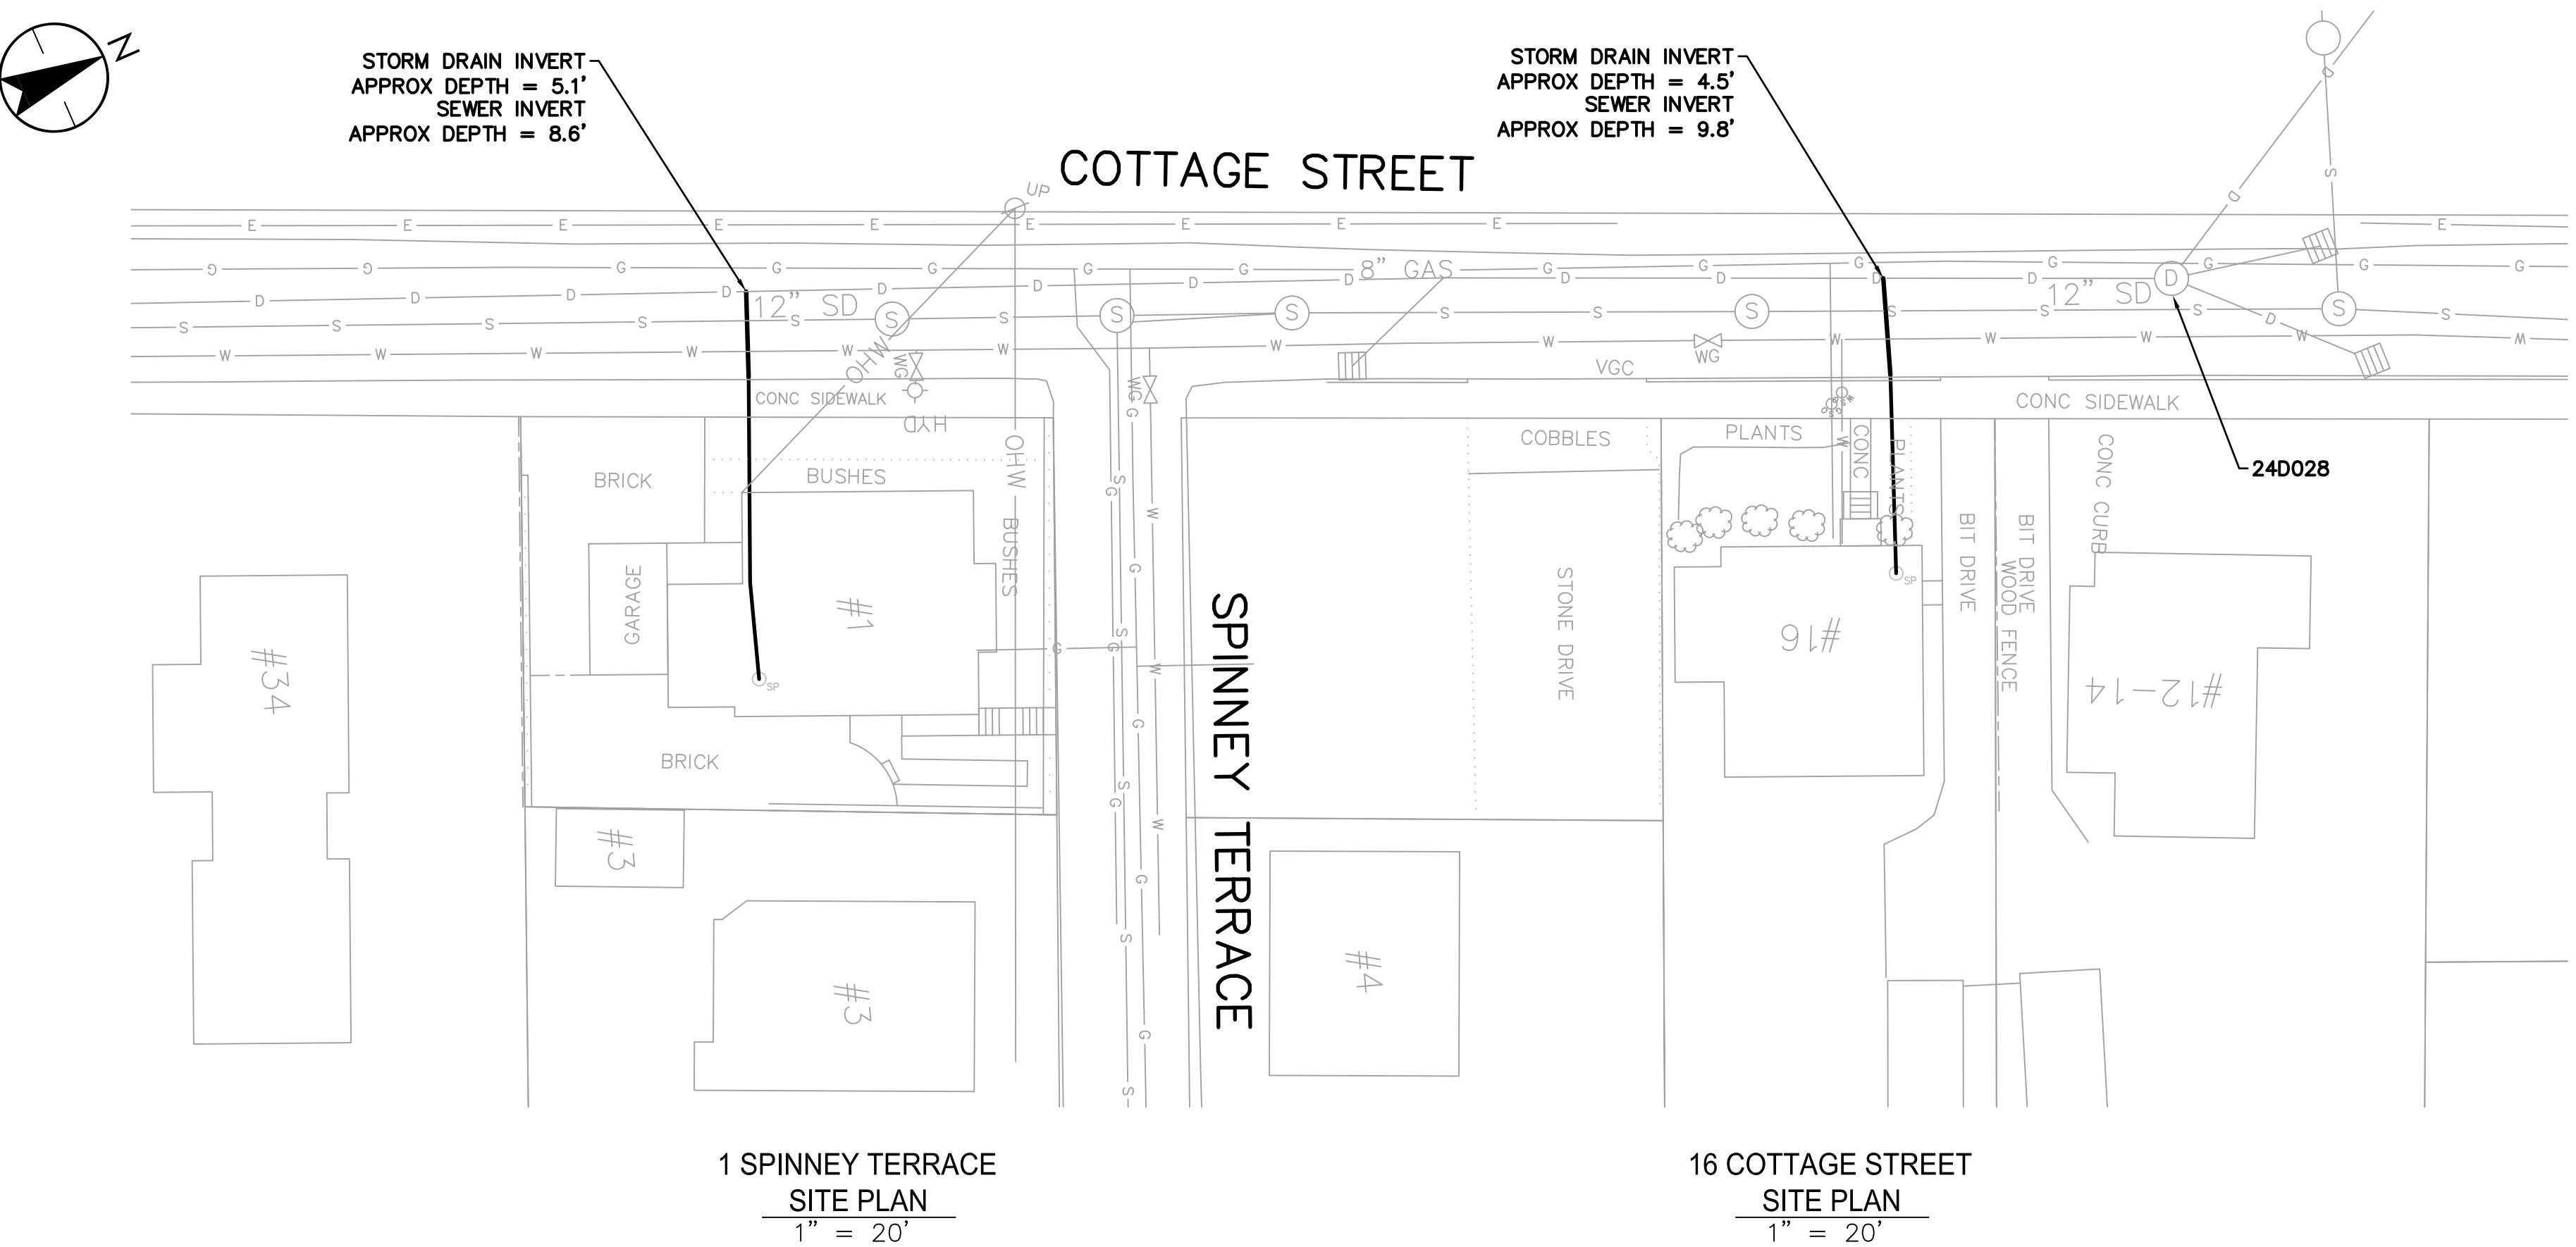PROFESSIONAL ENGINEERS

3-29-2021

Project Number: 195113362

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File Name: \_\_\_\_\_

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AMD      RHD      RPB      21.03.31

Dwn. Chkd. Dsgn. YY.MM.DD  
Drawing No. C-102



Drawing No. C-123

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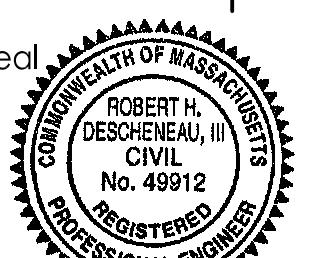
# Revision Sheet

27 of


27/81

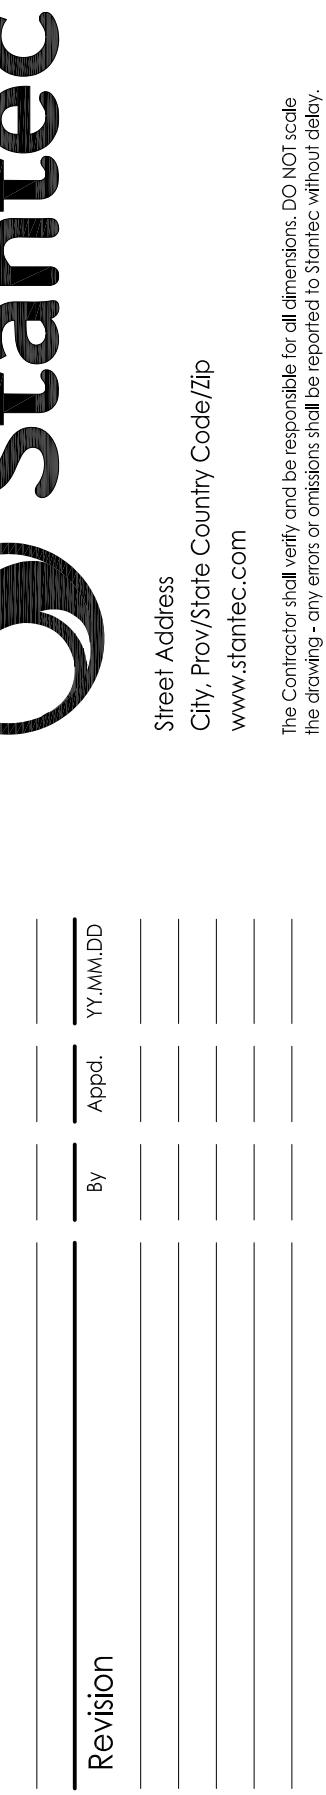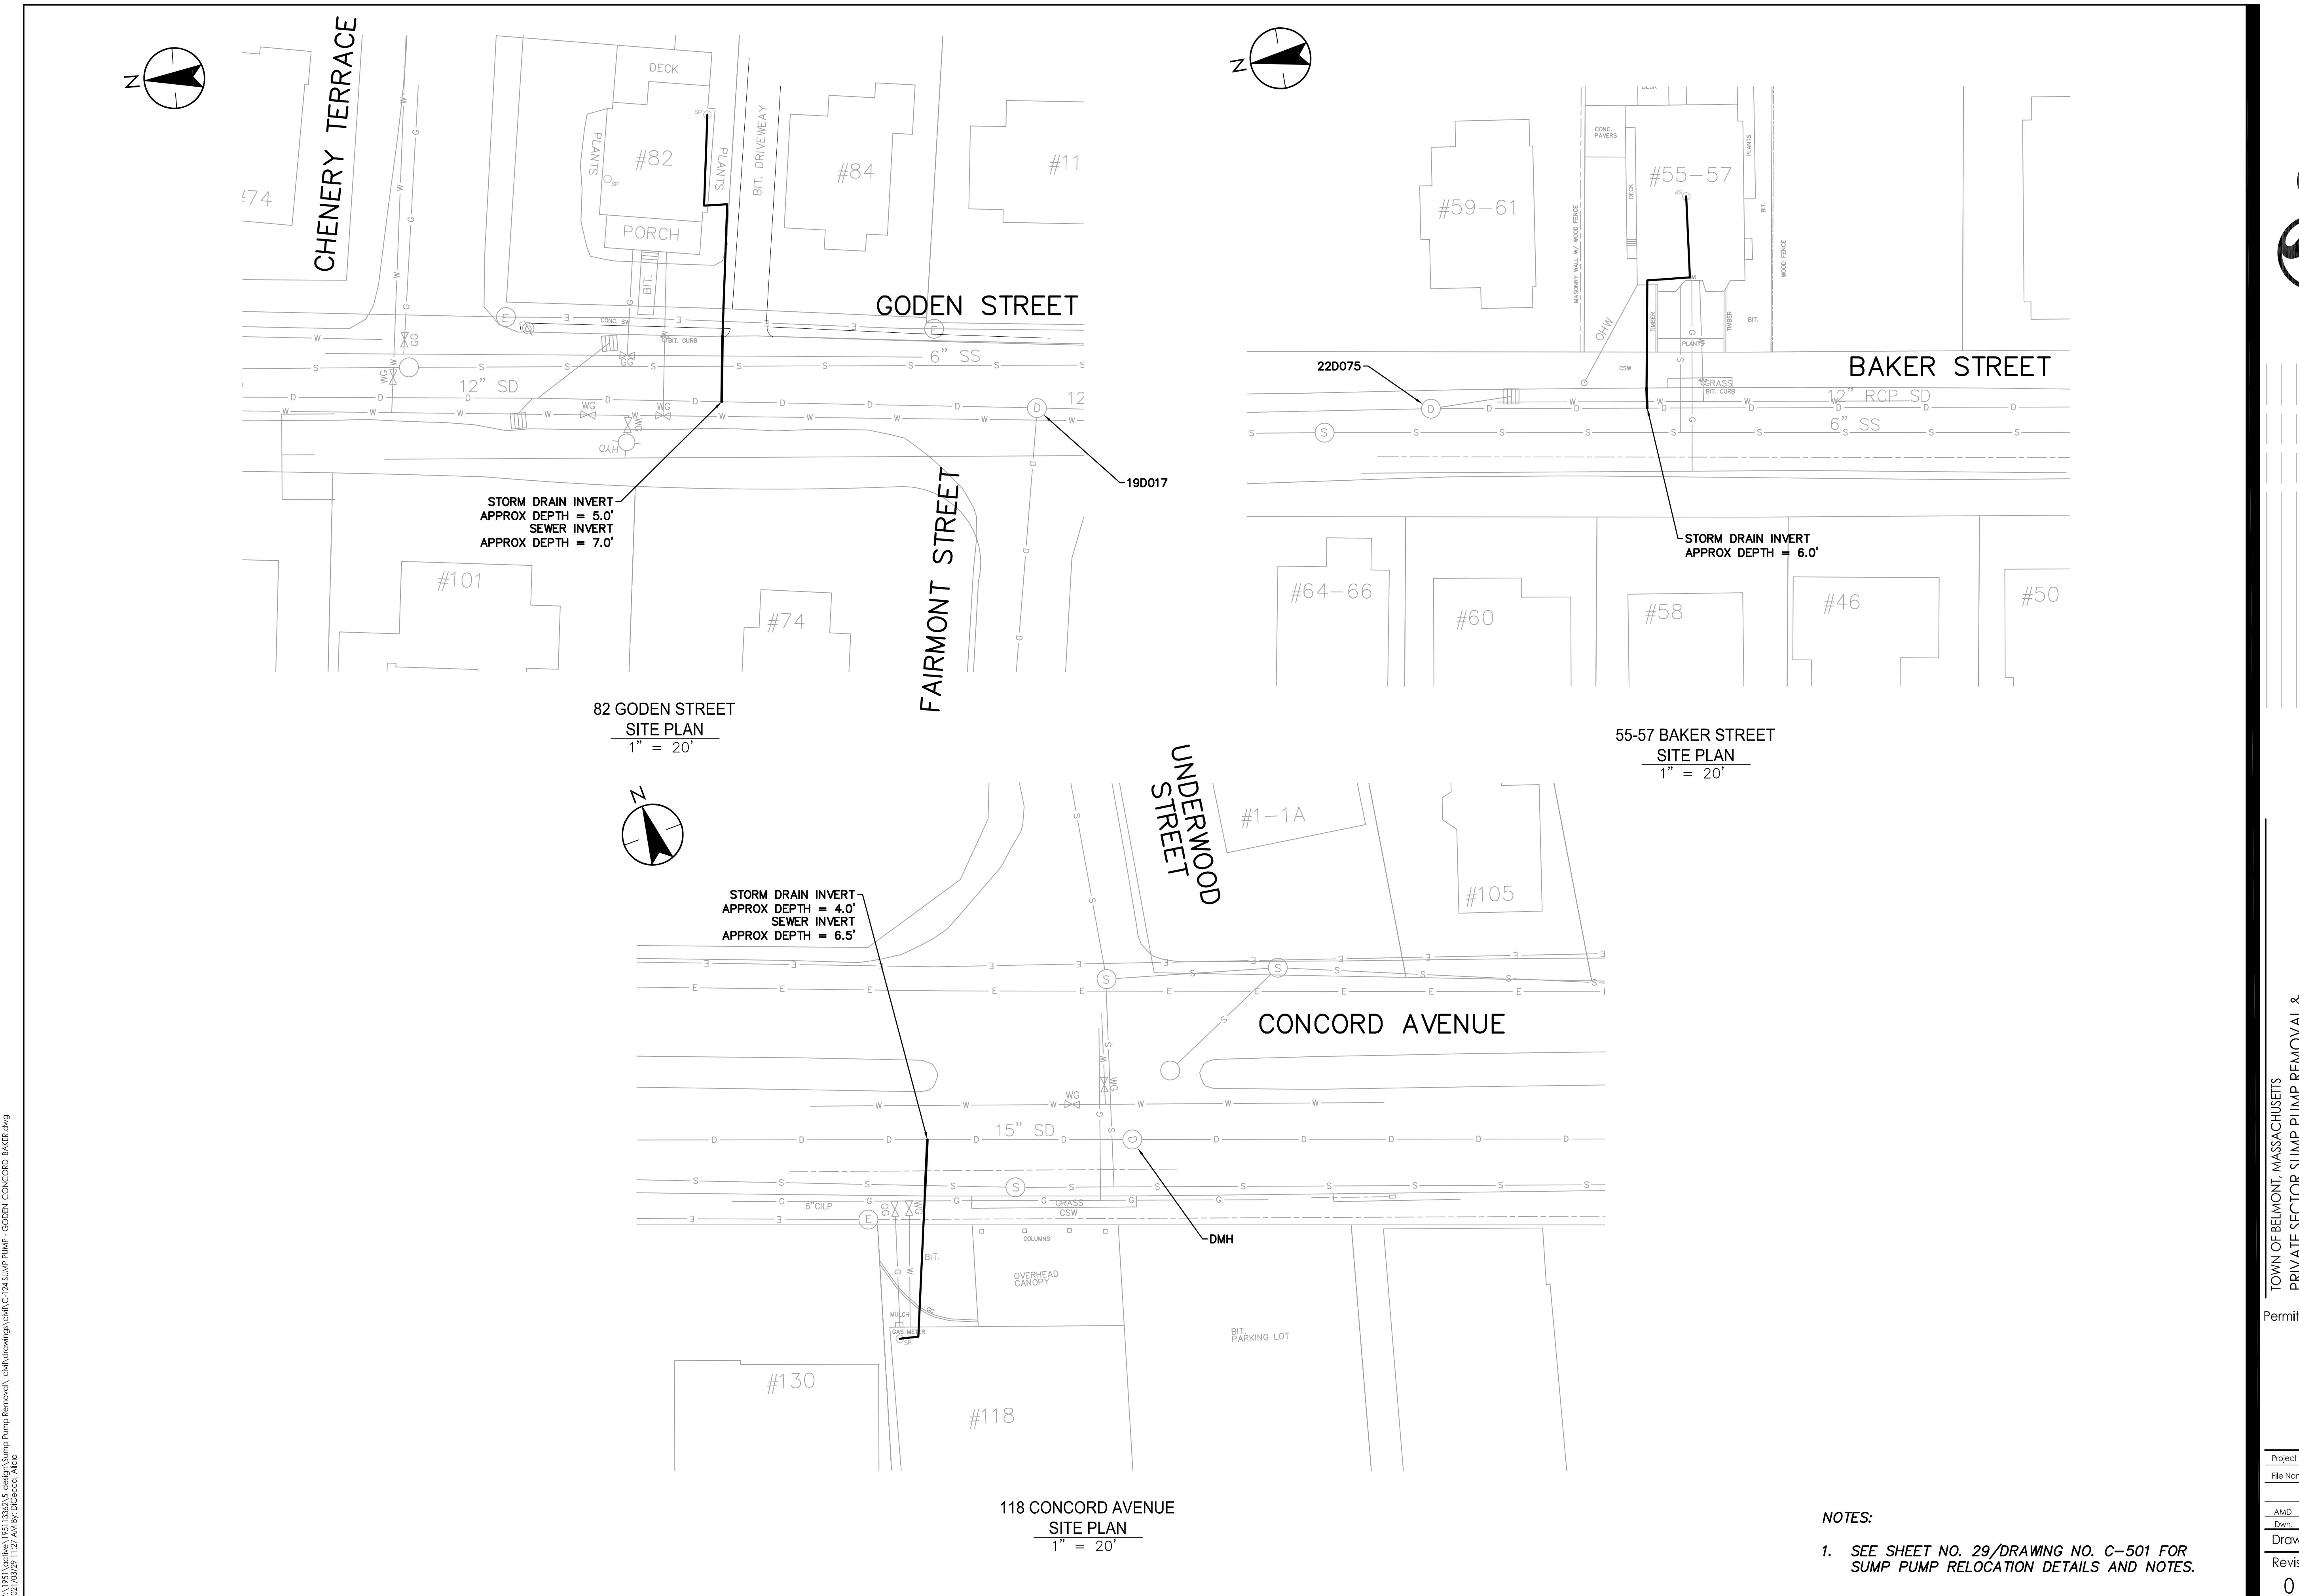

SEWER SYSTEM REHABILITATION  
MWRA PROJECT NO. WRA-P11-04-3-1124 &  
MWRA PROJECT NO. WRA-P-11-04-3-1160  
BELMONT, MASSACHUSETTS  
SUMP PUMP - GODEN ST, CONCORD AVE AND BAKER



Number: 195113362  
ne:  
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RHD RPB 21.03.31  
Chkd. Dsgn. YY.MM.DD  
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ion Sheet  
28 of

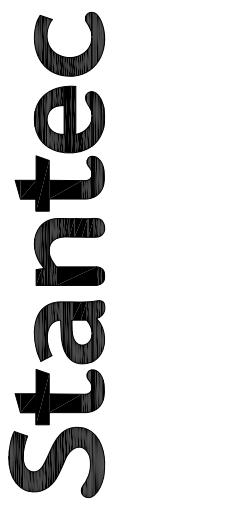





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The drawing - any errors or omissions shall be reported to Stantec without delay.  
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**Street Address**  
**City, Prov/State Country Code/Zip**  
[www.starhtec.com](http://www.starhtec.com)

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The drawings, any errors or omissions, shall be reported to Stantec without delay.  
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**33 BETTS ROAD  
SITE PLAN**

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## NOTES:


1. SEE SHEET NO. 29/DRAWING NO. C-501 FOR SUMP PUMP RELOCATION DETAILS AND NOTES.

WRA PROJECT NO WRA-P11-04-3-1124 &  
TOWN OF BELMONT, MASSACHUSETTS  
PRIVATE SECTOR SUMP PUMP REMOVAL &  
SEWER SYSTEM REHABILITATION

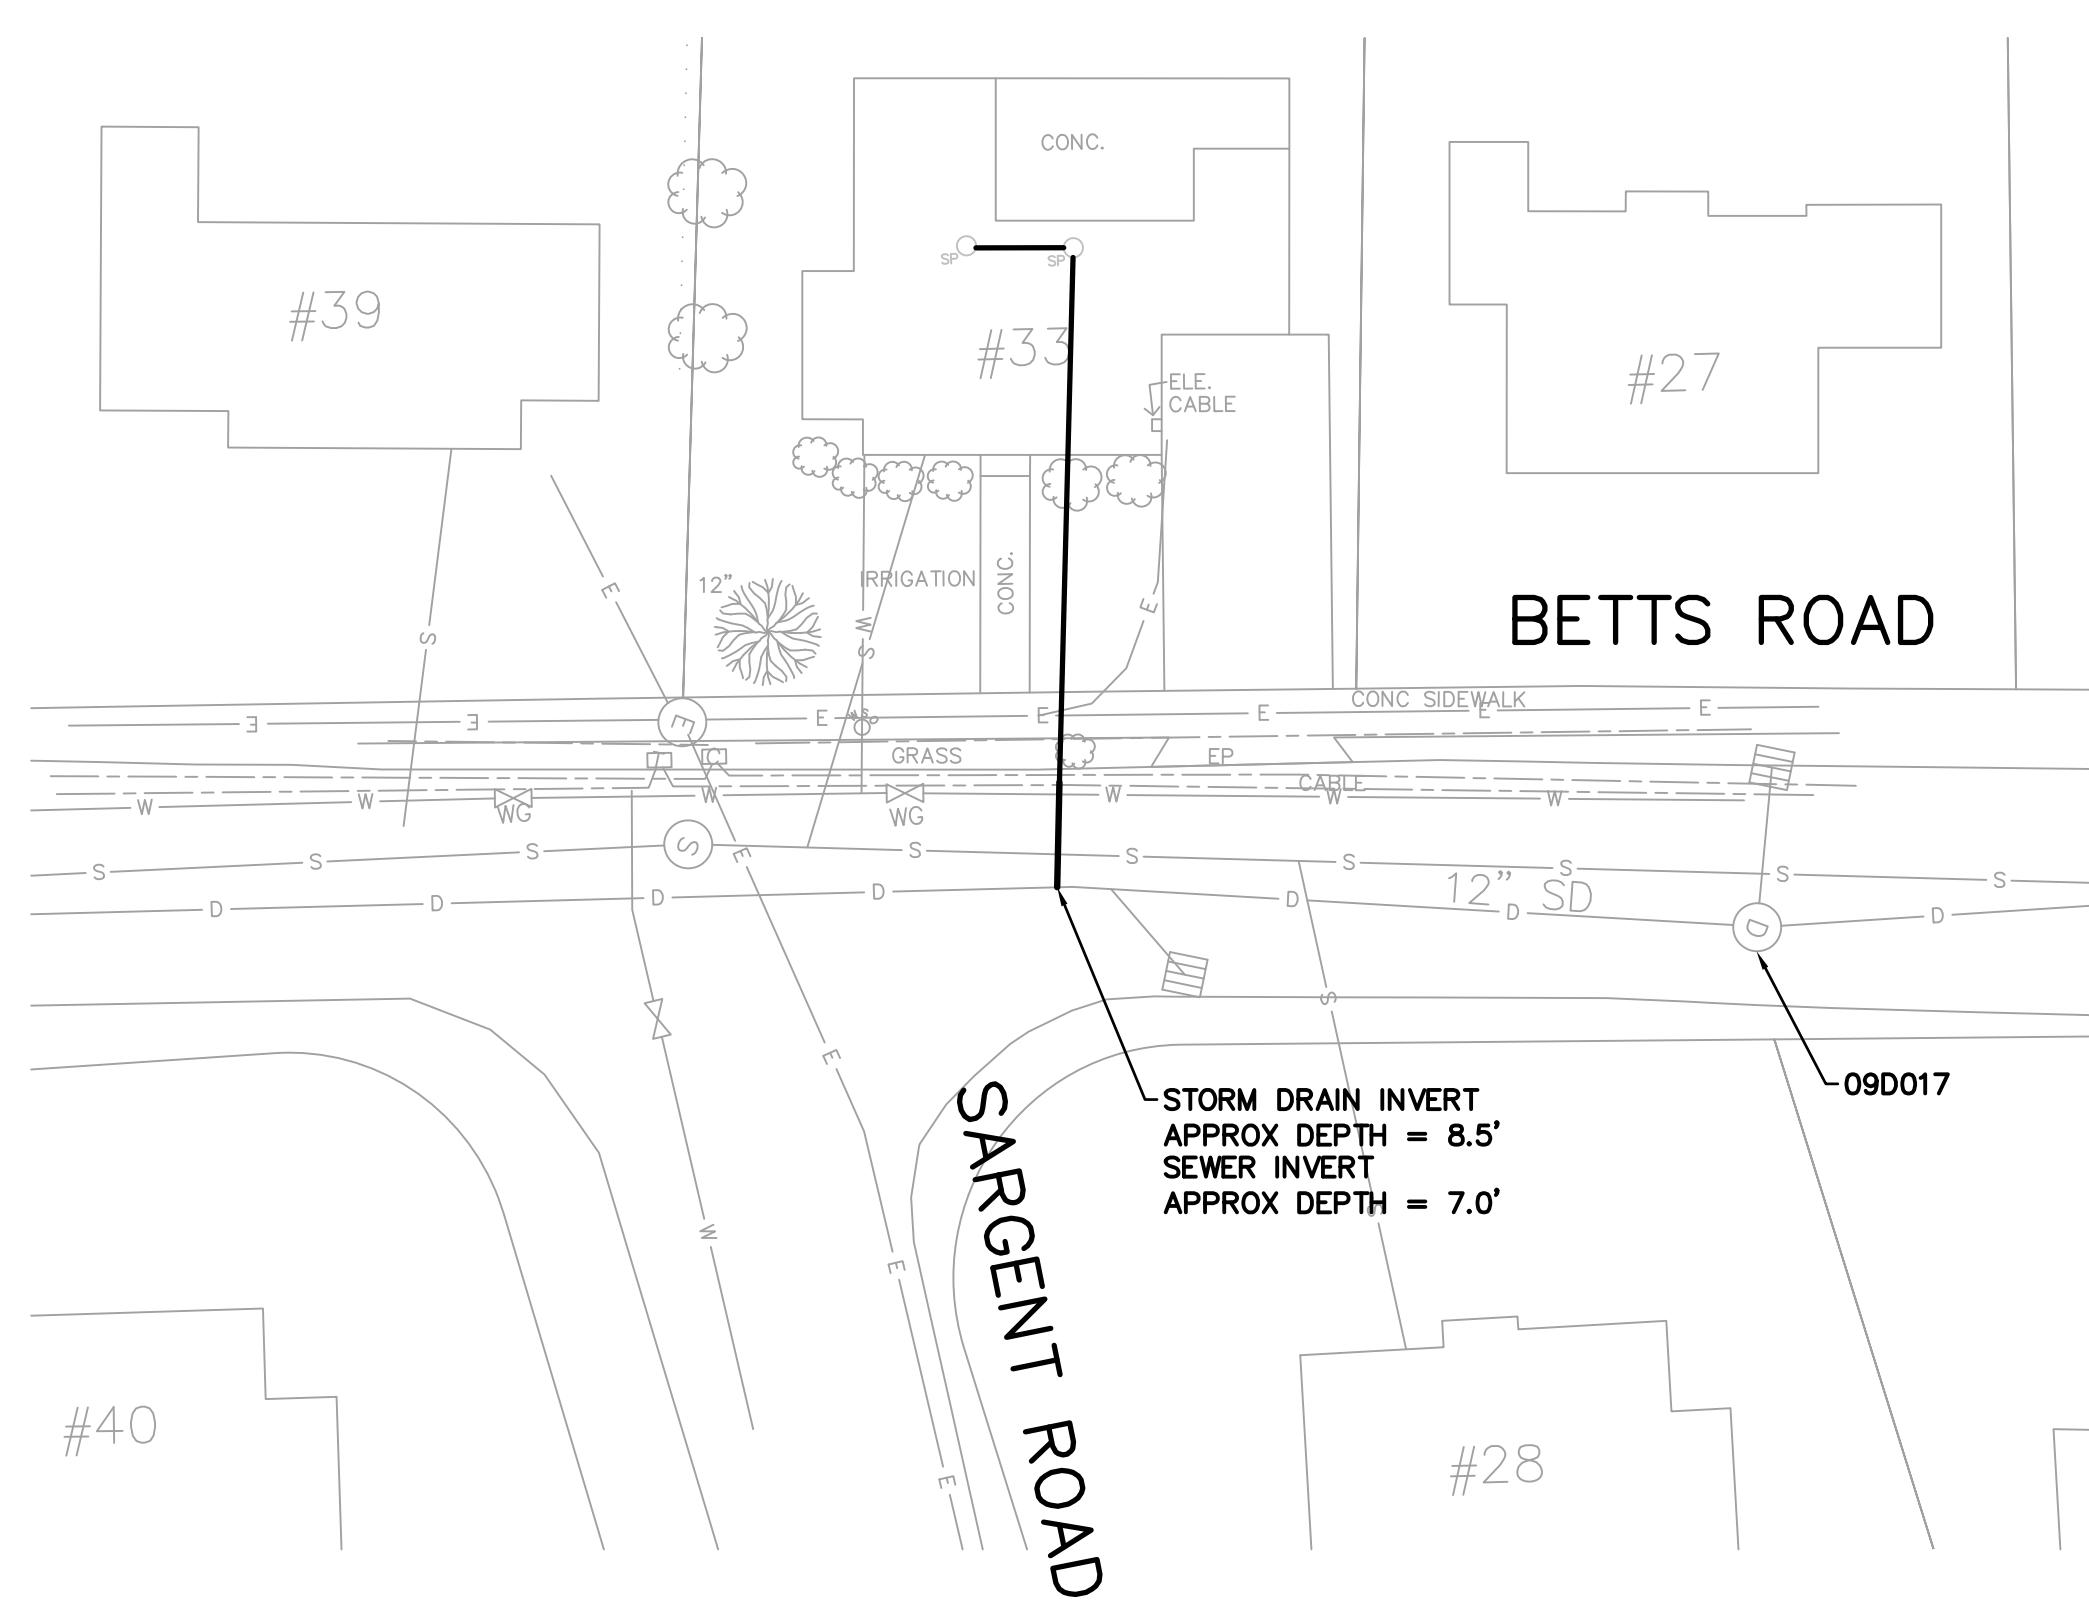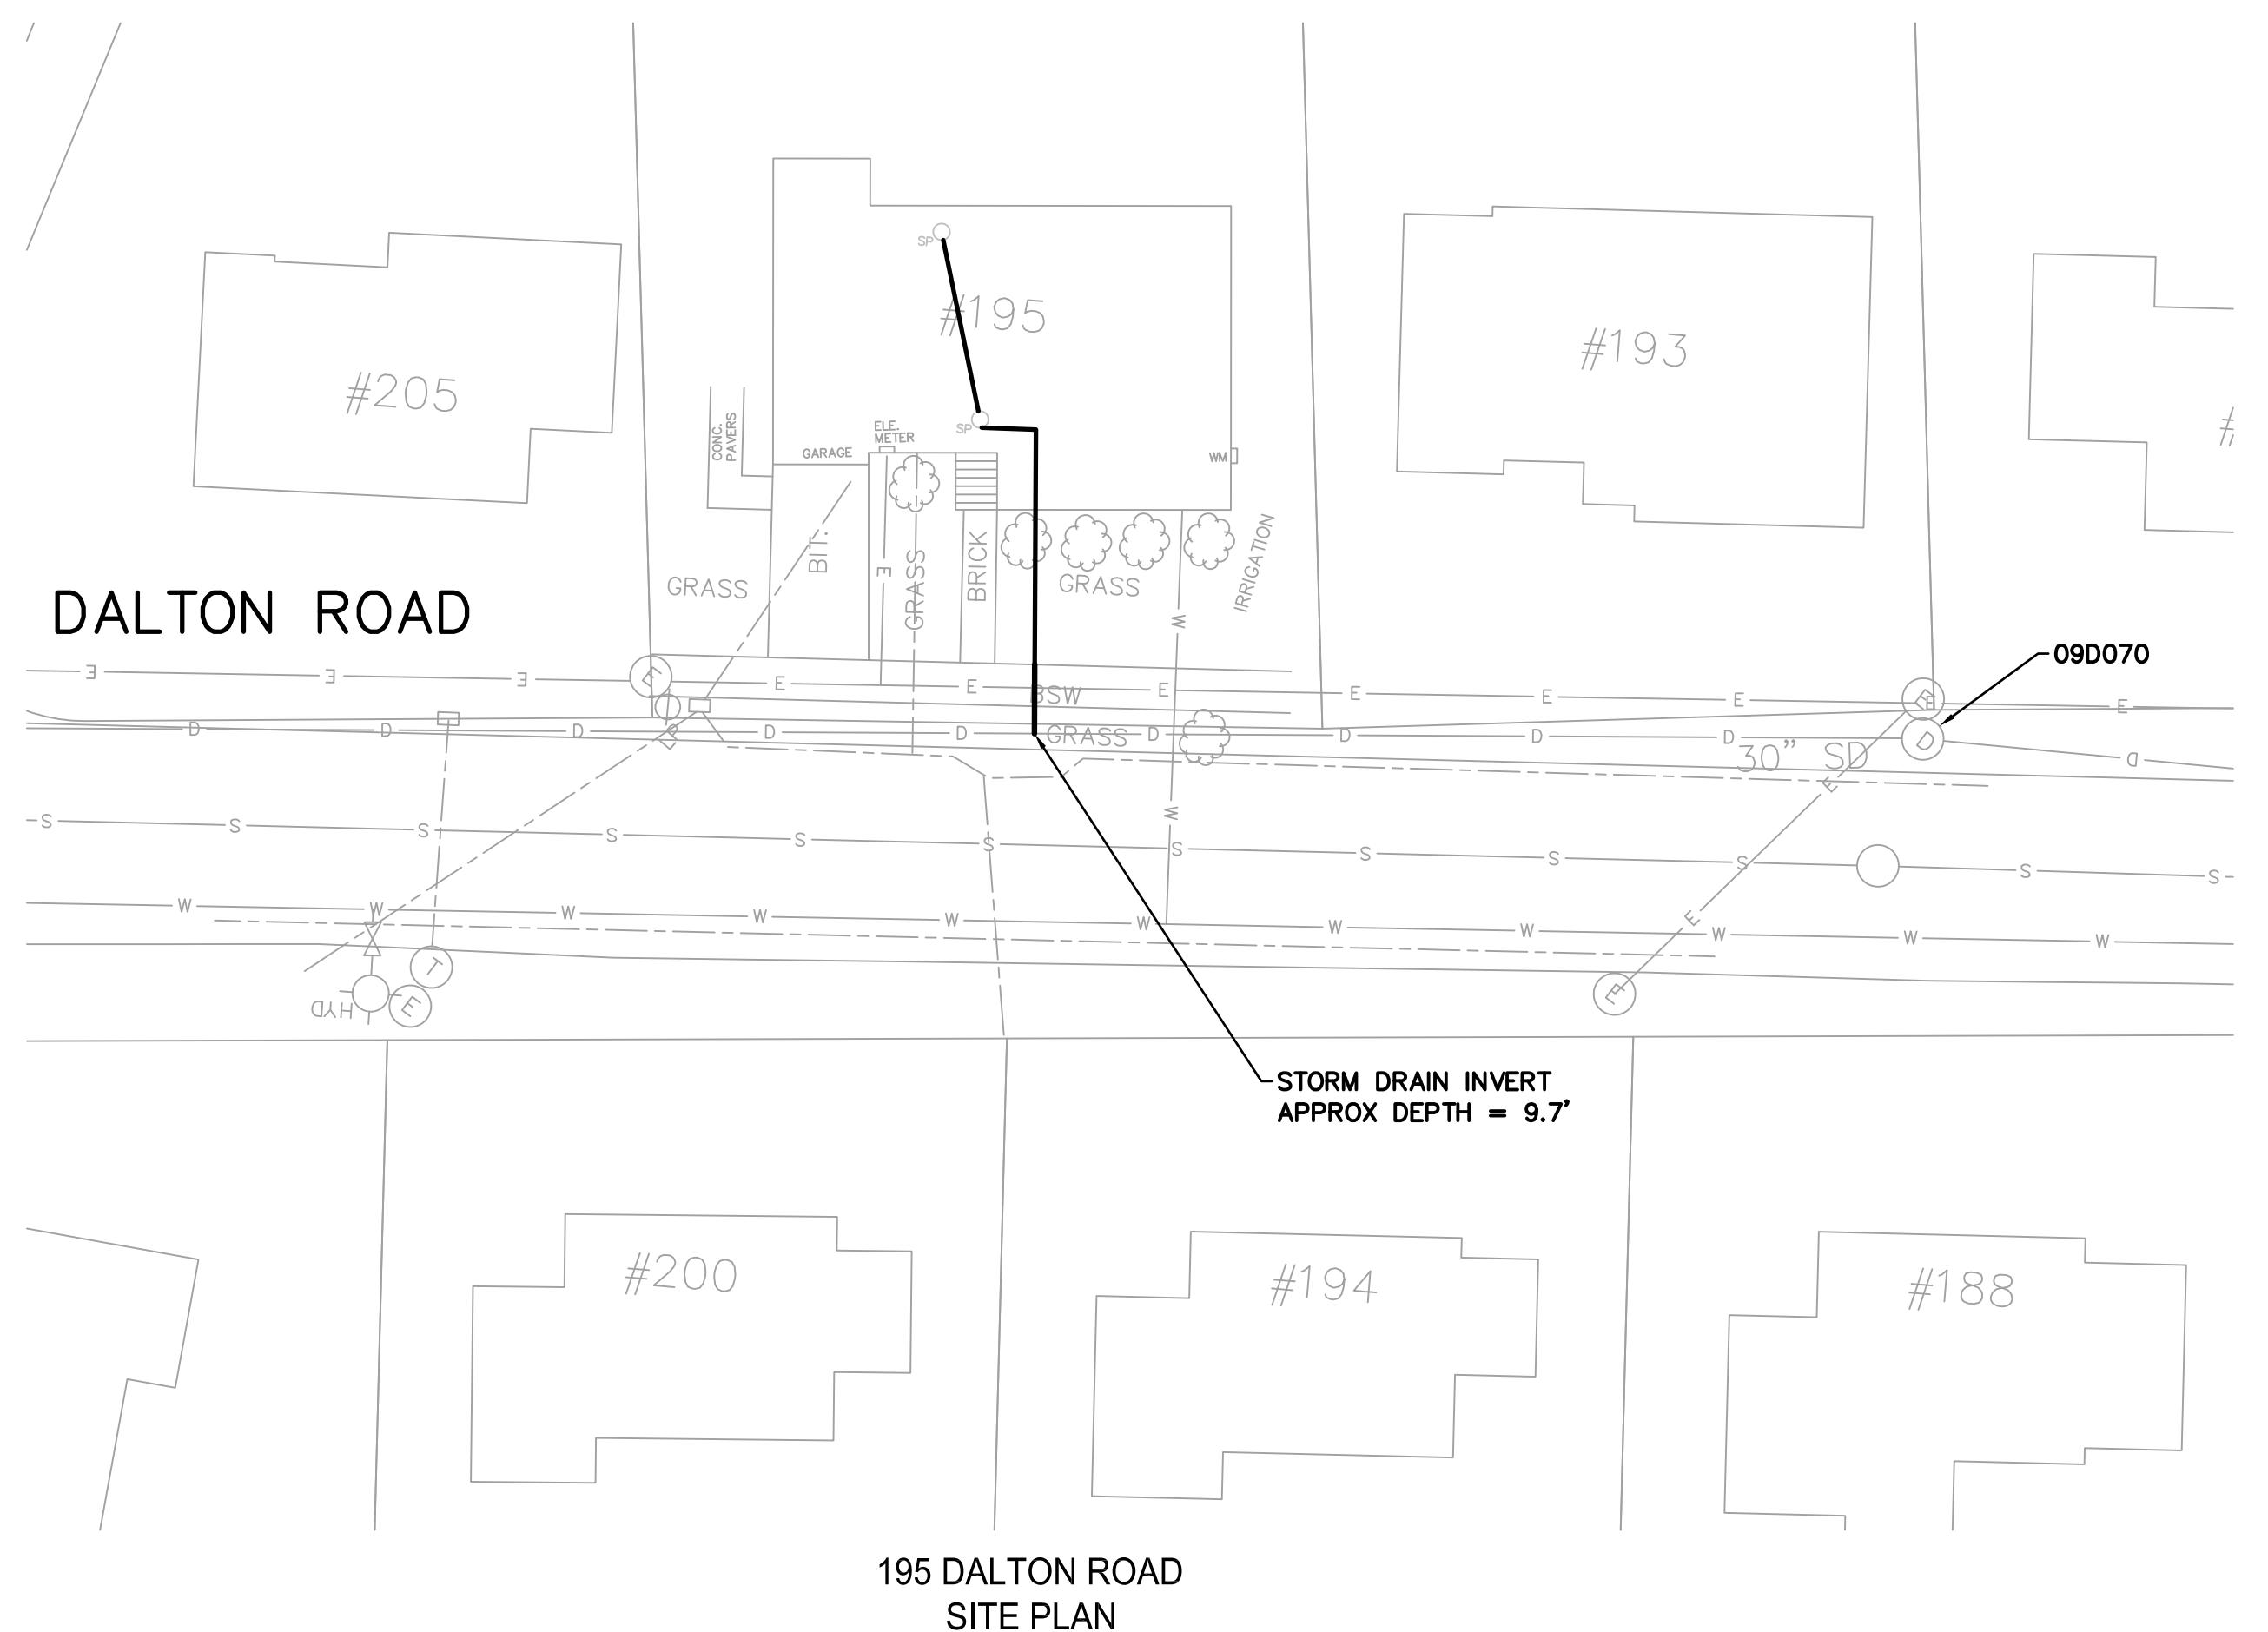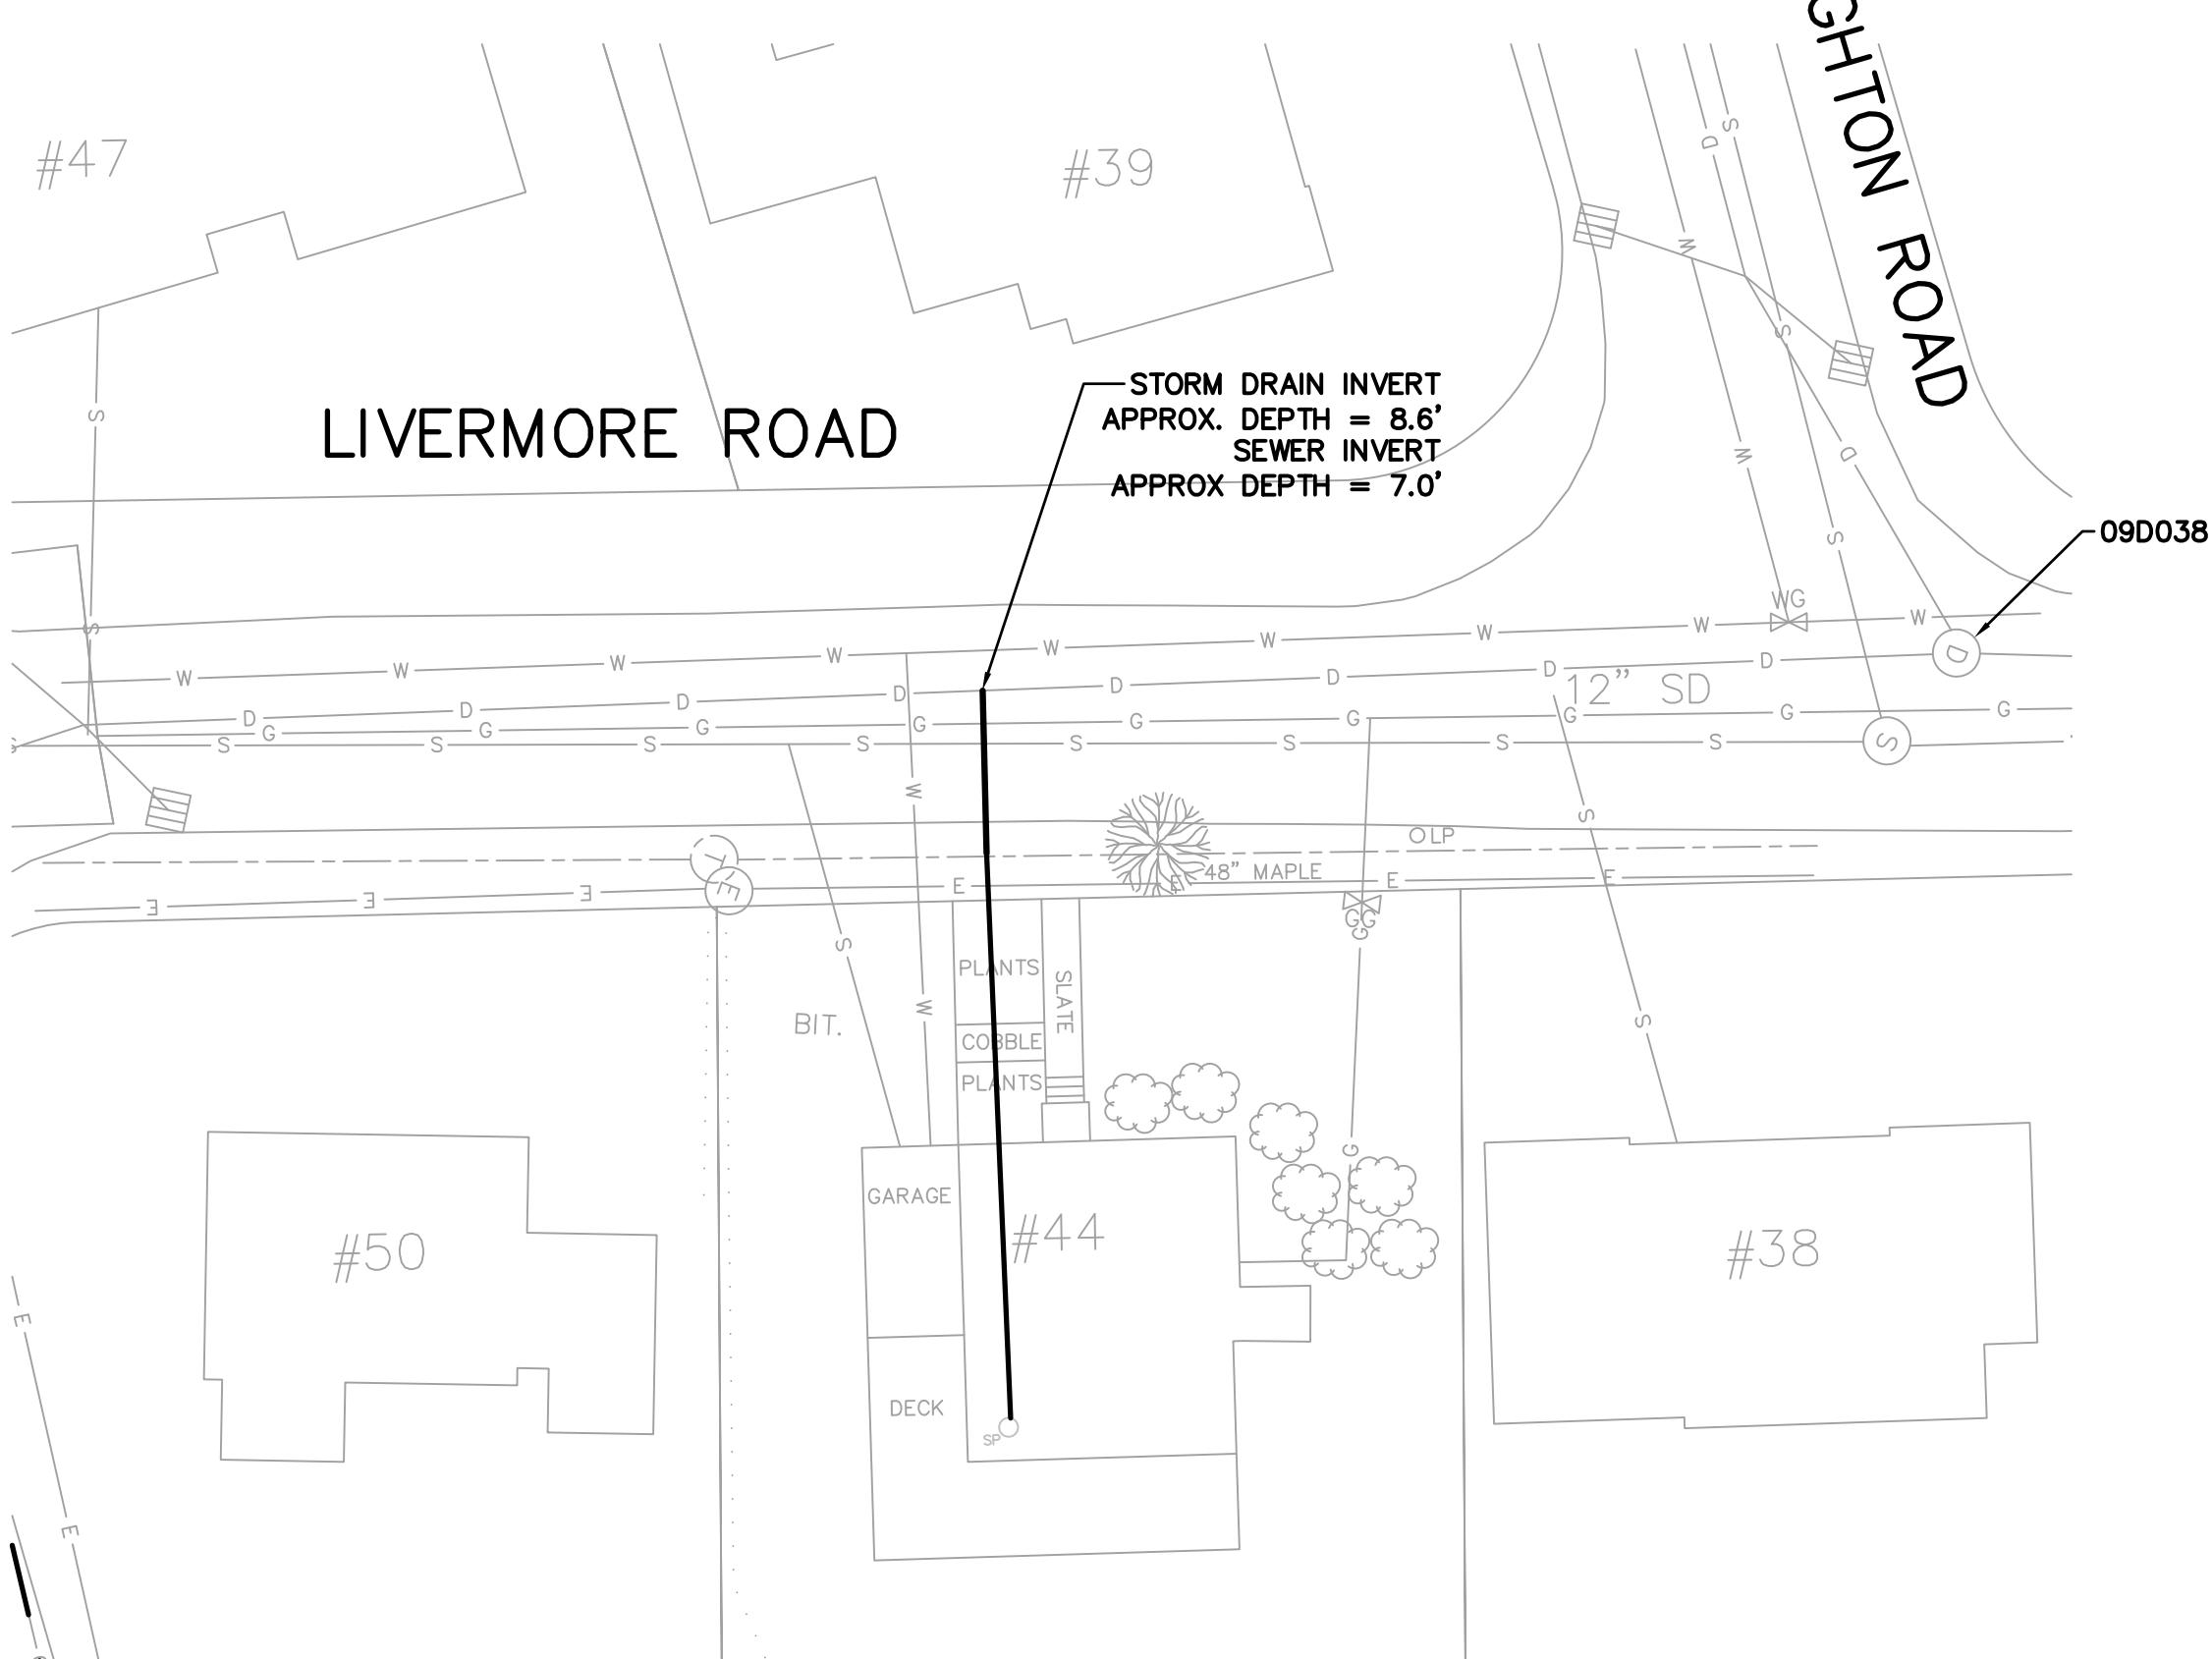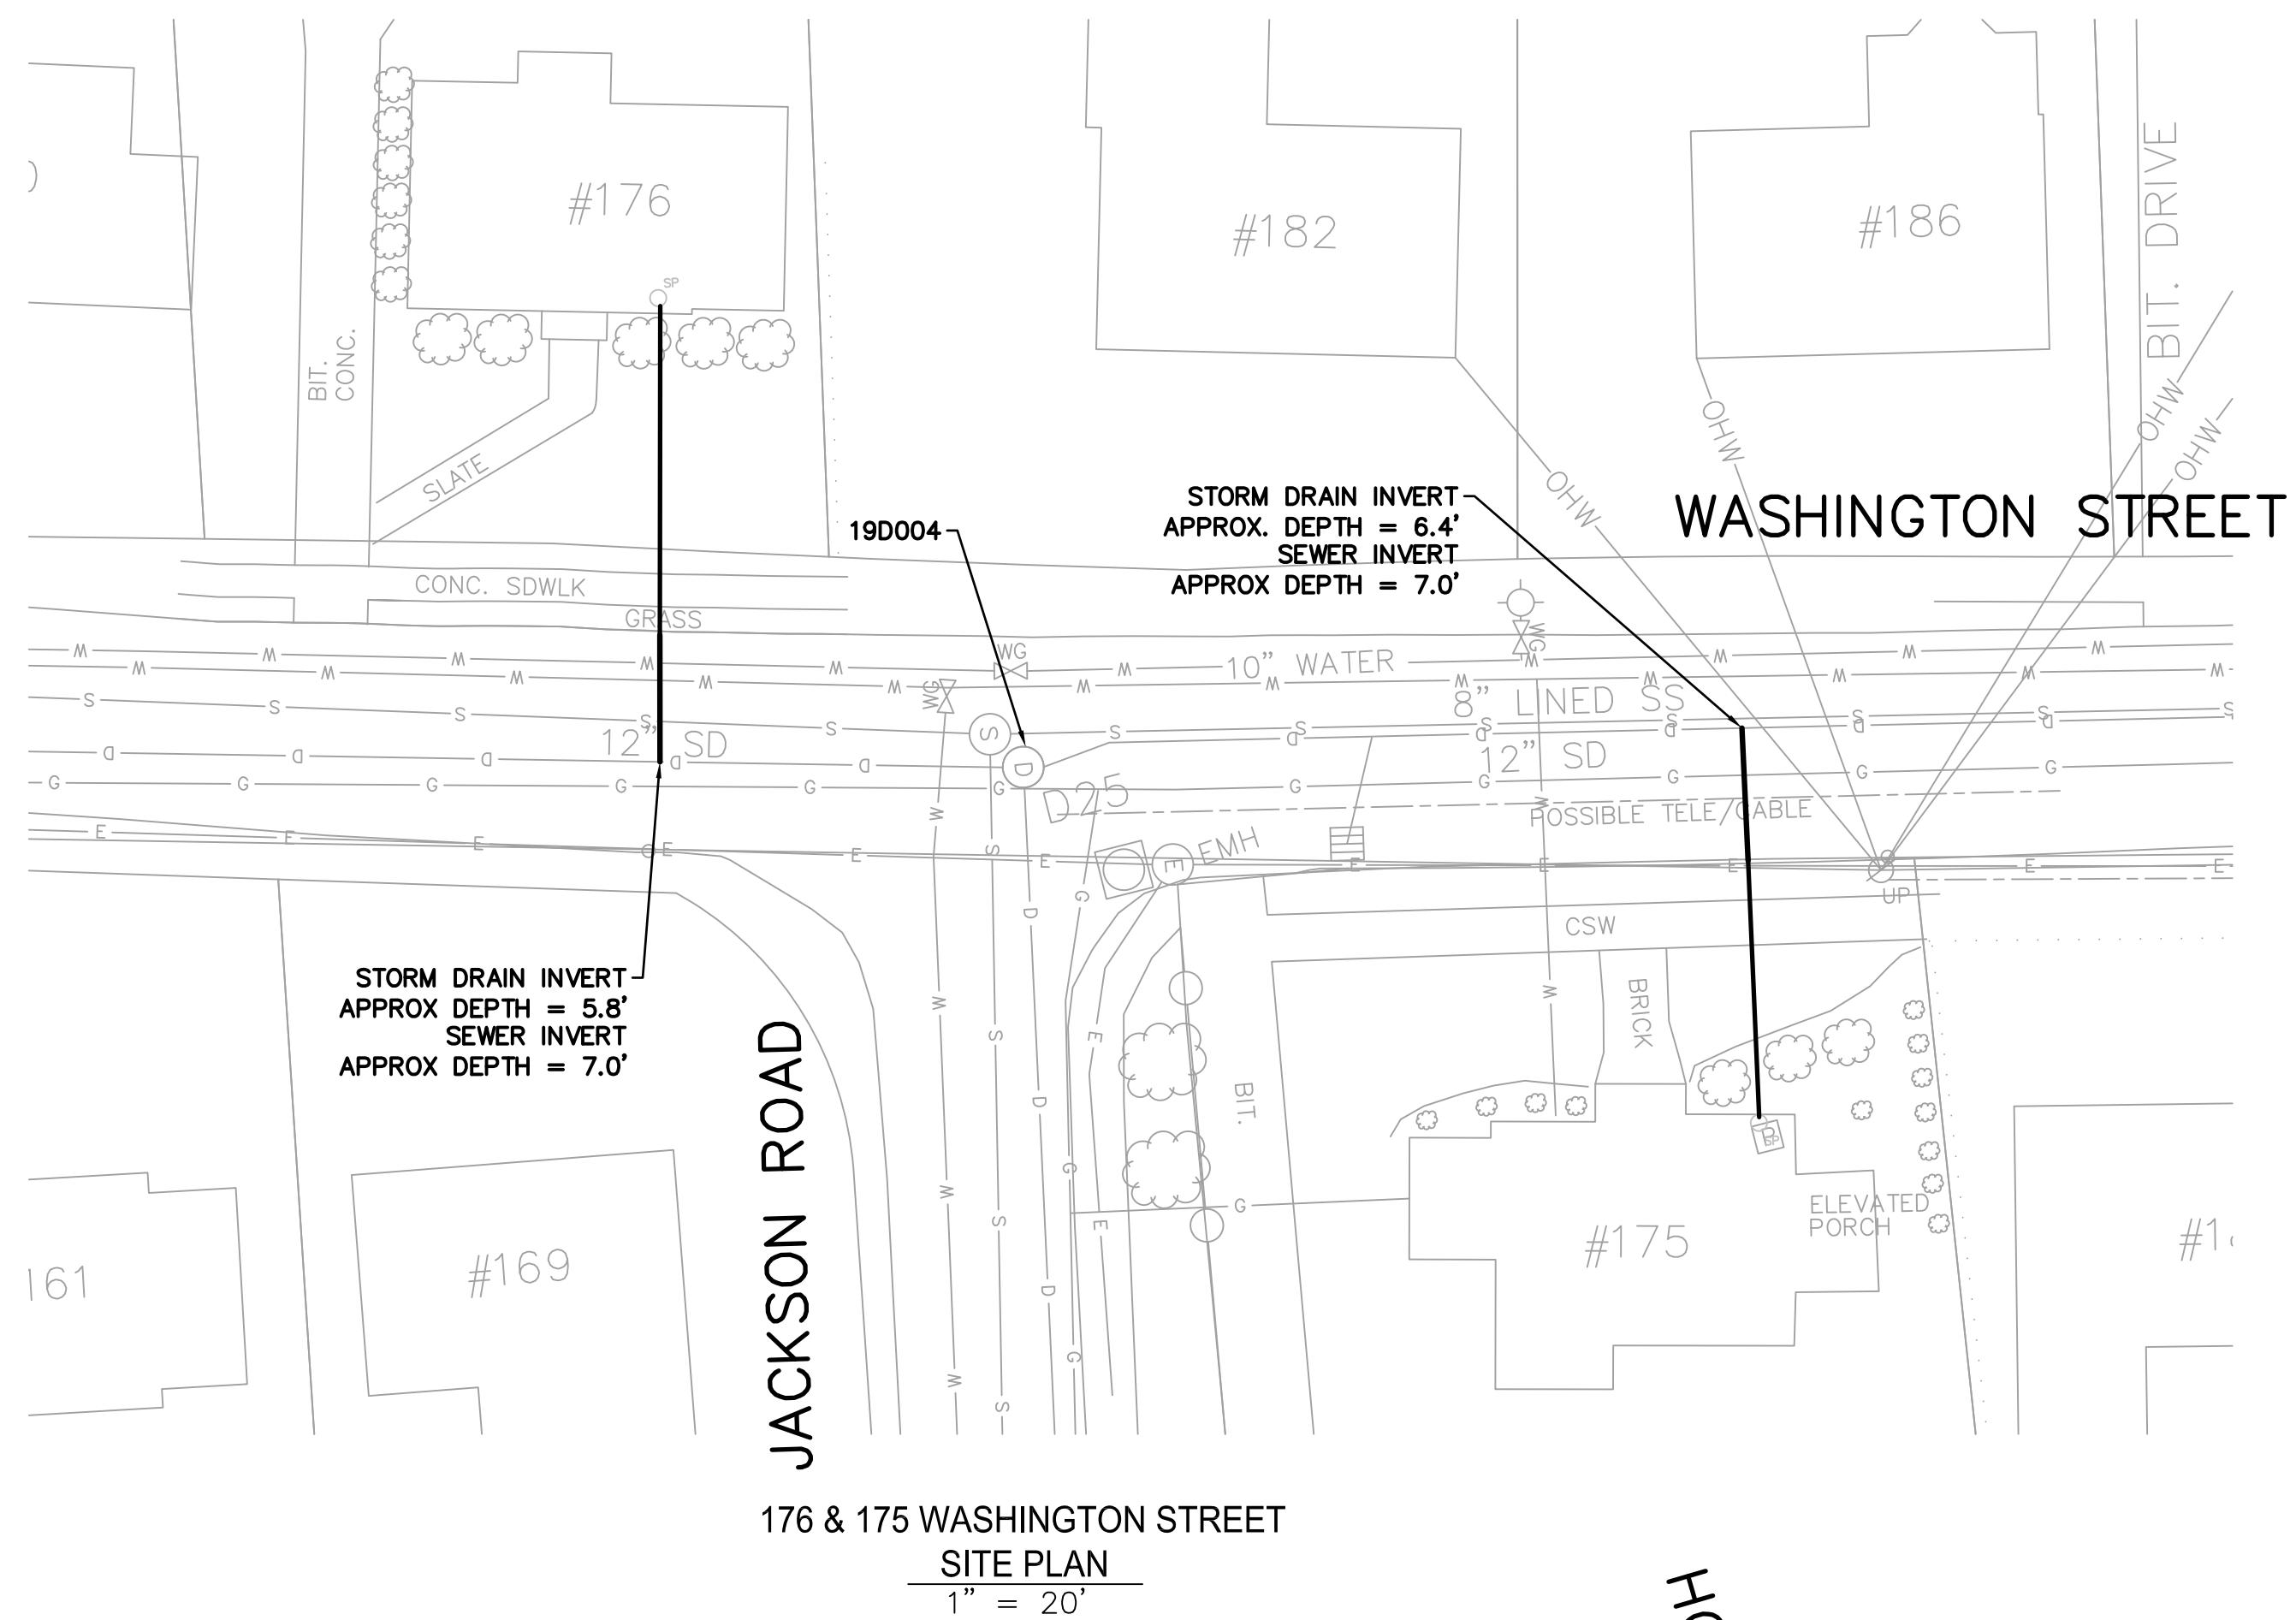MWRA PROJECT NO. WRA-P-11-04-3-1160

SUMP PUMP - WASHINGTON ST DALTON RD (IVERMOR  
BELMONT, MASSACHUSETTS

SUMMER 2011 - WEDNESDAY, JULY 20, 2011 • VOLUME 40, NUMBER 3

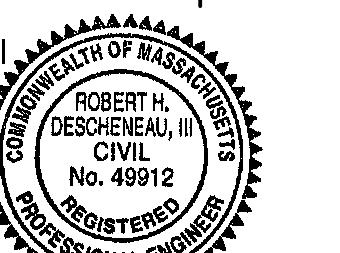

er: 195113362

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HD RPB 21.03.31




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No. C-125

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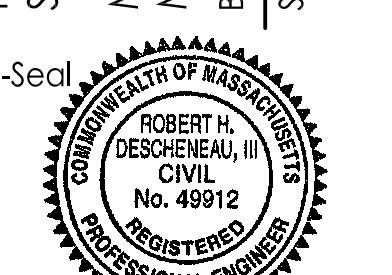
29 of

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## NOTES:

- SEE SHEET NO. 29/DRAWING NO. C-501 FOR  
SUMP PUMP RELOCATION DETAILS AND NOTES.

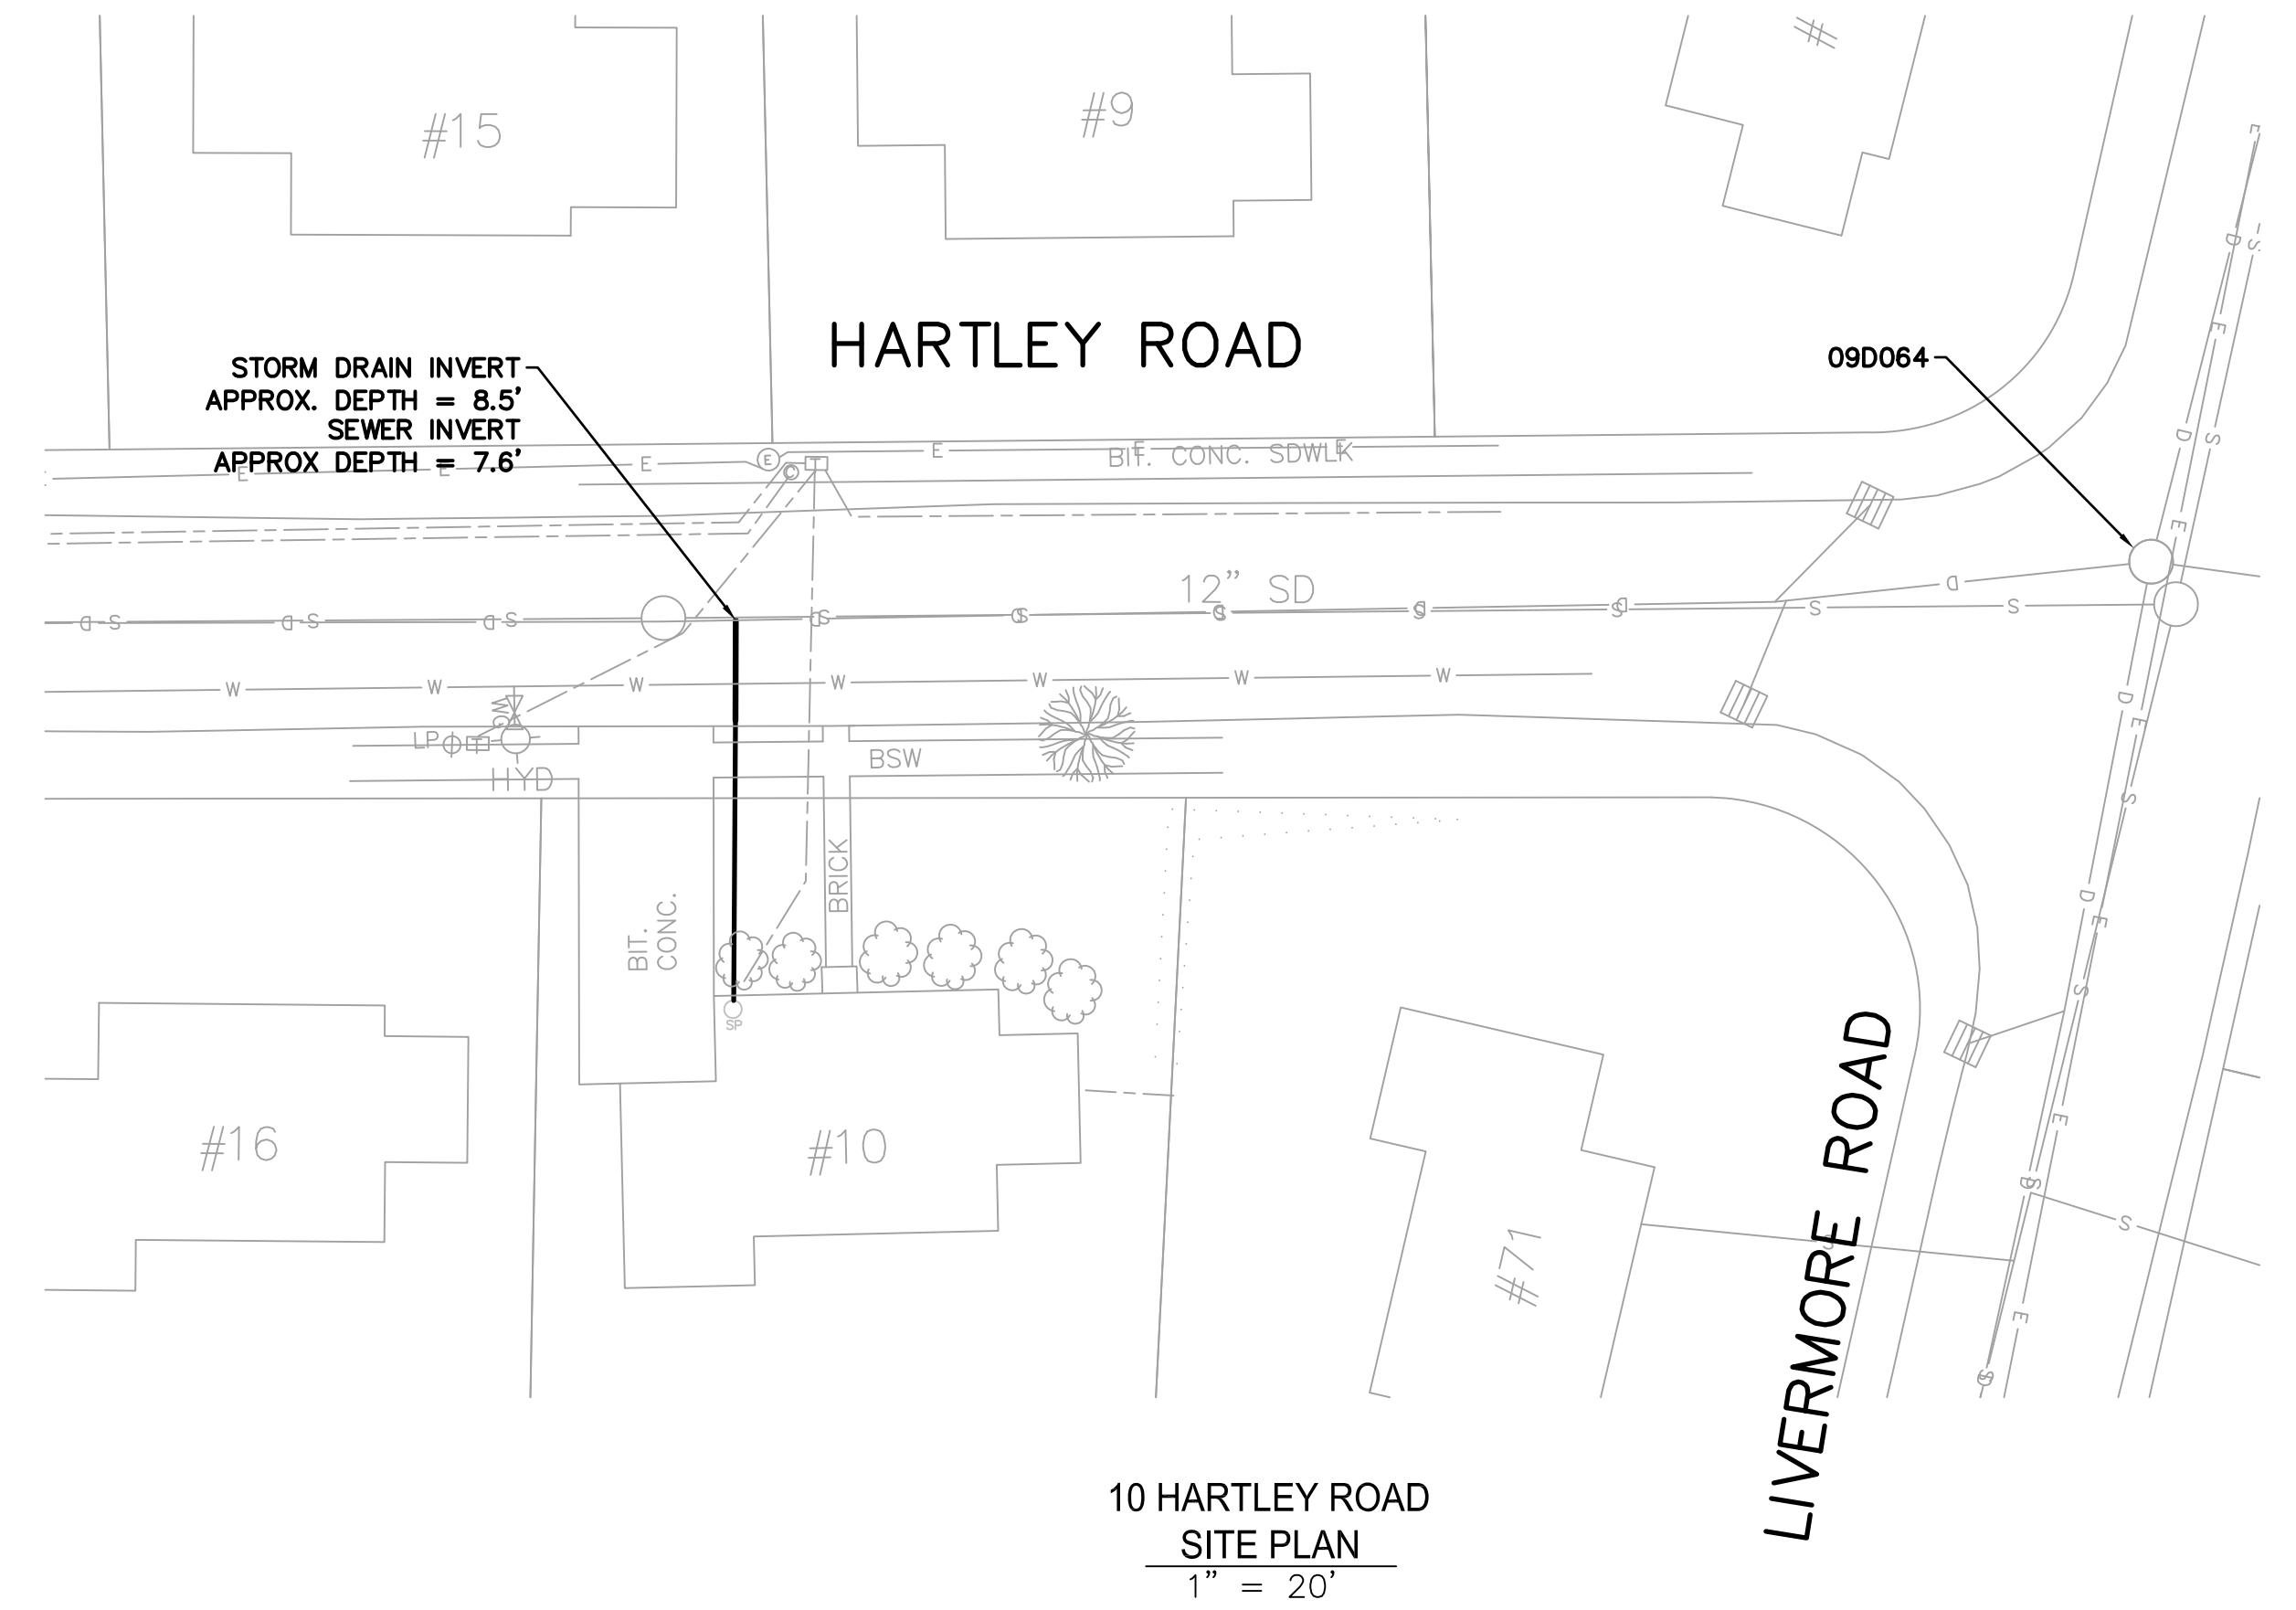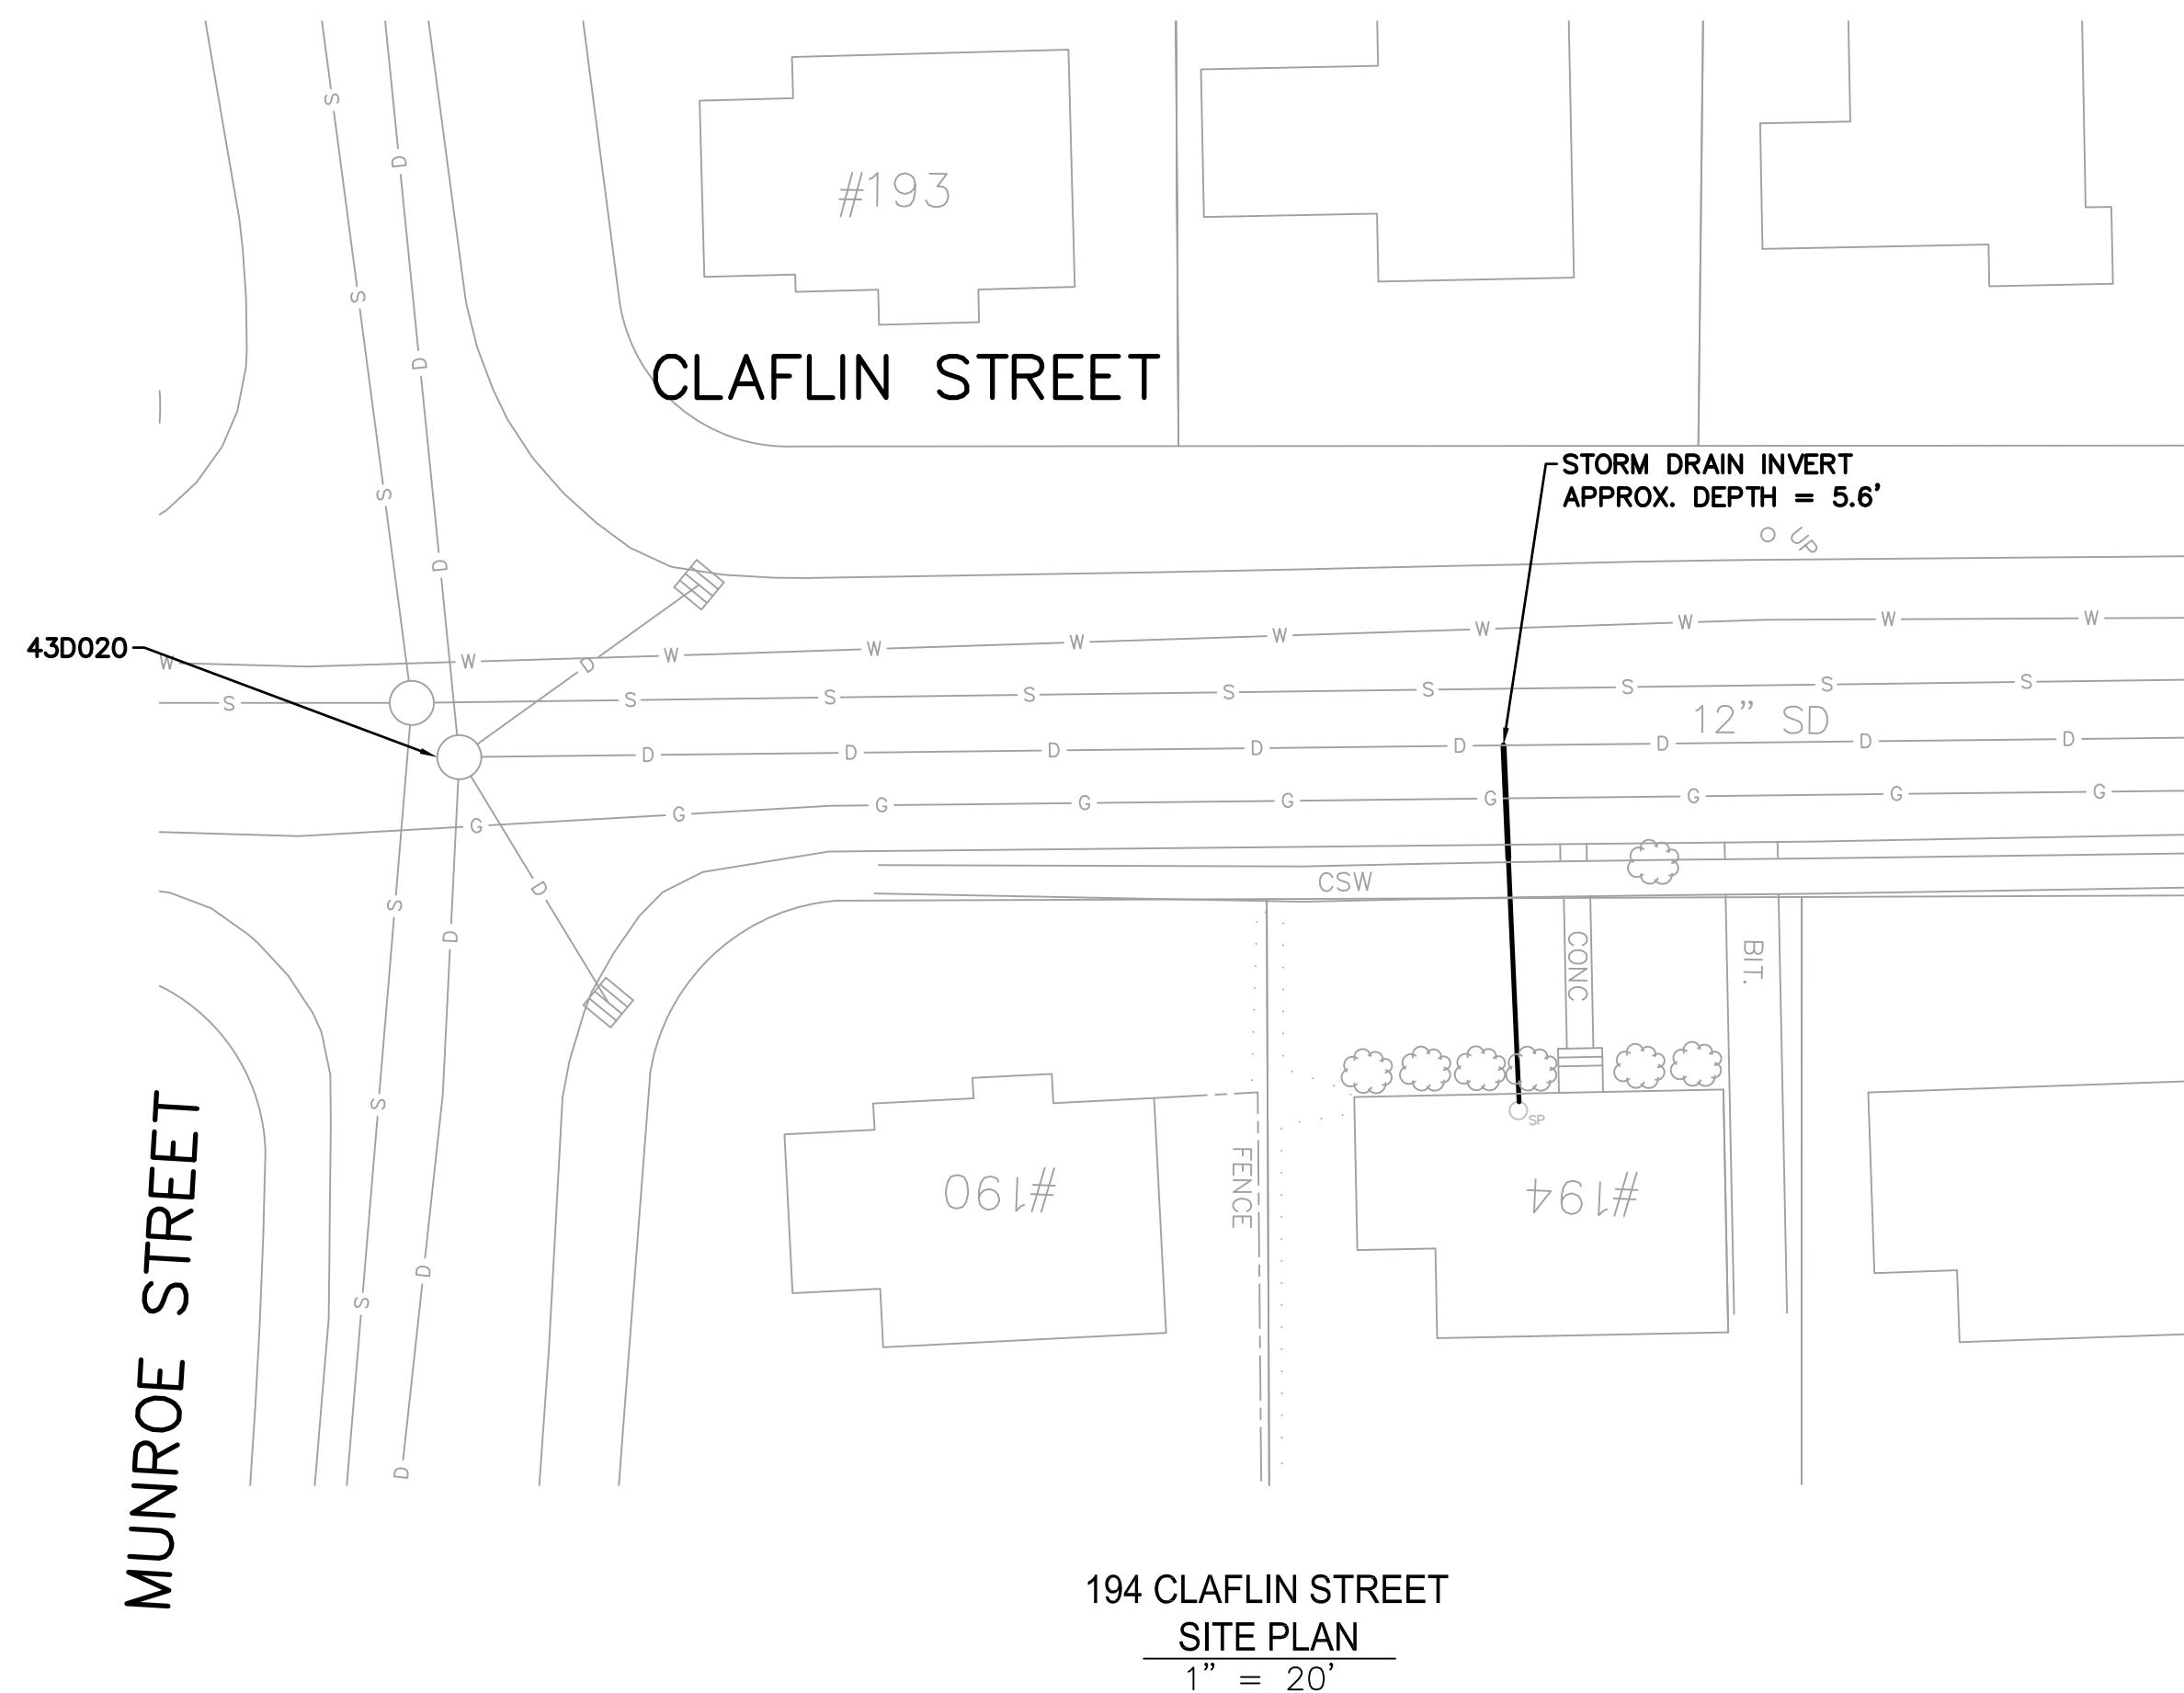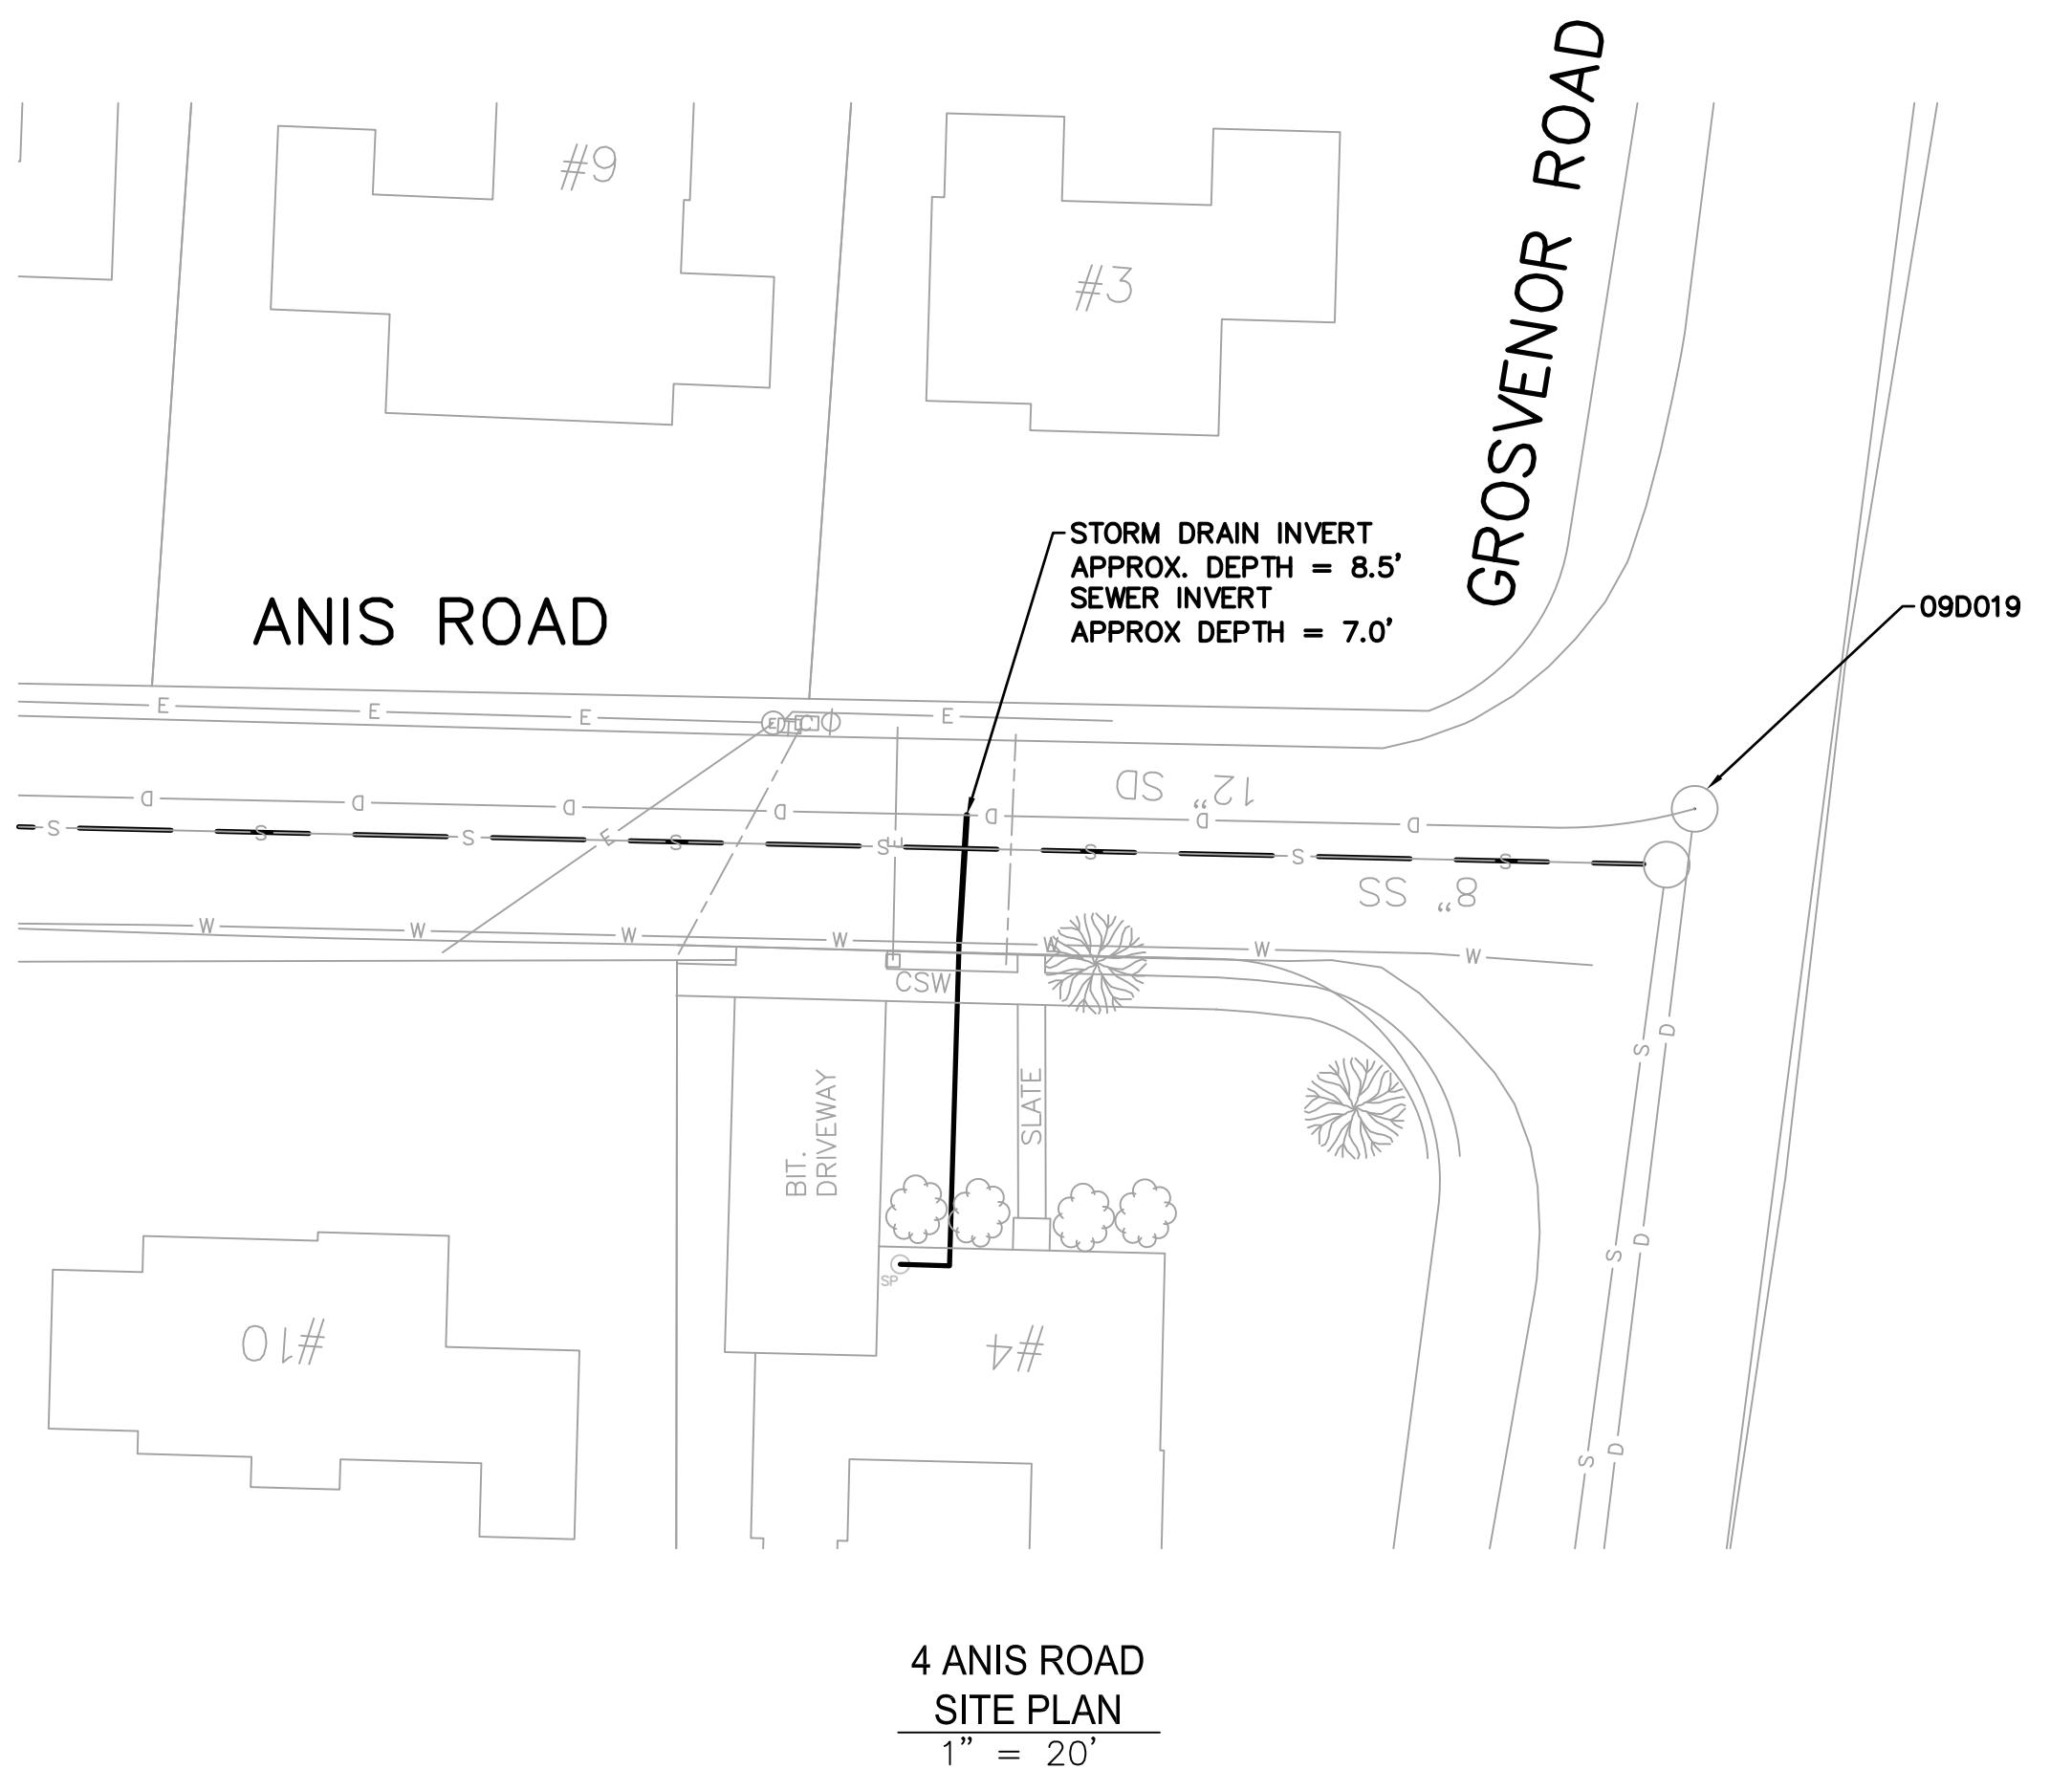

Object Number: 195113362

Name: \_\_\_\_\_

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MD RHD RPR 21.03.31


VID	RTHD	RFB	
wn.	Chkd.	Dsgn.	YY.MM.DD

rawing No. C-126

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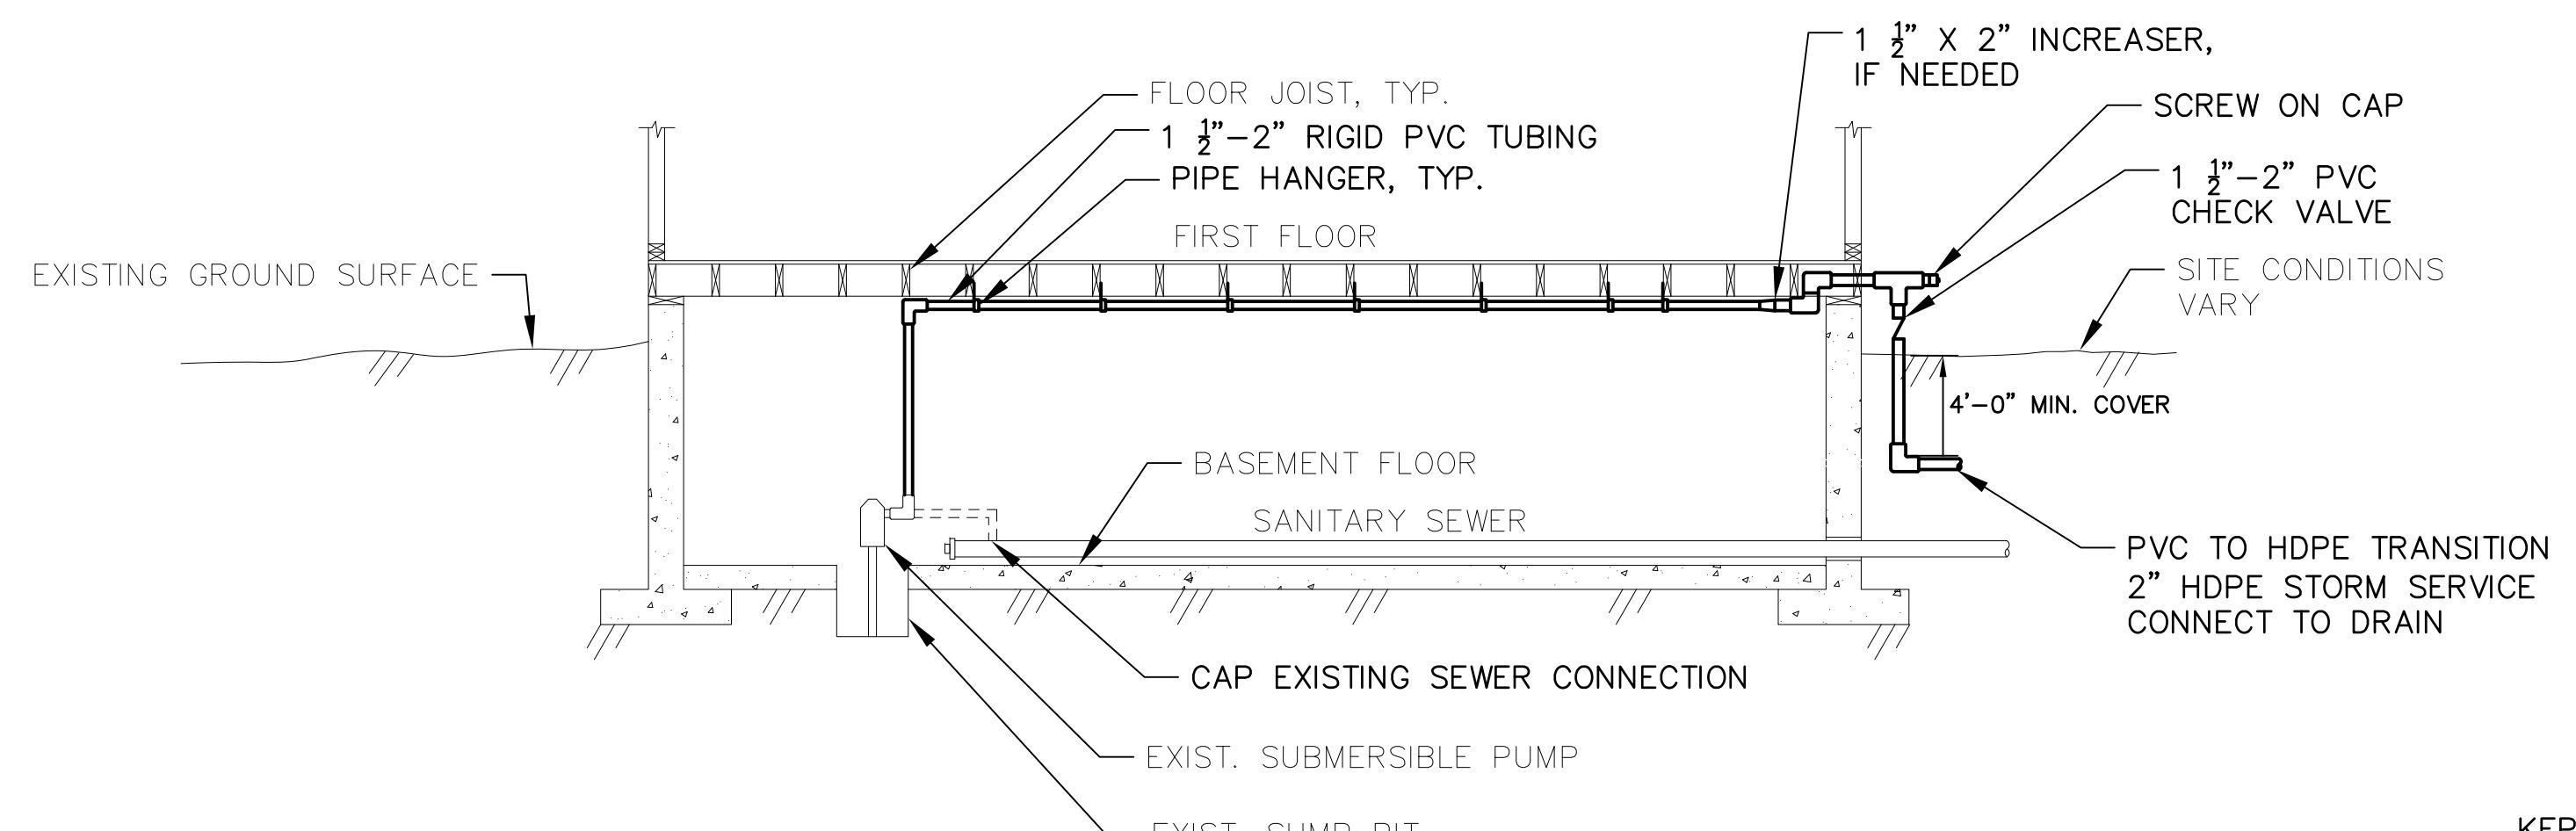
# revision Sheet

0 30 of

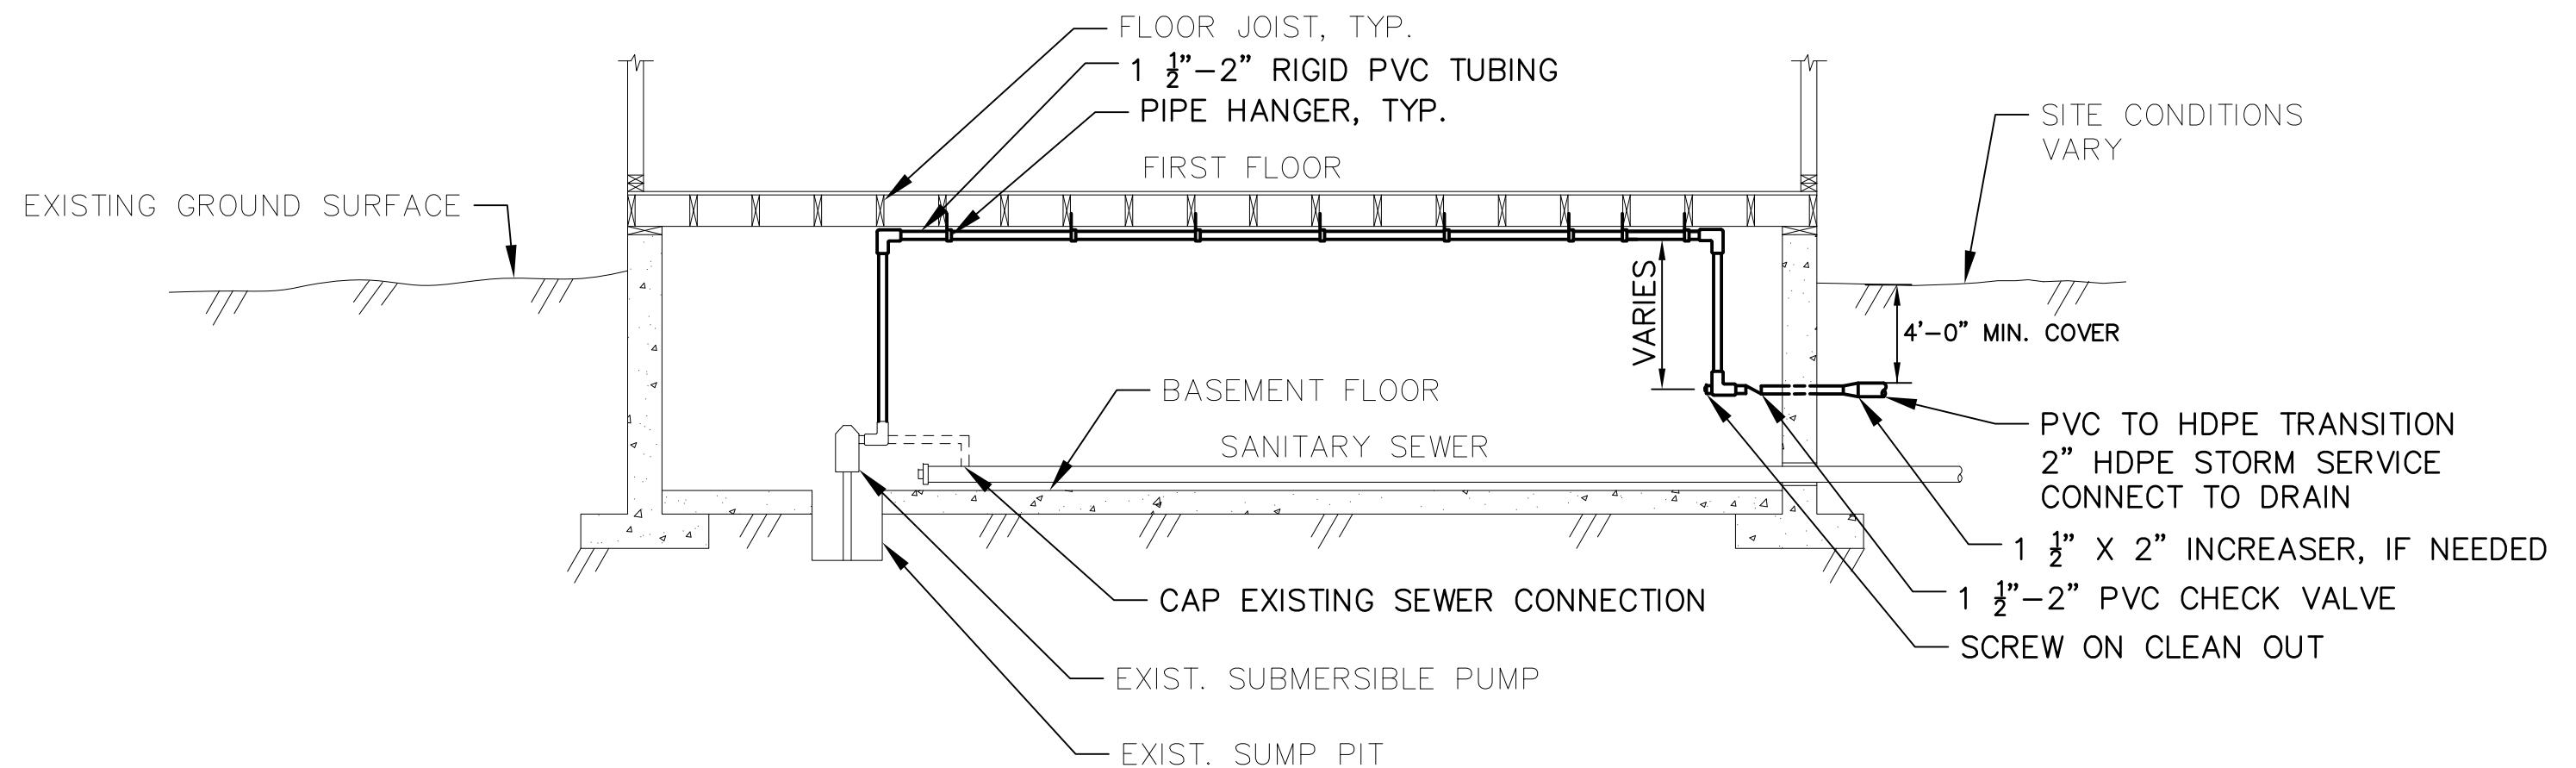

**ILLUSTRATIVE SUMP PUMP CONNECTION  
ALTERNATIVE 1**

NOT TO SCALE



**ILLUSTRATIVE SUMP PUMP CONNECTION  
ALTERNATIVE 2**


NOT TO SCALE

**SUMP PUMP RELOCATION & CONNECTION NOTES:**

- PRIOR TO STARTING ANY WORK, THE CONTRACTOR SHALL CONDUCT AN INTERNAL/EXTERNAL INSPECTION OF THE PLUMBING AND SITE CONDITIONS AT ALL LOCATIONS TO CONFIRM PIPING PLACEMENT, ALIGNMENT, SIZES, ETC. COORDINATE INSPECTIONS WITH THE HOMEOWNER, TOWN AND ENGINEER.
- THE CONTRACTOR SHALL PROVIDE A LICENSED PLUMBER TO PERFORM BUILDING INFLOW REMOVAL WORK GOVERNED BY 248 CMR 10.00: UNIFORM STATE PLUMBING CODE. THE CONTRACTOR SHALL PROVIDE ALL COUPLINGS, FITTINGS, VALVES AND CLEANOUTS AS REQUIRED BY 248 CMR 10.00.
- DRAIN TO EXIT THROUGH FOUNDATION WALL AS SHOWN OR AS DIRECTED BY ENGINEER.
- 2" HDPE TO 6" PVC TRANSITION TO BE MADE AT EDGE OF ROADWAY.
- ALL WALL/BRICK MANHOLE/CONCRETE CULVERT PENETRATIONS, PIPE FITTINGS AND JOINTS TO BE SEALED WATERTIGHT.
- ALL VALVES AND SPECIAL FITTINGS SHALL BE AS APPROVED BY ENGINEER.
- MINIMUM COVER FOR 2" HDPE PIPE SHALL BE 4'. SLOPE TO DRAIN IF POSSIBLE.



**FOUNDATION WALL PENETRATION NOTES:**

- KEEP EDGE OF CORE AT LEAST 12" FROM TOP, BOTTOM, OR SIDE EDGES OF WALL, AND AT LEAST 12" FROM DOORS, WINDOWS, OR OTHER EXISTING PENETRATIONS.
- FOR MOST TYPES OF CONSTRUCTION, PROVIDE CORE AND DENSE HYDRAULIC CEMENT AS DESCRIBED ABOVE. FOR FIELDSTONE WALL, PROVIDE MORTAR OR PLASTER LEVELING SURFACE IF REQUIRED TO FACILITATE CORING.

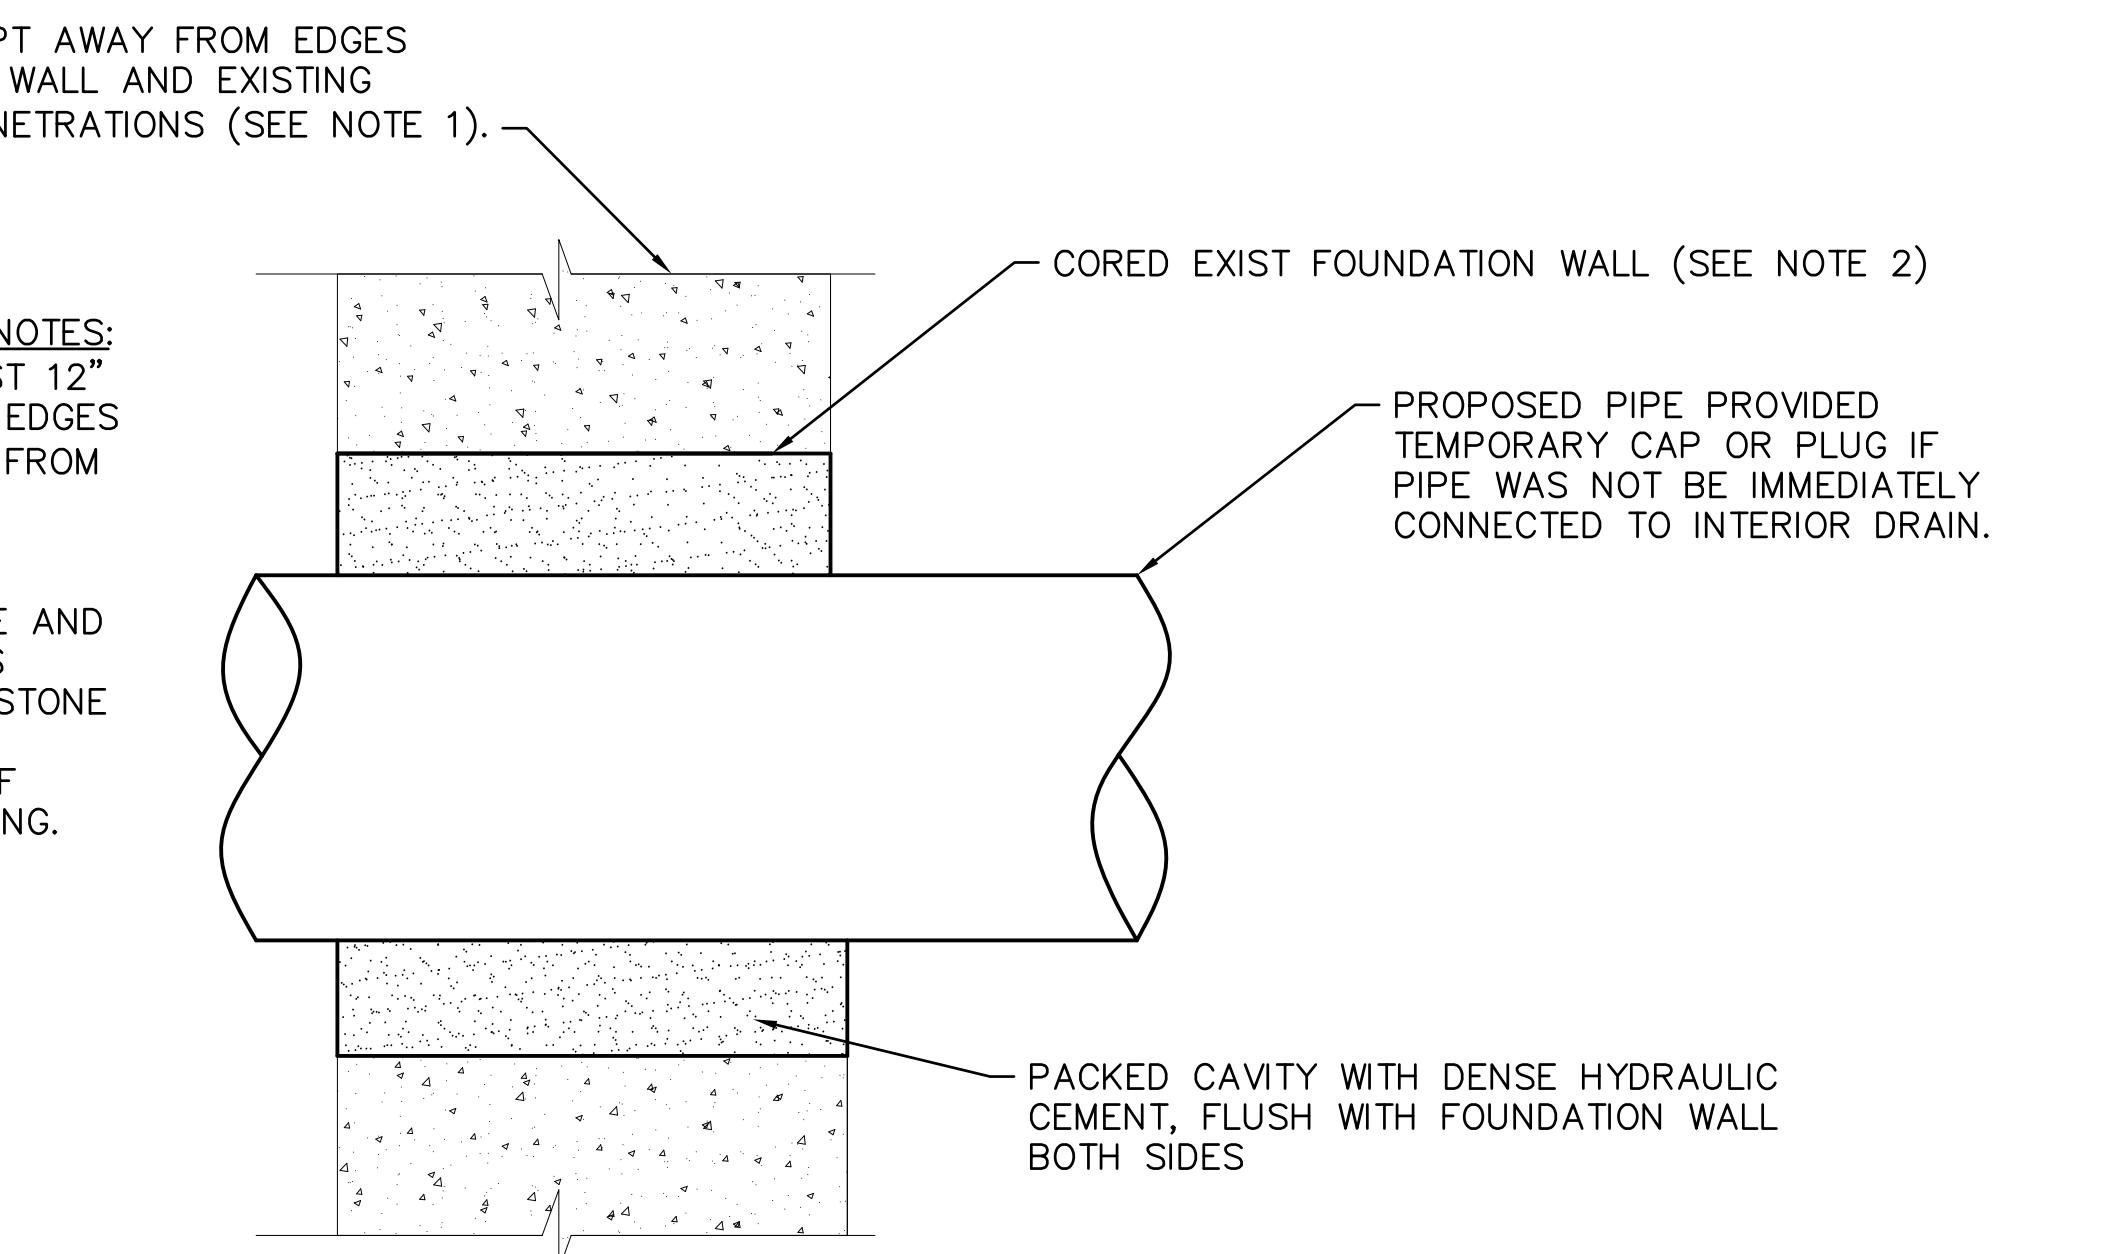

**FOUNDATION WALL PENETRATION**


NOT TO SCALE

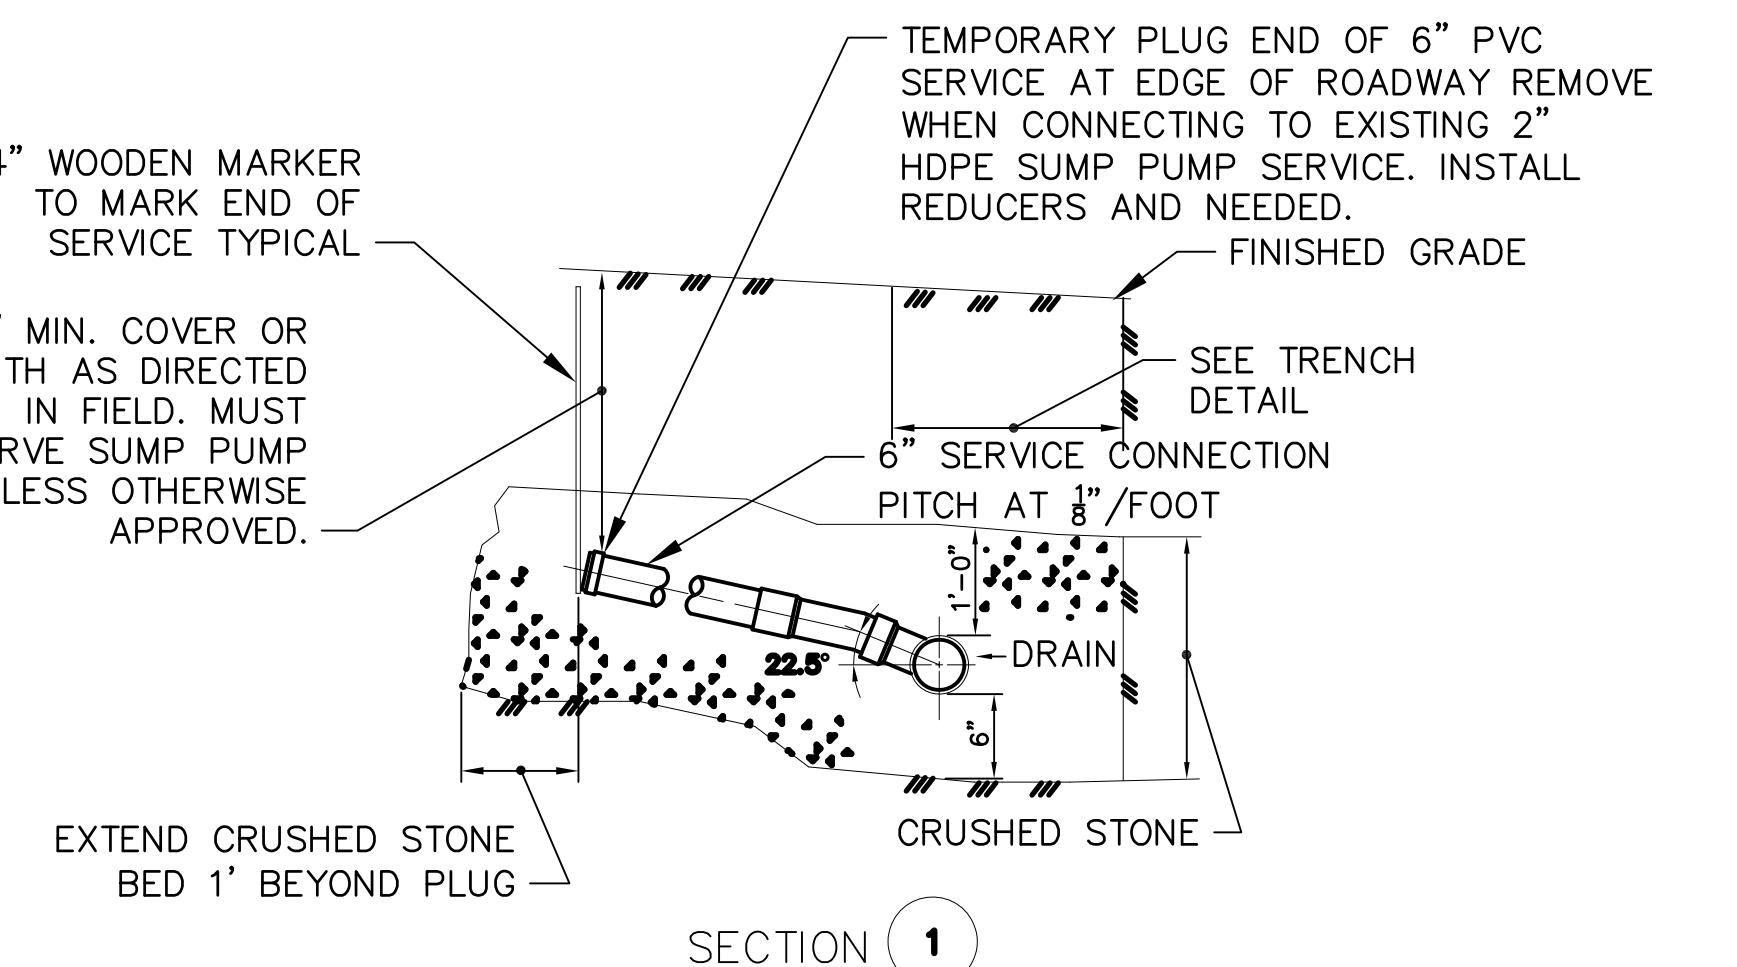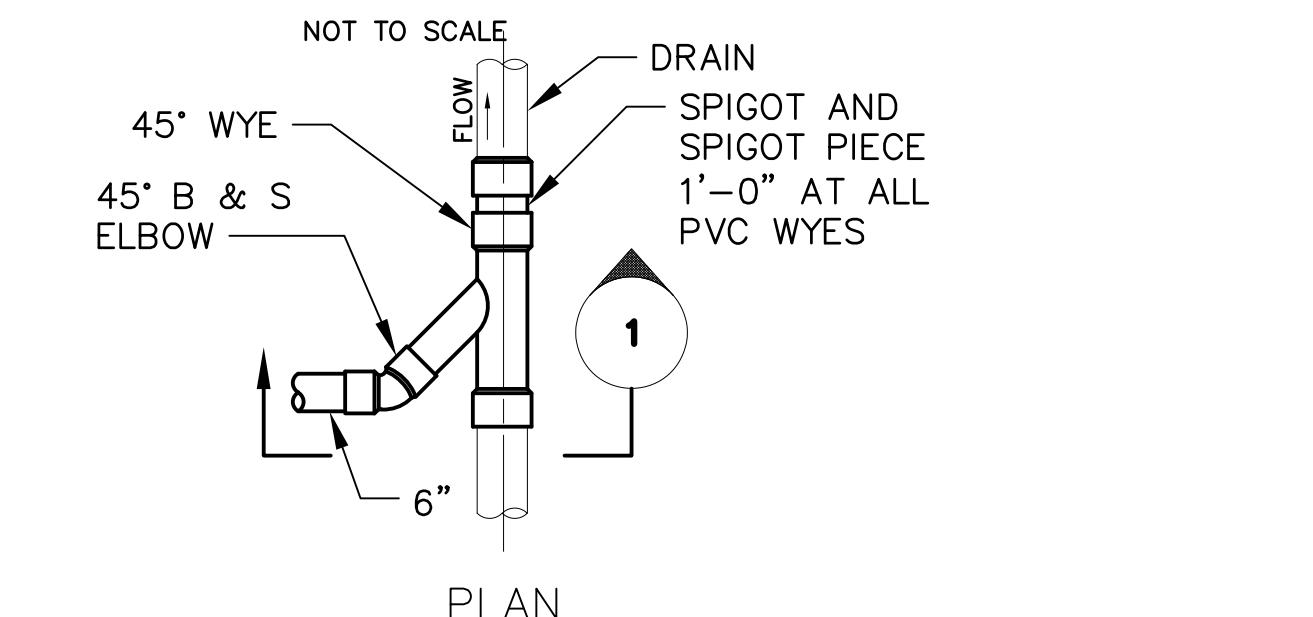

**DETAIL OF DRAIN AT NORMAL DEPTH**

NOT TO SCALE

TOWN OF BELMONT, MASSACHUSETTS  
PRIVATE SECTOR SUMP PUMP REMOVAL &  
SEWER SYSTEM REHABILITATION  
MWRA PROJECT NO. WRA-P11-04-3-1124 &  
MWRA PROJECT NO. WRA-P11-04-3-1160  
BELMONT, MASSACHUSETTS  
SUMP PUMP RELOCATION DETAILS

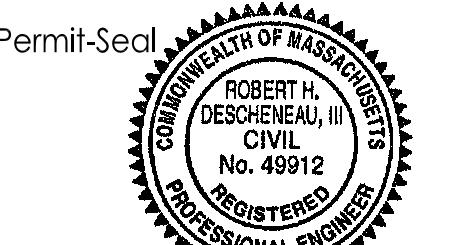

Permit-Seal

3-29-2021

Project Number: 195113362

File Name: C-501-C-503 DETAILS.DWG



AMD RHD RPB 21.03.31

Dwn. Chkd. Yr. Mm. DD

Drawing No. C-501

Revision Sheet


0 31 of

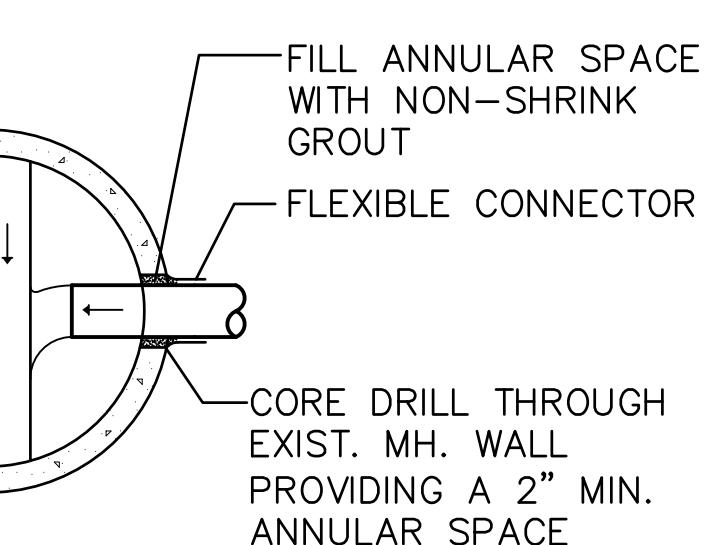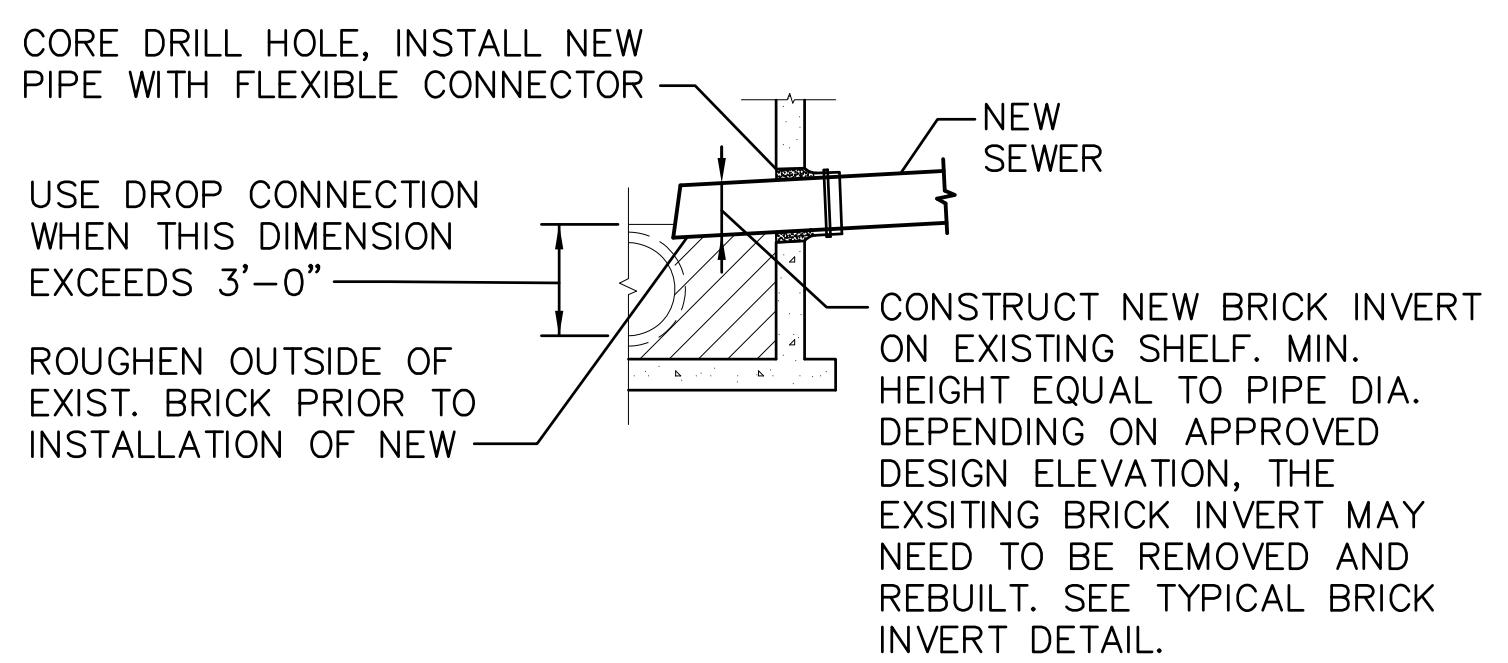

### SECTIONAL PLAN


## NEW SEWER CONNECTION TO EXISTING SEWER MANHOLE DETAIL

NOT TO SCALE

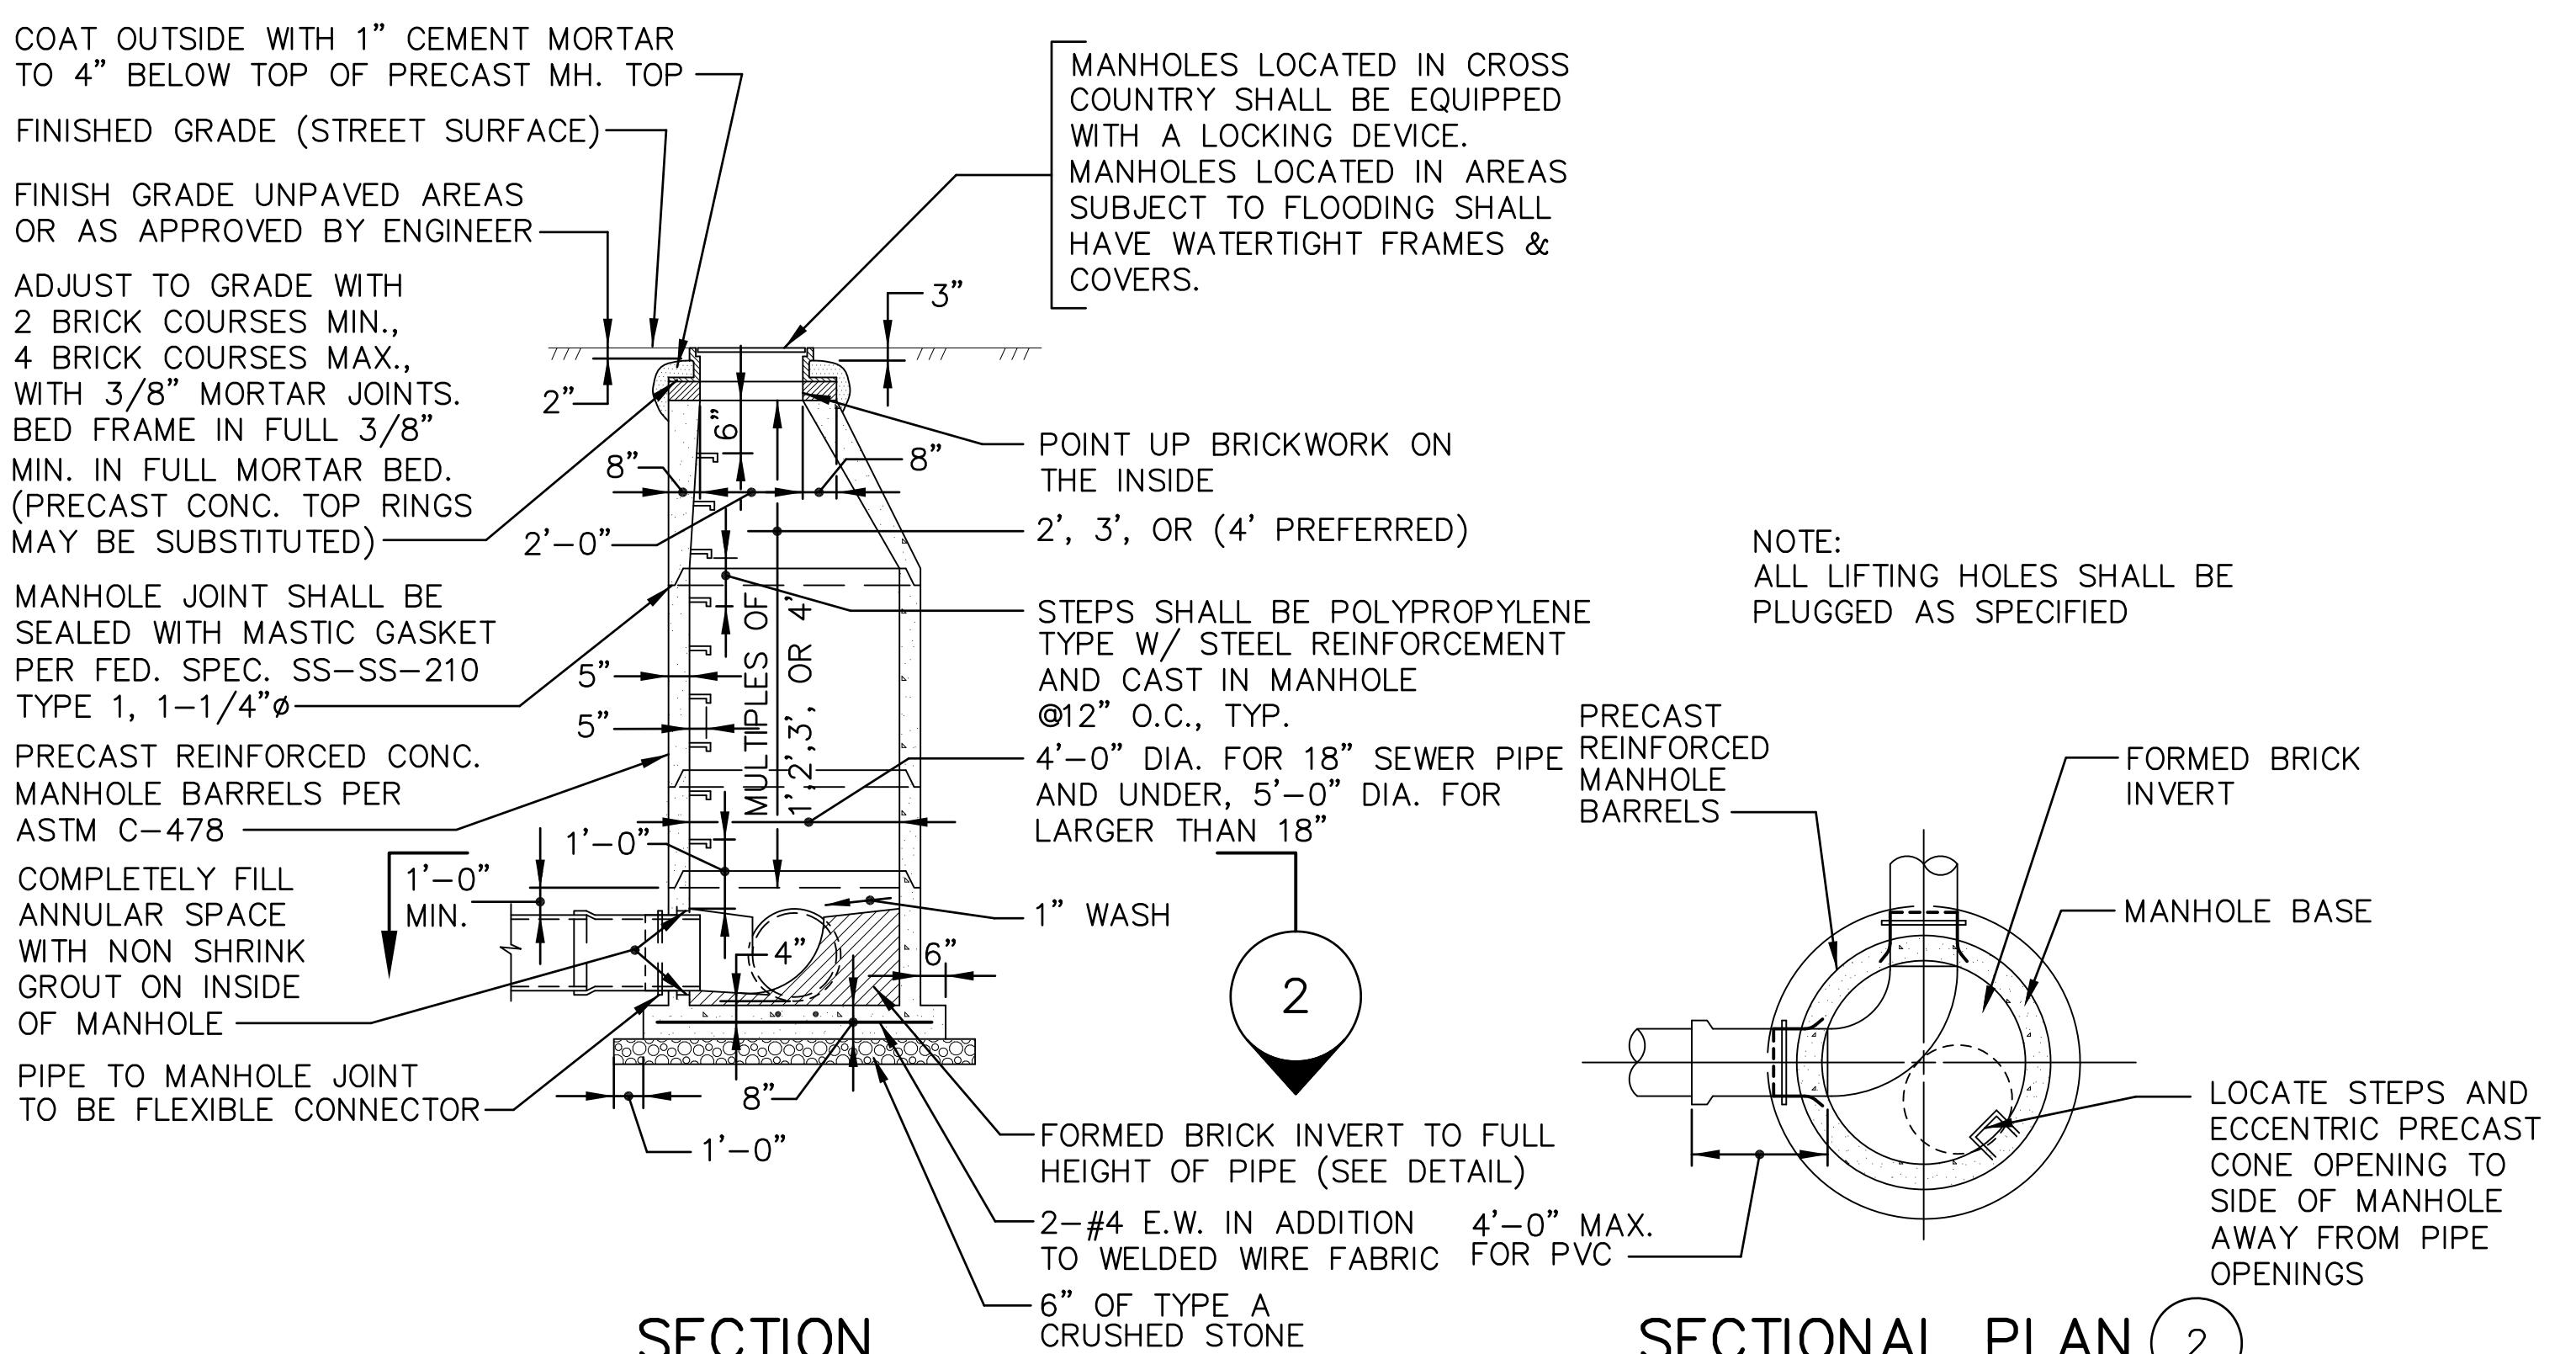

## PRECAST CONCRETE SEWER/DRAIN MANHOLE

NOT TO SCALE

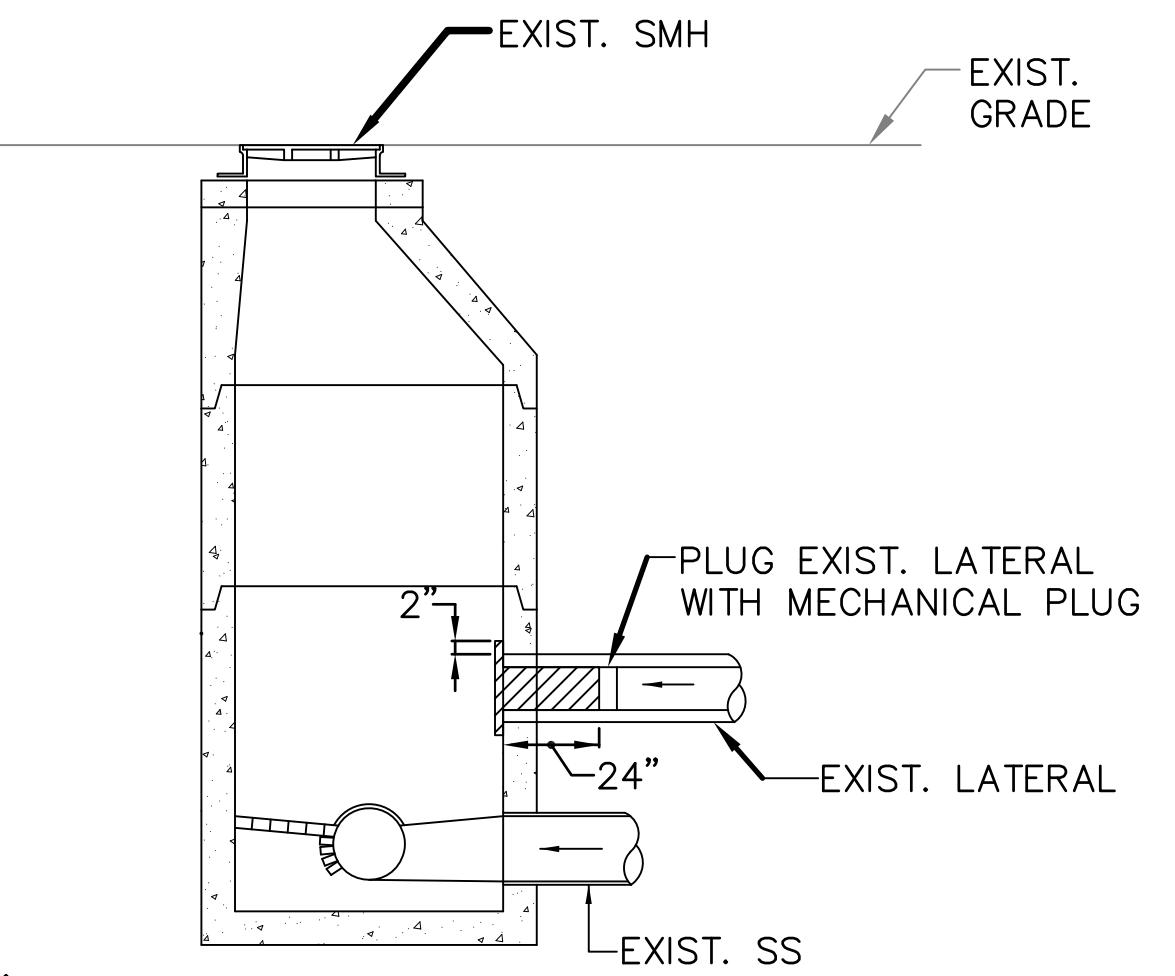


### NOTE:

1. THE CONTRACTOR SHALL INSTALL PLUGS A MINIMUM OF 24" INTO EXISTING SERVICE LATERAL, FILL WITH NON-SHRINK GROUT AND PARGE A MINIMUM OF 2" AROUND THE PLUGGED SERVICE LATERAL.

## TYPICAL DETAIL FOR SERVICE LATERAL PLUG AT SMH

NOT TO SCALE

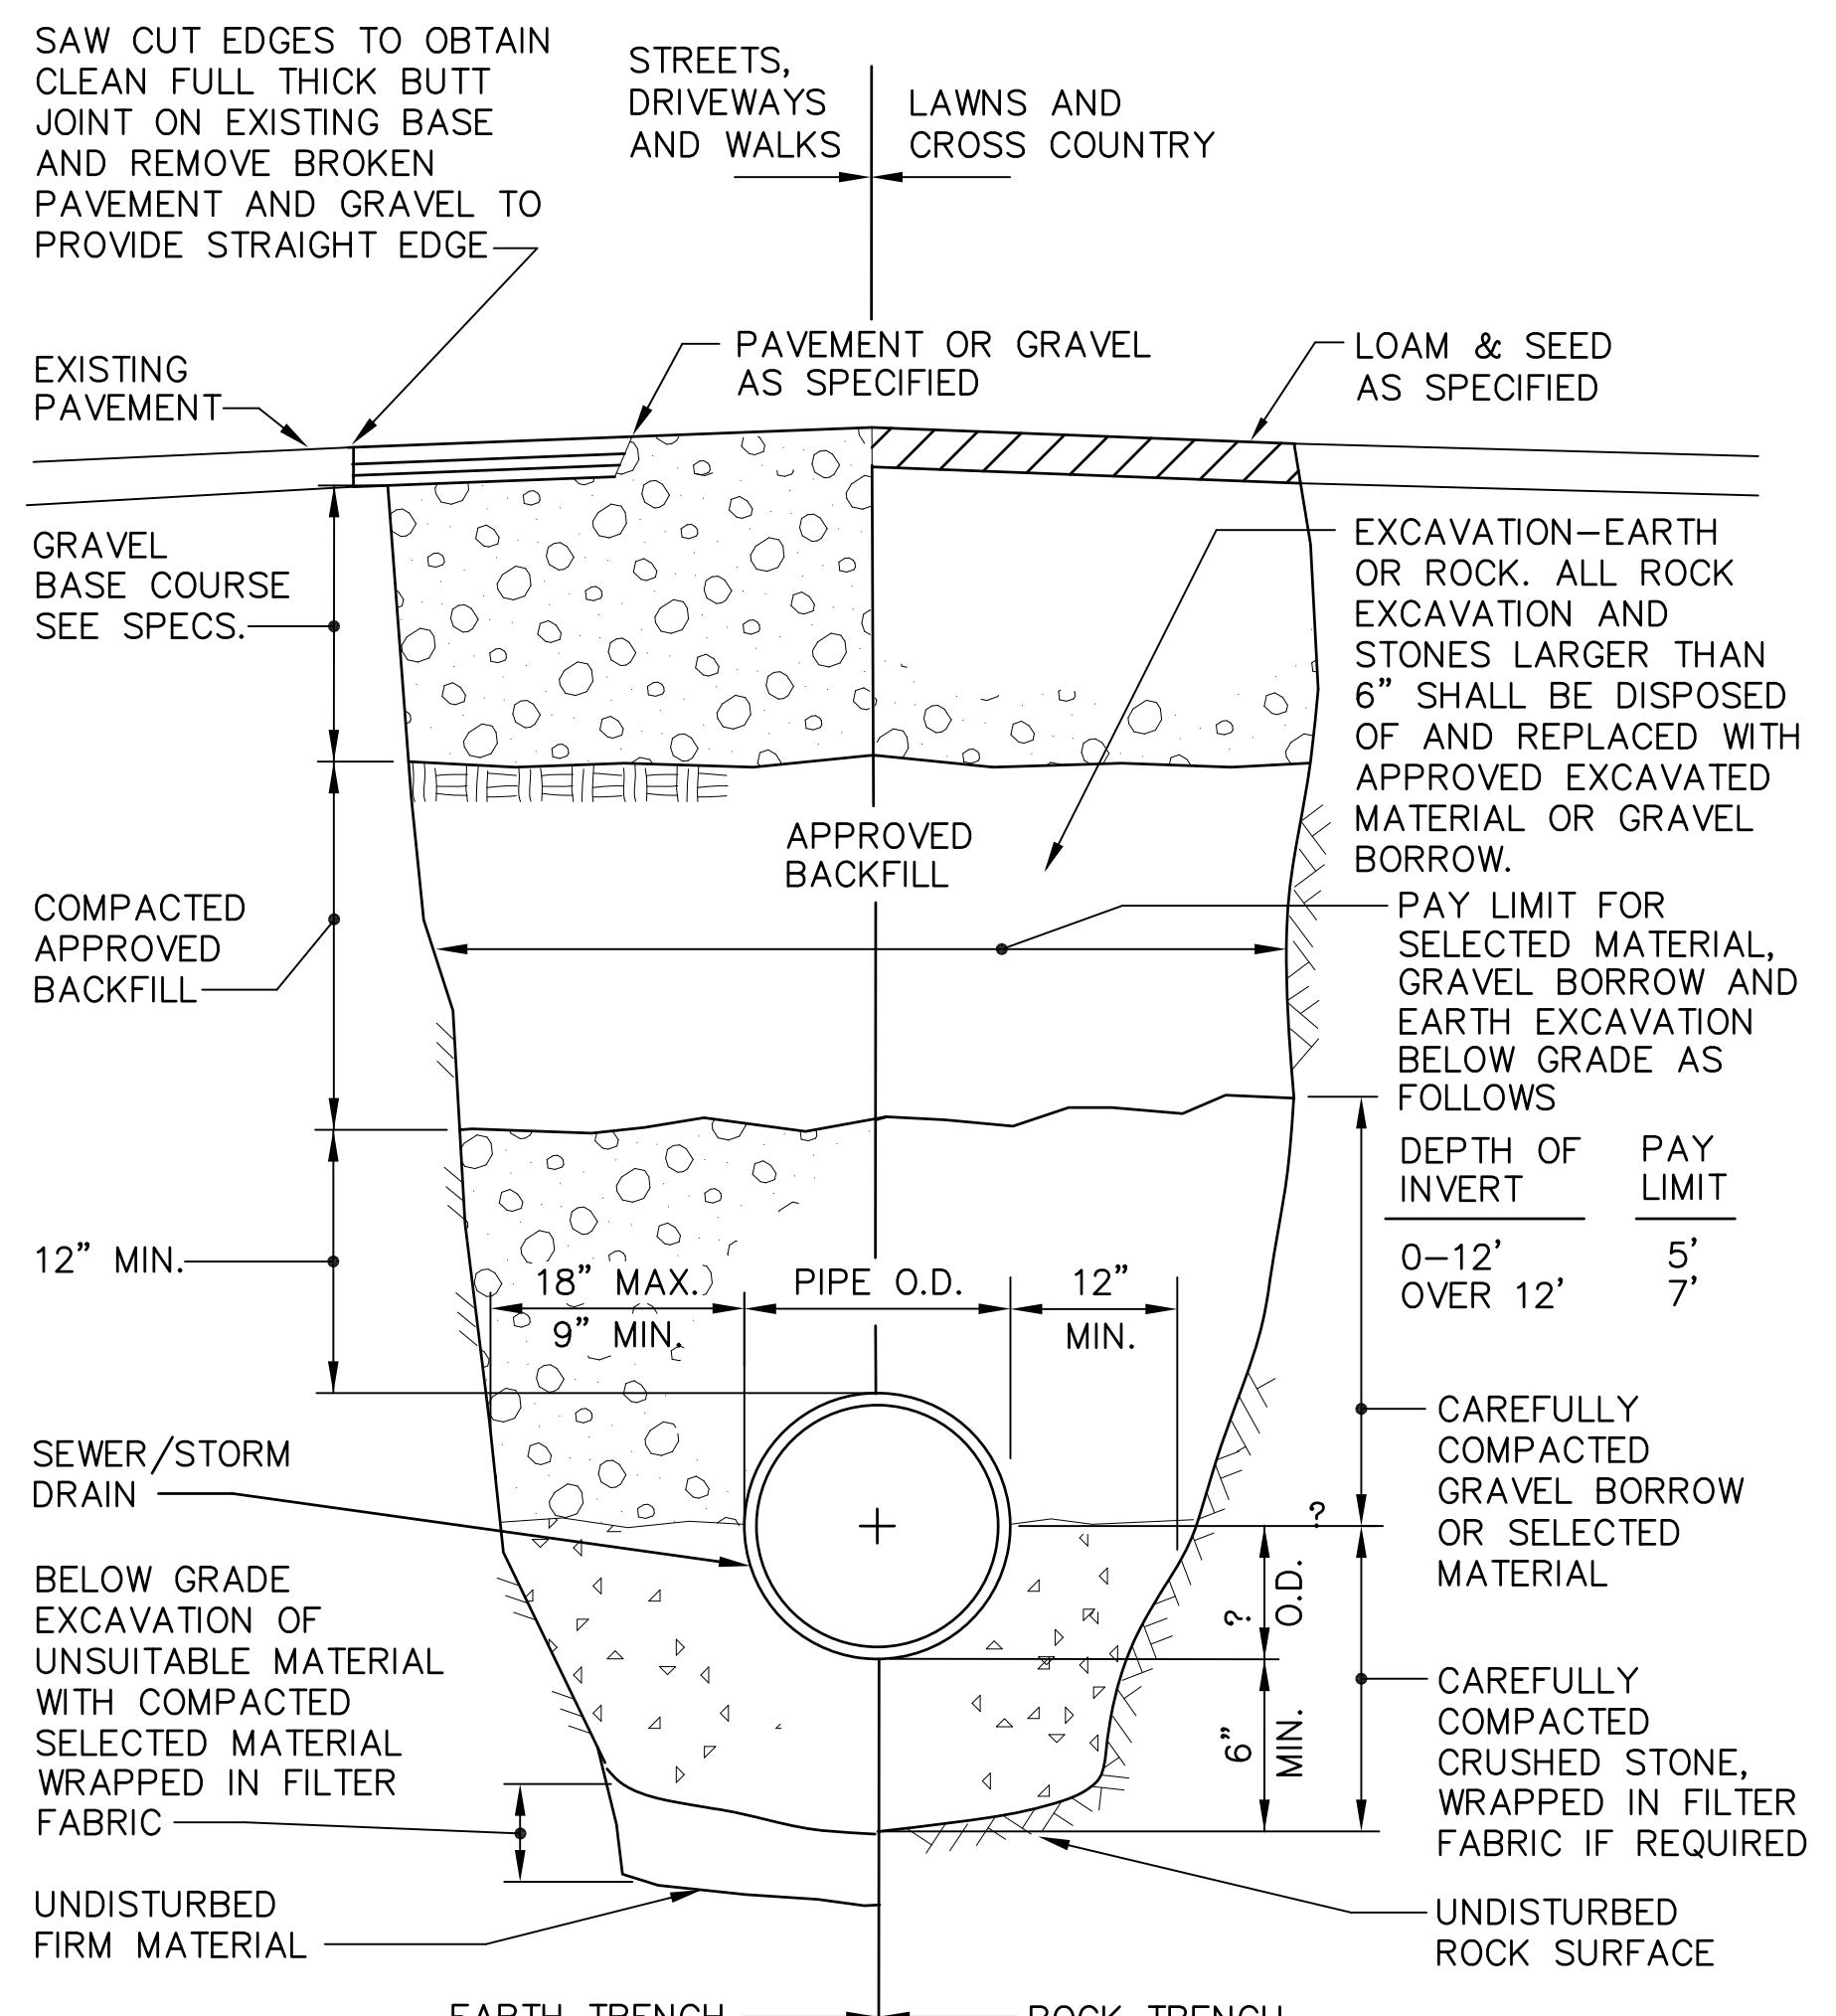


NOTE:  
REFER TO SPECIFICATIONS FOR BACKFILLING AND COMPACTION REQUIREMENTS.

### SECTION

## SEWER TRENCH-EARTH AND ROCK

NOT TO SCALE

TOWN OF BELMONT, MASSACHUSETTS  
PRIVATE SECTOR SUMP PUMP REMOVAL &  
SEWER SYSTEM REHABILITATION  
MWRA PROJECT NO. WRA-P11-04-3-1124 &  
MWRA PROJECT NO. WRA-P11-04-3-1160  
BELMONT, MASSACHUSETTS  
MISCELLANEOUS DETAILS 1 OF 2

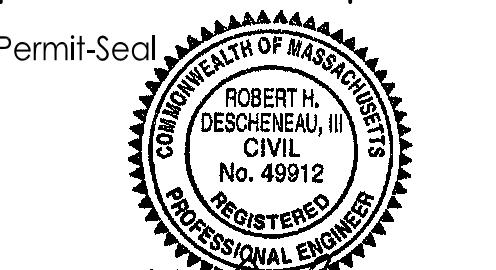


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File Name: C-501-C-503 DETAILS.DWG

AMD RHD RPB 21.03.31  
Dwn. Chkd. Disp. YY.MM.DD


Drawing No. C-502

Revision Sheet


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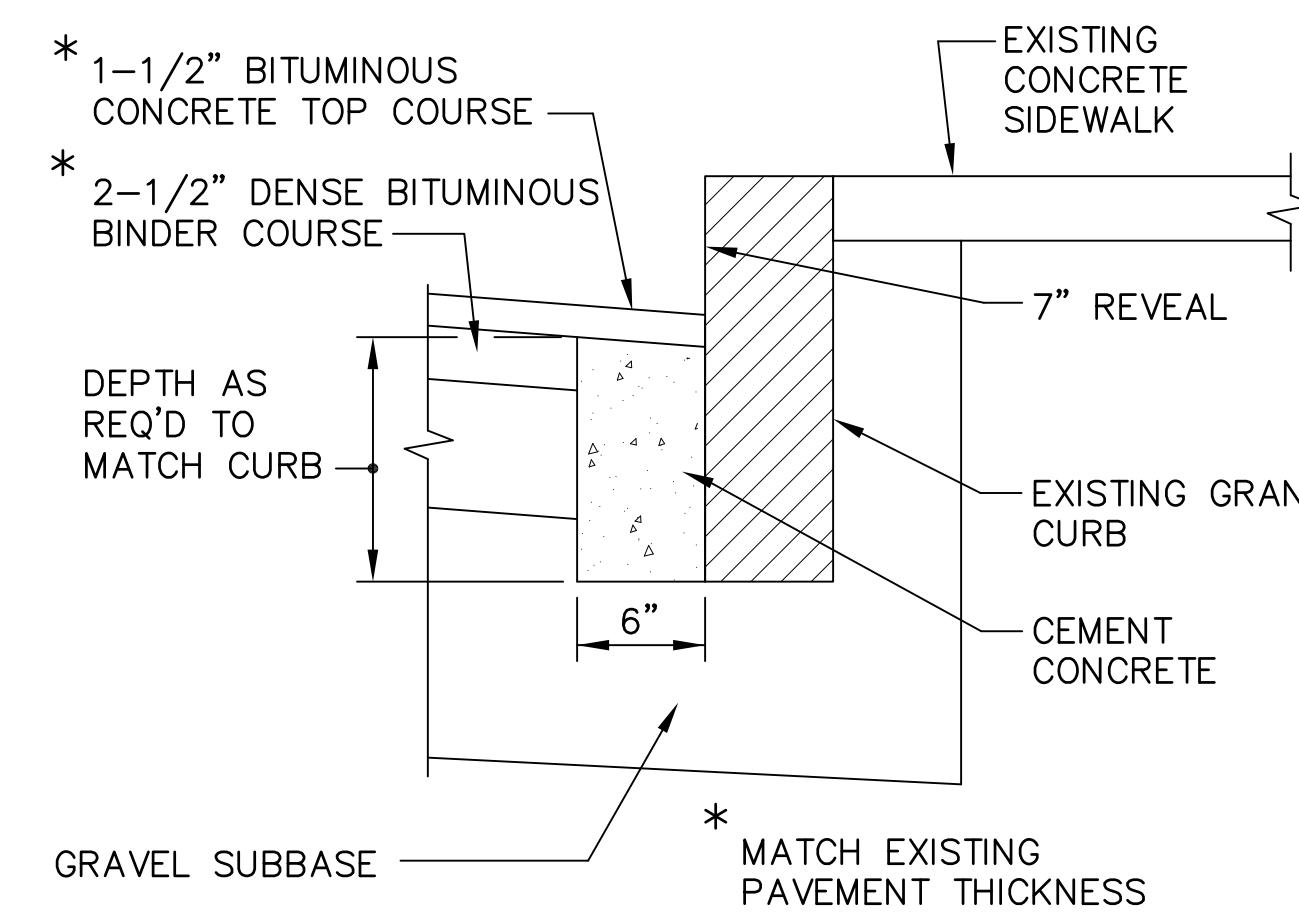
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BITUMINOUS CONCRETE CURB  
NOT TO SCALE

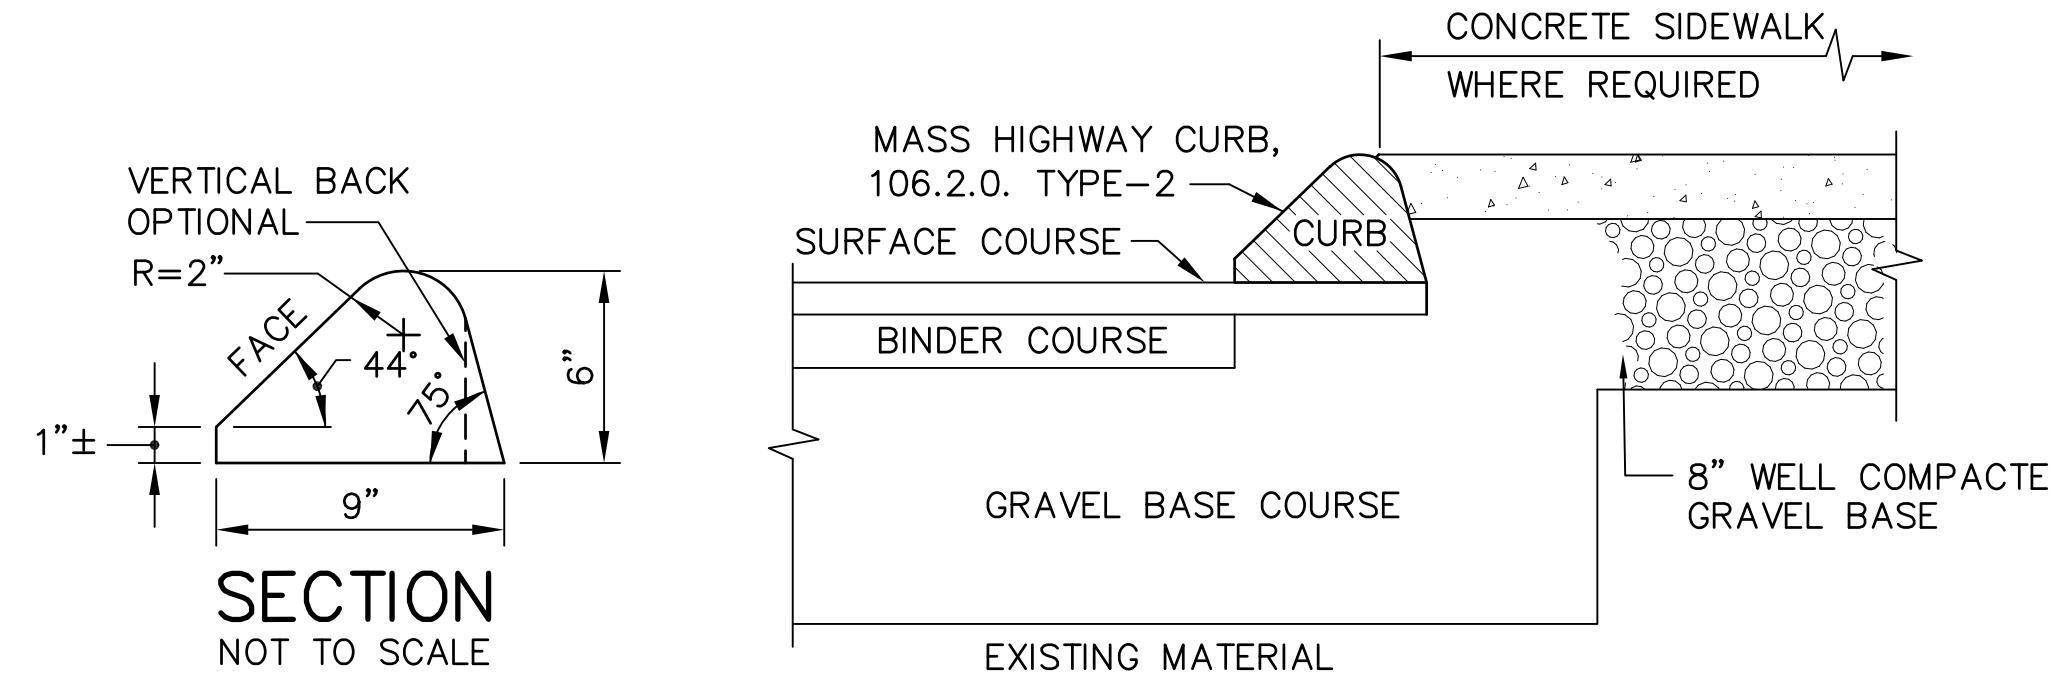


BITUMINOUS CONCRETE PAVEMENT  
SECTION WITHOUT CURB  
NOT TO SCALE

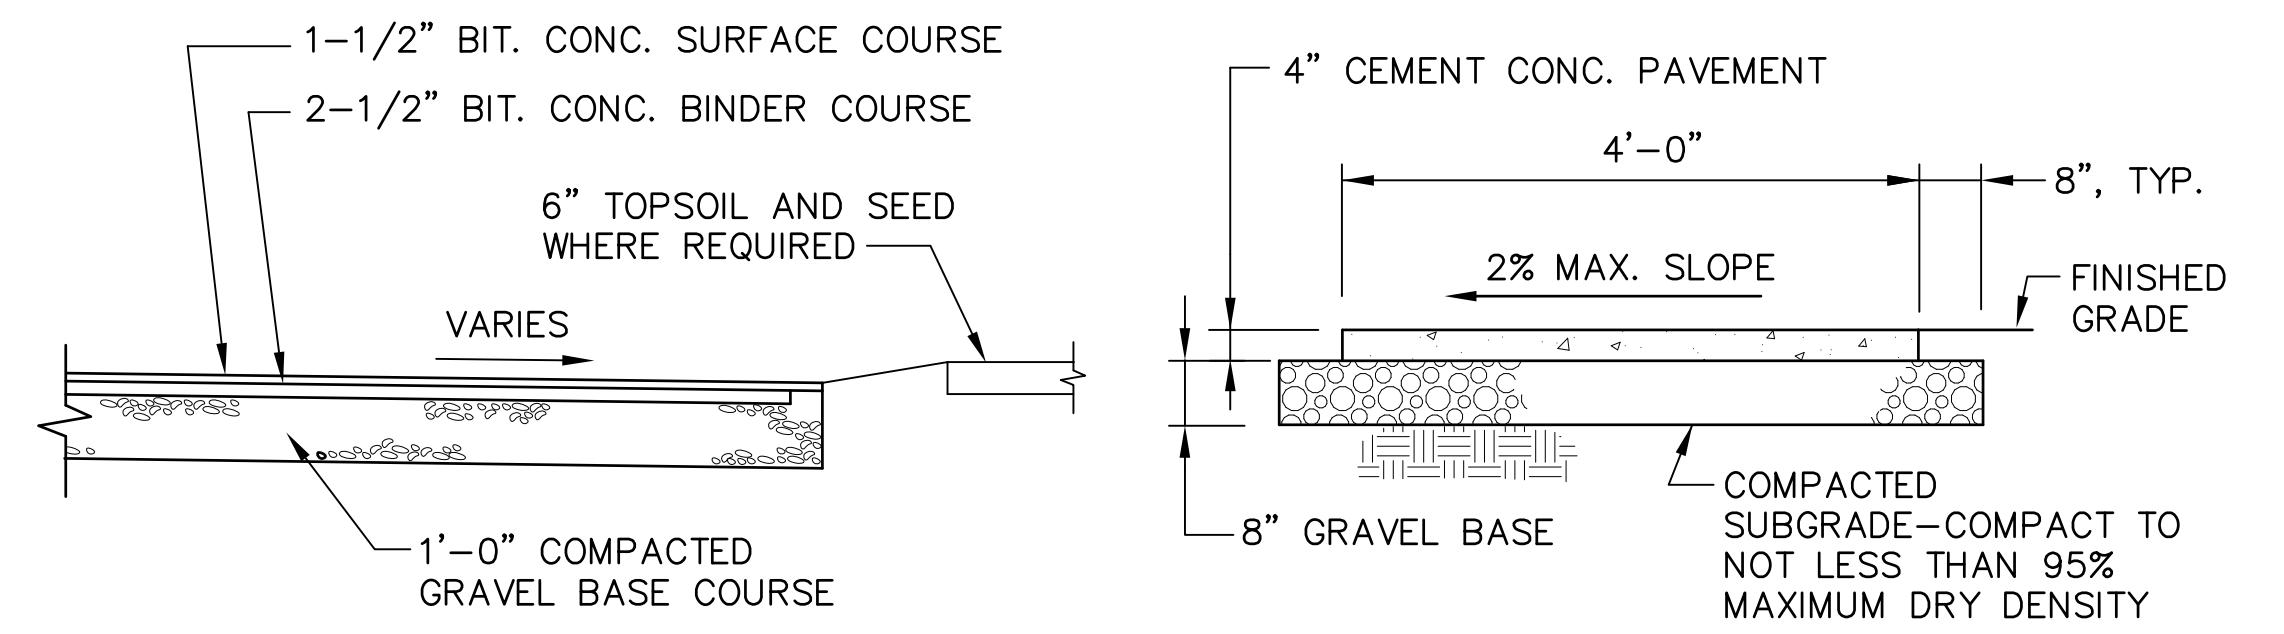


TYPICAL CEMENT  
CONCRETE WALK  
NOT TO SCALE

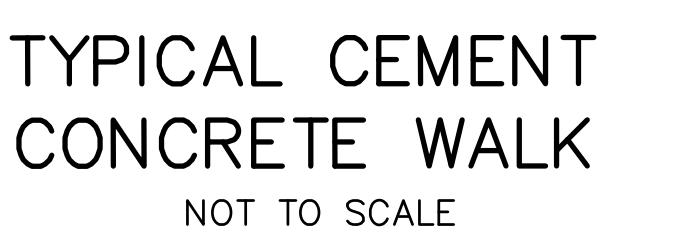

EXISTING GRANITE CURB RESETTING  
NOT TO SCALE

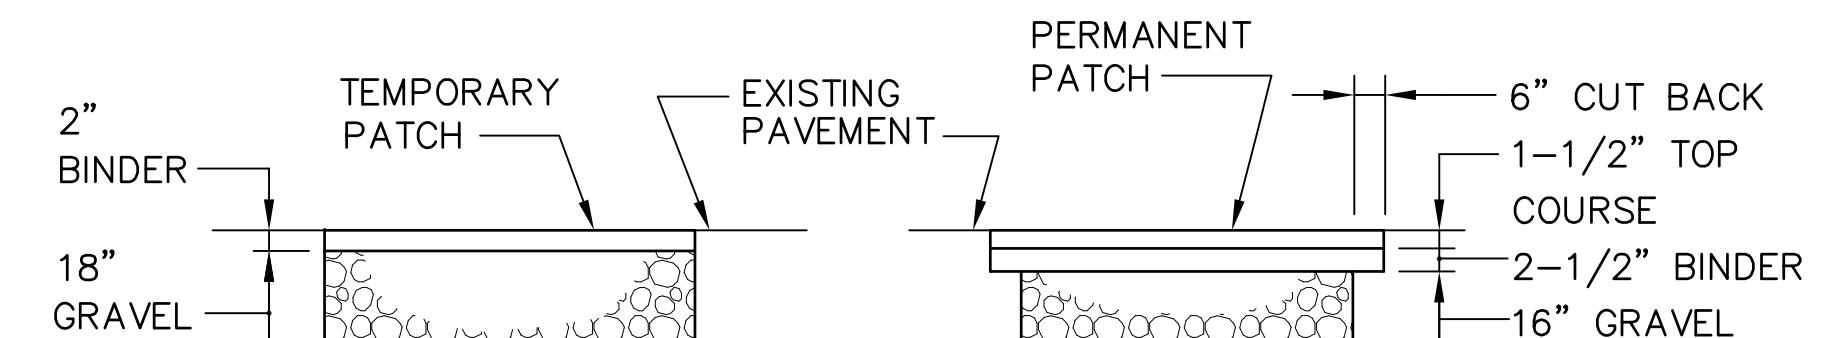


TEMPORARY PAVEMENT  
TOWN ROADS

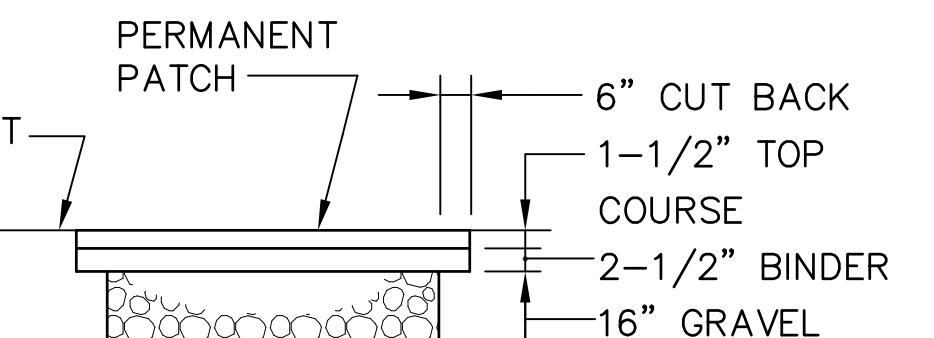


PERMANENT PAVEMENT  
TOWN ROADS

PAVEMENT TRENCH DETAILS  
NOT TO SCALE

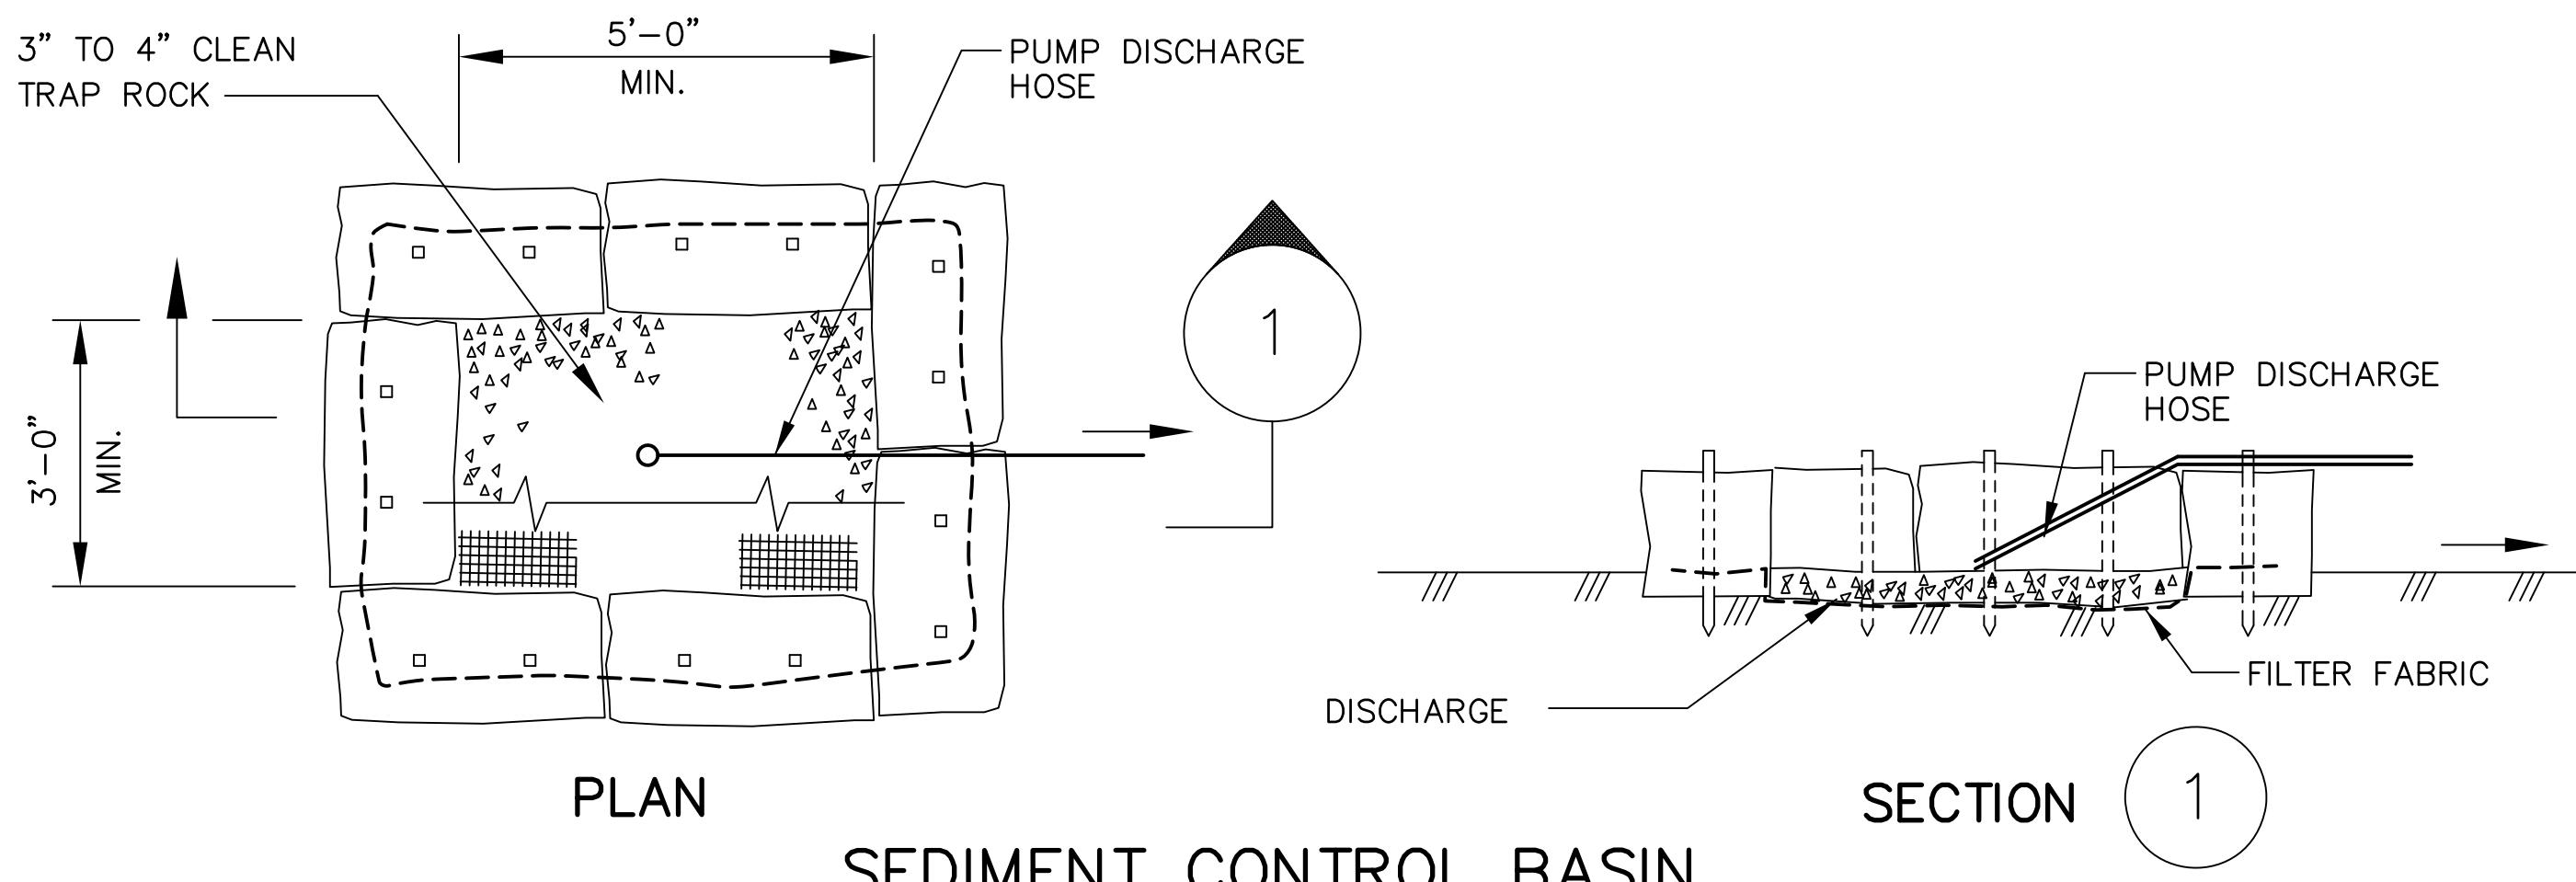


SEDIMENT CONTROL BASIN  
NOT TO SCALE

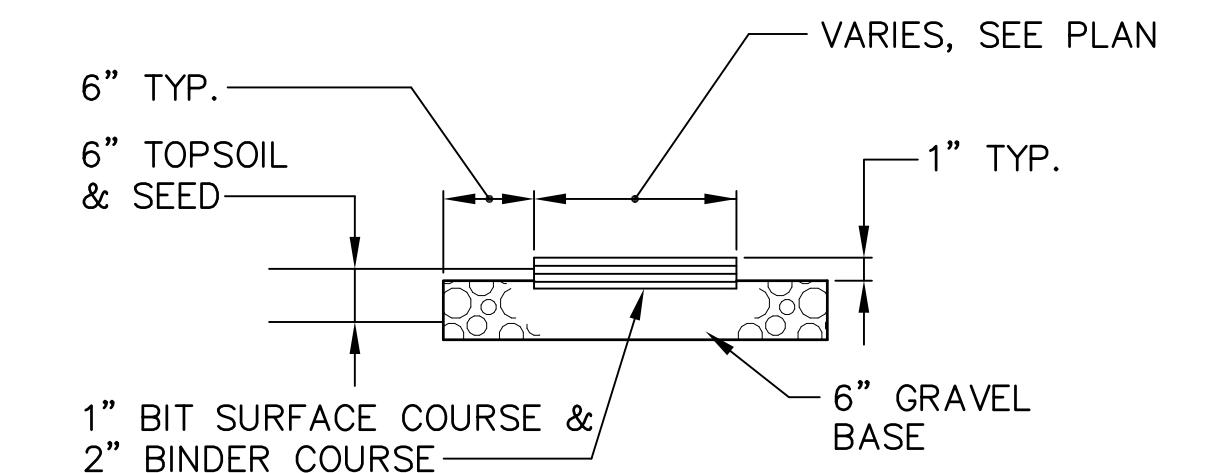

BITUMINOUS WALK  
NOT TO SCALE

TOWN OF BELMONT, MASSACHUSETTS  
PRIVATE SECTOR SUMP PUMP REMOVAL &  
SEWER SYSTEM REHABILITATION  
MWRA PROJECT NO. WRA-P11-04-3-1124 &  
MWRA PROJECT NO. WRA-P11-04-3-1160  
BELMONT, MASSACHUSETTS  
MISCELLANEOUS DETAILS 2 OF 2

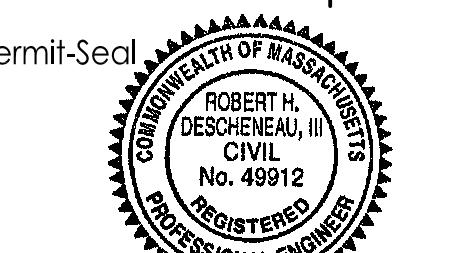

Project Number: 195113362

File Name: C-501-C-503 DETAILS.DWG

AMD RHD RPB 21.03.31  
Dwn. Chkd. Disp. YY.MM.DD

Drawing No. C-503

Revision Sheet

0 33 of

**Attachment 1**

**Sub-catchment Areas 8-2, 8-3, 8-4,  
8-5, 8-6, 10-1, 10-2, 11, 11A, 12, 13**

**Tributary Areas**

### Outfall 8-2 Tributary Sampling

Sampling Parameter	Unit	Threshold Value	Sampling Location, Sampling Date, and Measured Value																				8-2-4A		8-2-5		8-2-6		8-2-7	
			8-2				8-2-1				8-2-2				8-2-3				8-2-4				8-2-4A		8-2-5		8-2-6		8-2-7	
			Sample No.	Date	11/8/2016	7/27/2017	8/11/2017	11/9/2020	3/24/2021	7/26/2019	7/27/2017	8/11/2017	7/27/2017	7/26/2019	3/24/2021	7/27/2017	7/26/2019	3/24/2021	8/10/2017	7/26/2019	3/24/2021	10/17/2017	7/26/2019	3/24/2021	9/26/2017	9/26/2017	3/24/2021			
		MH #	23D045	23D045	23D045	23D045	23D045	23D045	23D045	24D016	24D016	23D028	23D028	23D028	23D028	23D028	23D028	24D040	24D040	24D040	24D040	24D040	24D040	24D040	23D028.1	19D017	19D013			
		Location Description	Concord ave at Goden from Goden	Concord ave at Goden from Goden	Concord ave at Goden from Goden	Concord ave at Goden from Goden	Concord ave at Goden from Goden	Concord ave at Goden from Goden	Concord ave at Goden from Goden	Common and Orchard from Common 4" pipe	Common and Orchard from Common 4" pipe	Orchard and Goden from Orchard	Orchard in front of school from 15" on Orchard St	Orchard in front of school from 15" on Orchard St	Orchard in front of school from 15" on Orchard St	Orchard in front of school from 15" on Orchard St	Orchard in front of school from 15" on Orchard St	Orchard in front of school from Easement	Orchard in front of school from Easement	Orchard St at Glendale Rd from Easement	Farimont and Goden. Sample sheet does not indicate sample location. GIS indicates NS	From Upstream Goden St at Hillcrest Rd								
E. Coli	MPN/100mL	235	1950	1100	1300	19,700	100	<100	>20,000	>20,000	10,500	300	<100	900	<100	900	<100	<100	>20,000	<100	700	ND	200	DRY	N.T.	N.T.	<100			
Ammonia (NH <sub>3</sub> )	mg/L	0.5	2	0.3	0.1	0.25	N.T.	N.T.	6	5	3	N.T.	N.T.	0.1	N.T.	N.T.	6	N.T.	N.T.	0.1	N.T.	3	0	N.T.						
Surfactants	ppm	0.25	0.25	N.T.	0.25	N.T.	N.T.	N.T.	0.75	N.T.	N.T.	N.T.	N.T.	N.T.	0.4	N.T.	N.T.	N.T.	N.T.	N.T.	N.T.	N.T.	0.5	N.T.	N.T.					
Enterococcus	/100mL	300	N.T.	N.T.	N.T.	N.T.	N.T.	N.T.	N.T.	N.T.	N.T.	N.T.	N.T.	N.T.	N.T.	N.T.	N.T.	N.T.	N.T.	N.T.	N.T.	N.T.	N.T.	N.T.	N.T.					

Most Recent Reporting Period

ND Sampled - None Detected  
 N.T. Not Tested  
 NS Not Sampled - Very little flow or wet but no flow  
 DRY System was dry

Outfall 8-3 Tributary Sampling							
Sampling Parameter	Unit	Threshold Value	Sampling Location, Sampling Date, and Measured Value				
			Sample No.	8-3			
			Date	11/8/2016	11/9/2020	3/24/2021	
			MH #	Culvert	Culvert	Culvert	
			Location Description	Concord Ave @ Library	Concord Ave @ Library	Concord Ave @ Library	
E. Coli	MPN/100mL	235		ND	500	1,400	
Ammonia (NH <sub>3</sub> )	mg/L	0.5		0.1	0.25	0.4	
Surfactants	ppm	0.25		0.15	N.T.	N.T.	
Enterococcus	/100mL			ND	N.T.	N.T.	

Most Recent Reporting Period

ND Sampled - None Detected

N.T. Not Tested

NS Not Sampled - Very little flow or wet but no flow

DRY System was dry

				Outfall 8-4 Tributary Sampling						
Sampling Parameter	Unit	Threshold Value		Sampling Location, Sampling Date, and Measured Value						
				Sample No.	8-4			8-4-1		
				Date	11/8/2016	11/9/2020	3/24/2021	3/24/2021		
			MH #	Culvert	Culvert	Culvert	31D007			
			Location Description	Common St near Royal Rd	Common St near Royal Rd	Common St near Royal Rd	Royal Rd and Common St from Concord Ave across Railroad			
E. Coli	MPN/100mL	235		ND	22,000	1,900	500			
Ammonia (NH <sub>3</sub> )	mg/L	0.5		0.3	0	N.T.	0.1			
Surfactants	ppm	0.25		0.2	N.T.	N.T.	N.T.			
Enterococcus	/100mL			ND	N.T.	N.T.	N.T.			

Most Recent Reporting Period

Sampled - None Detected

ND

N.T.

NS Not Sampled - Very little flow or wet but no flow

DRY System was dry



## **Sub-catchment 8-6 - Tributary Sampling**

### Most Recent Reporting Period

ND Sampled - None Detected  
N.T. Not Tested

N.T. Not Tested  
NS Not Sampled

NS Not Sampled - very little flow or wet but no flow  
DRY System was dry

#### Systematic Survey

### Sub-catchment 10-1 - Tributary Sampling

Sampling Parameter	Unit	Threshold Value	Sample No.	Sampling Location, Sampling Date, and Measured Value																	
				10-1				10-1-1			10-1-2			10-1-3		10-1-4		10-1-5	10-1-6	10-1-7	10-1-8
			Date	11/8/2016	7/27/2017	11/10/2020	3/23/2021	7/27/2017	12/16/2020	7/27/2017	12/16/2020	3/23/2021	12/16/2020	12/16/2020	12/16/2020	3/23/2021	3/23/2021	3/23/2021	3/23/2021	3/23/2021	3/23/2021
			MH #	Open Culvert	Open Culvert	Open Culvert	Open Culvert	48D036	48D036	34D087	34D087	34D087	54D025 Belmont	48D024	Open Culvert	N/A	N/A	Open Culvert	34D095		
			Location Description	Claflin St north of Alexander Ave	Claflin St north of Alexander Ave	Claflin St north of Alexander Ave	Claflin St north of Alexander Ave	Clifton and Pleasant	Clifton and Pleasant	Claflin St and Alexander Ave from Clifton (South)	Claflin St and Alexander Ave from Clifton (South)	Claflin St and Alexander Ave from Clifton (South)	Hill School Athletic Center Parking Lot from Marsh St	85 Clifton St from East (Garfield Rd)	Winn's Brook at Hickory Ln and Clifton St	Hickory Lane at Clifton St from Clifton	Flectcher Rd at Clifton St from Clifton	Winn's Brook at Flectcher Rd and Clifton St	Downstream on Leonard St		
E. Coli	MPN/100mL	235		1,250	ND	7,900	<100	500	2,100	100	10,600	<100	<100	2,600	1,500	500	<100	<100	<100		
Ammonia (NH <sub>3</sub> )	mg/L	0.5		0	0	0.25	0.3	0.5	0	N.T.	2	0.1	0	0	0	0.25	0	0	0.1		
Surfactants	ppm	0.25		0.25	N.T.	N.T.	N.T.	N.T.	N.T.	N.T.	N.T.	N.T.	N.T.	N.T.	N.T.	N.T.	N.T.	N.T.	N.T.		
Enterococcus	/100mL			450	N.T.	N.T.	N.T.	N.T.	N.T.	N.T.	N.T.	N.T.	N.T.	N.T.	N.T.	N.T.	N.T.	N.T.	N.T.		

Most Recent Reporting Period

ND Sampled - None Detected

N.T. Not Tested

NS Not Sampled - Very little flow or wet but no flow

DRY System was dry

Sampling Parameter	Unit	Threshold Value	Outfall 10 Tributary Sampling																									
			Sampling Location, Sampling Date, and Measured Value																									
			Sample No.	OF-10-2	10-2-1	10-2-2	10-2-3	10-2-3A	10-2-4	10-2-5	10-2-6	10-2-7	10-2-8	10-2-9	N/A	N/A	N/A	10-2-3	10-2-9	10-2-10	N/A	N/A						
Date	9/1/2017	11/8/2018	7/26/2019	9/1/2017	9/1/2017	7/26/2019	3/23/2021	7/26/2019	3/23/2021	9/1/2017	9/1/2017	9/27/2017	11/9/2018	3/23/2021	9/27/2017	11/9/2018	3/23/2021	9/27/2017	9/27/2017	9/28/2017	9/28/2017	9/28/2017	9/28/2017	9/28/2017				
MH #	Culvert	Culvert	Culvert	37D036	44D046	37D055	37D055	37D055	43D014	43D034	37D042	37D042	37D042	37D042	37D042	37D042	37D042	37D042	45D011	45D015	44D024	44D011	38D006	44D027	44D005			
Location Description	Winn Brook Outfall (downstream of 10-2)	Winn Brook Outfall (downstream of 10-2)	Brighton at Larch from Brighton	Brighton at Albert from Waterhouse	Waterhouse at Westlund from Waterhouse	Chilton at Munroe near Cross from between 86 and 93 Munroe	Waterhouse from Holt (#37 direction)	Waterhouse from Holt (#37 direction)	Waterhouse and Holt from Waterhouse	Albert Ave from Pilgrim Rd and Plymooth Ave	Hurley @ Middlecot from 11 & 17	Slater @ Newcastle from Rd from Newcastle	29 & 25 Hwy from Hwy	15 Chilton Street upstream pipe	Hurley	Cowdin	None Detected											
E. Coli	MPN/100mL	235	200	1,000	100	ND	800	>20,000	>30,000	2,600	8,700	ND	>20,000	2,700	11,400	1,300	<100	>30,000	100	N.T.	N.T.	N.T.	200	150	N.T.	N.T.		
Ammonia (NH <sub>3</sub> )	mg/L	0.5	0	0.5	N.T.	0	4	N.T.	3	N.T.	6	0.25	N.T.	4	0.4	6	0.35	0	N.T.	0.25	0.3	0.1	0.15	0	0.35	0.65	0.35	0.1
Surfactants	ppm	0.25	N.T.	N.T.	0.1	0.25	0.25	N.T.	N.T.	N.T.	N.T.	0.1	N.T.	N.T.	N.T.	N.T.	N.T.	N.T.	N.T.	N.T.	N.T.	N.T.	N.T.	N.T.	N.T.	N.T.	N.T.	

Most Recent Reporting Period

ND = None Detected

N.T. = Not Tested

NS = Not Sampled - Very little flow or wet but no flow

DRY = System was dry

		Outfall 11 Tributary Sampling					
Sampling Parameter	Unit	Threshold Value		Sampling Location, Sampling Date, and Measured Value			
			Sample No.	OF-11			
			Date	11/8/2016	6/23/2017	11/9/2020	3/23/2021
			MH #	41D045	41D045	41D045	41D045
E. Coli	MPN/100mL	235		>10,000	13,800	1,200	4,900
Ammonia (NH <sub>3</sub> )	mg/L	0.5		0.35	0.6	0.25	1
Surfactants	ppm	0.25		0.3	0.5	N.T.	N.T.
Enterococcus	/100mL			2700	N.T.	N.T.	N.T.

Most Recent Reporting Period

ND Sampled - None Detected

N.T. Not Tested

NS Not Sampled - Very little flow or wet but no flow

DRY System was dry

				Outfall 11A Tributary Sampling				
Sampling Parameter	Unit	Threshold Value		Sampling Location, Sampling Date, and Measured Value				
			Sample No.	OF-11A				11A-1
			Date	11/8/2016	6/23/2017	11/10/2020	3/23/2021	3/23/2021
			MH #	41D045	41D045	41D045	41D045	41D045
E. Coli	MPN/100mL	235		8,600	>20,000	2,600	<100	300
Ammonia (NH <sub>3</sub> )	mg/L	0.5		3	>6	0.6	1	1
Surfactants	ppm	0.25		0.5	0.6	N.T.	N.T.	N.T.
Enterococcus	/100mL			3200	N.T.	N.T.	N.T.	N.T.

Most Recent Reporting Period

ND Sampled - None Detected

N.T. Not Tested

NS Not Sampled - Very little flow or wet but no flow

DRY System was dry

				Outfall 12 Tributary Sampling										
Sampling Parameter	Unit	Threshold Value		Sampling Location, Sampling Date, and Measured Value										
			Sample No.	OF-12					12-1			12-2		12-3
			Date	11/8/2016	6/23/2017	11/10/2020	12/16/2020	3/24/2021	6/23/2017	11/10/2020	3/24/2021	6/23/2017	3/24/2021	6/23/2017
		MH #	41D037	41D037	41D037	41D037	41D037	41D019	41D019	41D019	41D017	41D017	41D011	
		Location Description	115 Oliver Rd	115 Oliver Rd	115 Oliver Rd	115 Oliver Rd	115 Oliver Rd	Gilmore and Oliver from Oliver	99 Oliver Rd	Gilmore and Oliver from Oliver	Oliver and Little Pond Rd from Little Pond	Oliver and Little Pond Rd from Little Pond	Little Pond Road from 321 Cross St	
E. Coli	MPN/100mL	235		>10,000	16,000	200	700	100	1,300	200	100	3,000	200	ND
Ammonia (NH <sub>3</sub> )	mg/L	0.5		0.35	4	0.25	0	0	0.25	0	0	0.3	0	0
Surfactants	ppm	0.25		0.25	0.4	N.T.	N.T.	N.T.	0.4	N.T.	N.T.	0.4	N.T.	0.75
Enterococcus	/100mL			300	N.T.	N.T.	N.T.	N.T.	N.T.	N.T.	N.T.	N.T.	N.T.	N.T.

Most Recent Reporting Period

ND Sampled - None Detected

N.T. Not Tested

NS Not Sampled - Very little flow or wet but no flow

DRY System was dry

		Outfall 13 Tributary Sampling					
Sampling Parameter	Unit	Threshold Value		Sampling Location, Sampling Date, and Measured Value			
			Sample No.	OF-13			
			Date	11/8/2016	11/10/2020	3/24/2021	
E. Coli	MPN/100mL	235	MH #	41D057	41D057	41D057	
Ammonia (NH <sub>3</sub> )	mg/L	0.5	Location Description	Garrison Rd @ Oliver Rd	Garrison Rd @ Oliver Rd	Garrison Rd @ Oliver Rd	
Surfactants	ppm	0.25		0.25	N.T.	N.T.	
Enterococcus	/100mL			50	N.T.	N.T.	

Most Recent Reporting Period

ND Sampled - None Detected

N.T. Not Tested

NS Not Sampled - Very little flow or wet but no flow

DRY System was dry